

Reserved for permit stamp

105 South Jackson St., Suite 800  
Salt Lake City, Utah 84102  
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**Olson Kundig**

project: **SOMMET BLANC**  
8900 Marsac Ave (B2, East Parcel)  
Park City, Utah 84300



**Aspen Group USA, LLC**  
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Park City, Utah 84098

**Pool Consultant**  
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2696 N University Ave., Suite 200  
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**Landscape Architect**  
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**Specifications Writer**  
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**Code Consultant**  
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**Fire Protection Engineer**  
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**Vertical Transportation Consultant**  
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**Structural Engineer**  
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**Lighting Designer**  
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**Building Envelope Consultant**  
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**MEP Engineer**  
WSP USA  
1001 Fourth Ave., Suite 3100  
Seattle, WA 98154

principal architect \_\_\_\_\_  
project manager \_\_\_\_\_  
drawn by \_\_\_\_\_  
checked by: Checker  
job no. \_\_\_\_\_  
date 11/18/2022

revisions:  
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\_\_\_\_\_  
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no. date by

ISSUE FOR CONSTRUCTION  
11/18/2022

ENLARGED MECHANICAL PLAN - UNIT A


M2.4.A

**SHEET NOTES:**


- A. CONFIRM EXACT LOCATION OF ALL WALL DEVICES WITH ARCHITECTURAL ELEVATIONS.
- B. CONFIRM ALL CEILING AND WALL ACCESS DOORS WITH ARCHITECTURAL ROOPS AND WALL ELEVATIONS.
- C. REFER TO M3-2A-01 THROUGH M3-2C-R FOR RADIANT FLOOR HWYR PIPING ROUTING AND SIZING.
- D. PROVIDE 1-INCH ACOUSTIC LINING FOR ENTIRETY OF MAIN DUCT RUN OFF FAN COIL.
- E. ALL RESIDENTIAL TOILET EXHAUST, DRYER EXHAUST, AND KITCHEN RANGE HOOD EXHAUST TO BE PART OF A SUB-DUCT EXHAUST SYSTEM.
- F. ROUTE 3/4" CONDENSATE DRAINS FROM FCUS TO NEAREST SINK TAILPIECE.


**NUMBERED NOTES:**

- 1. 5"Ø CONCENTRIC FLUE TO GAS FIREPLACE. PROVIDE ORTAL IN-LINE 180 POWERVENT (120V/15A).
- 2. RANGE HOOD EXHAUST FAN TO BE INTEGRAL WITH RANGE SPECIFIED BY THE ARCHITECT. INTERLOCK CONTROL WITH MUA-A.
- 3. ELECTRICAL RADIANT FLOOR TO BE PROVIDED IN MASTER BATHROOM. SEE ELECTRICAL DRAWINGS.
- 4. PROVIDE APRILAIRE 800 HUMIDIFIER. ASSUME 1/2" CW, 3/4" CD TO NEAREST SINK TAILPIECE, AND 120V ELECTRICAL CONNECTION.
- 5. 2" RETURN AIR SLOT.
- 6. PROVIDE 208(16A)1 CONNECTION FOR APRILAIRE 800 HUMIDIFIER DOWNSTREAM OF FAN COIL UNIT. REFER TO ELECTRICAL DRAWINGS FOR DETAIL. THIS IS AN OWNER OPTION. CONFIRM WITH OWNER AND ARCHITECT PRIOR TO PROVIDING HUMIDIFIER.
- 7. PROVIDE 120(16A)1 CONNECTION FOR APRILAIRE 800 HUMIDIFIER DOWNSTREAM OF FAN COIL UNIT. REFER TO ELECTRICAL DRAWINGS FOR DETAIL. THIS IS AN OWNER OPTION. CONFIRM WITH OWNER AND ARCHITECT PRIOR TO PROVIDING HUMIDIFIER.

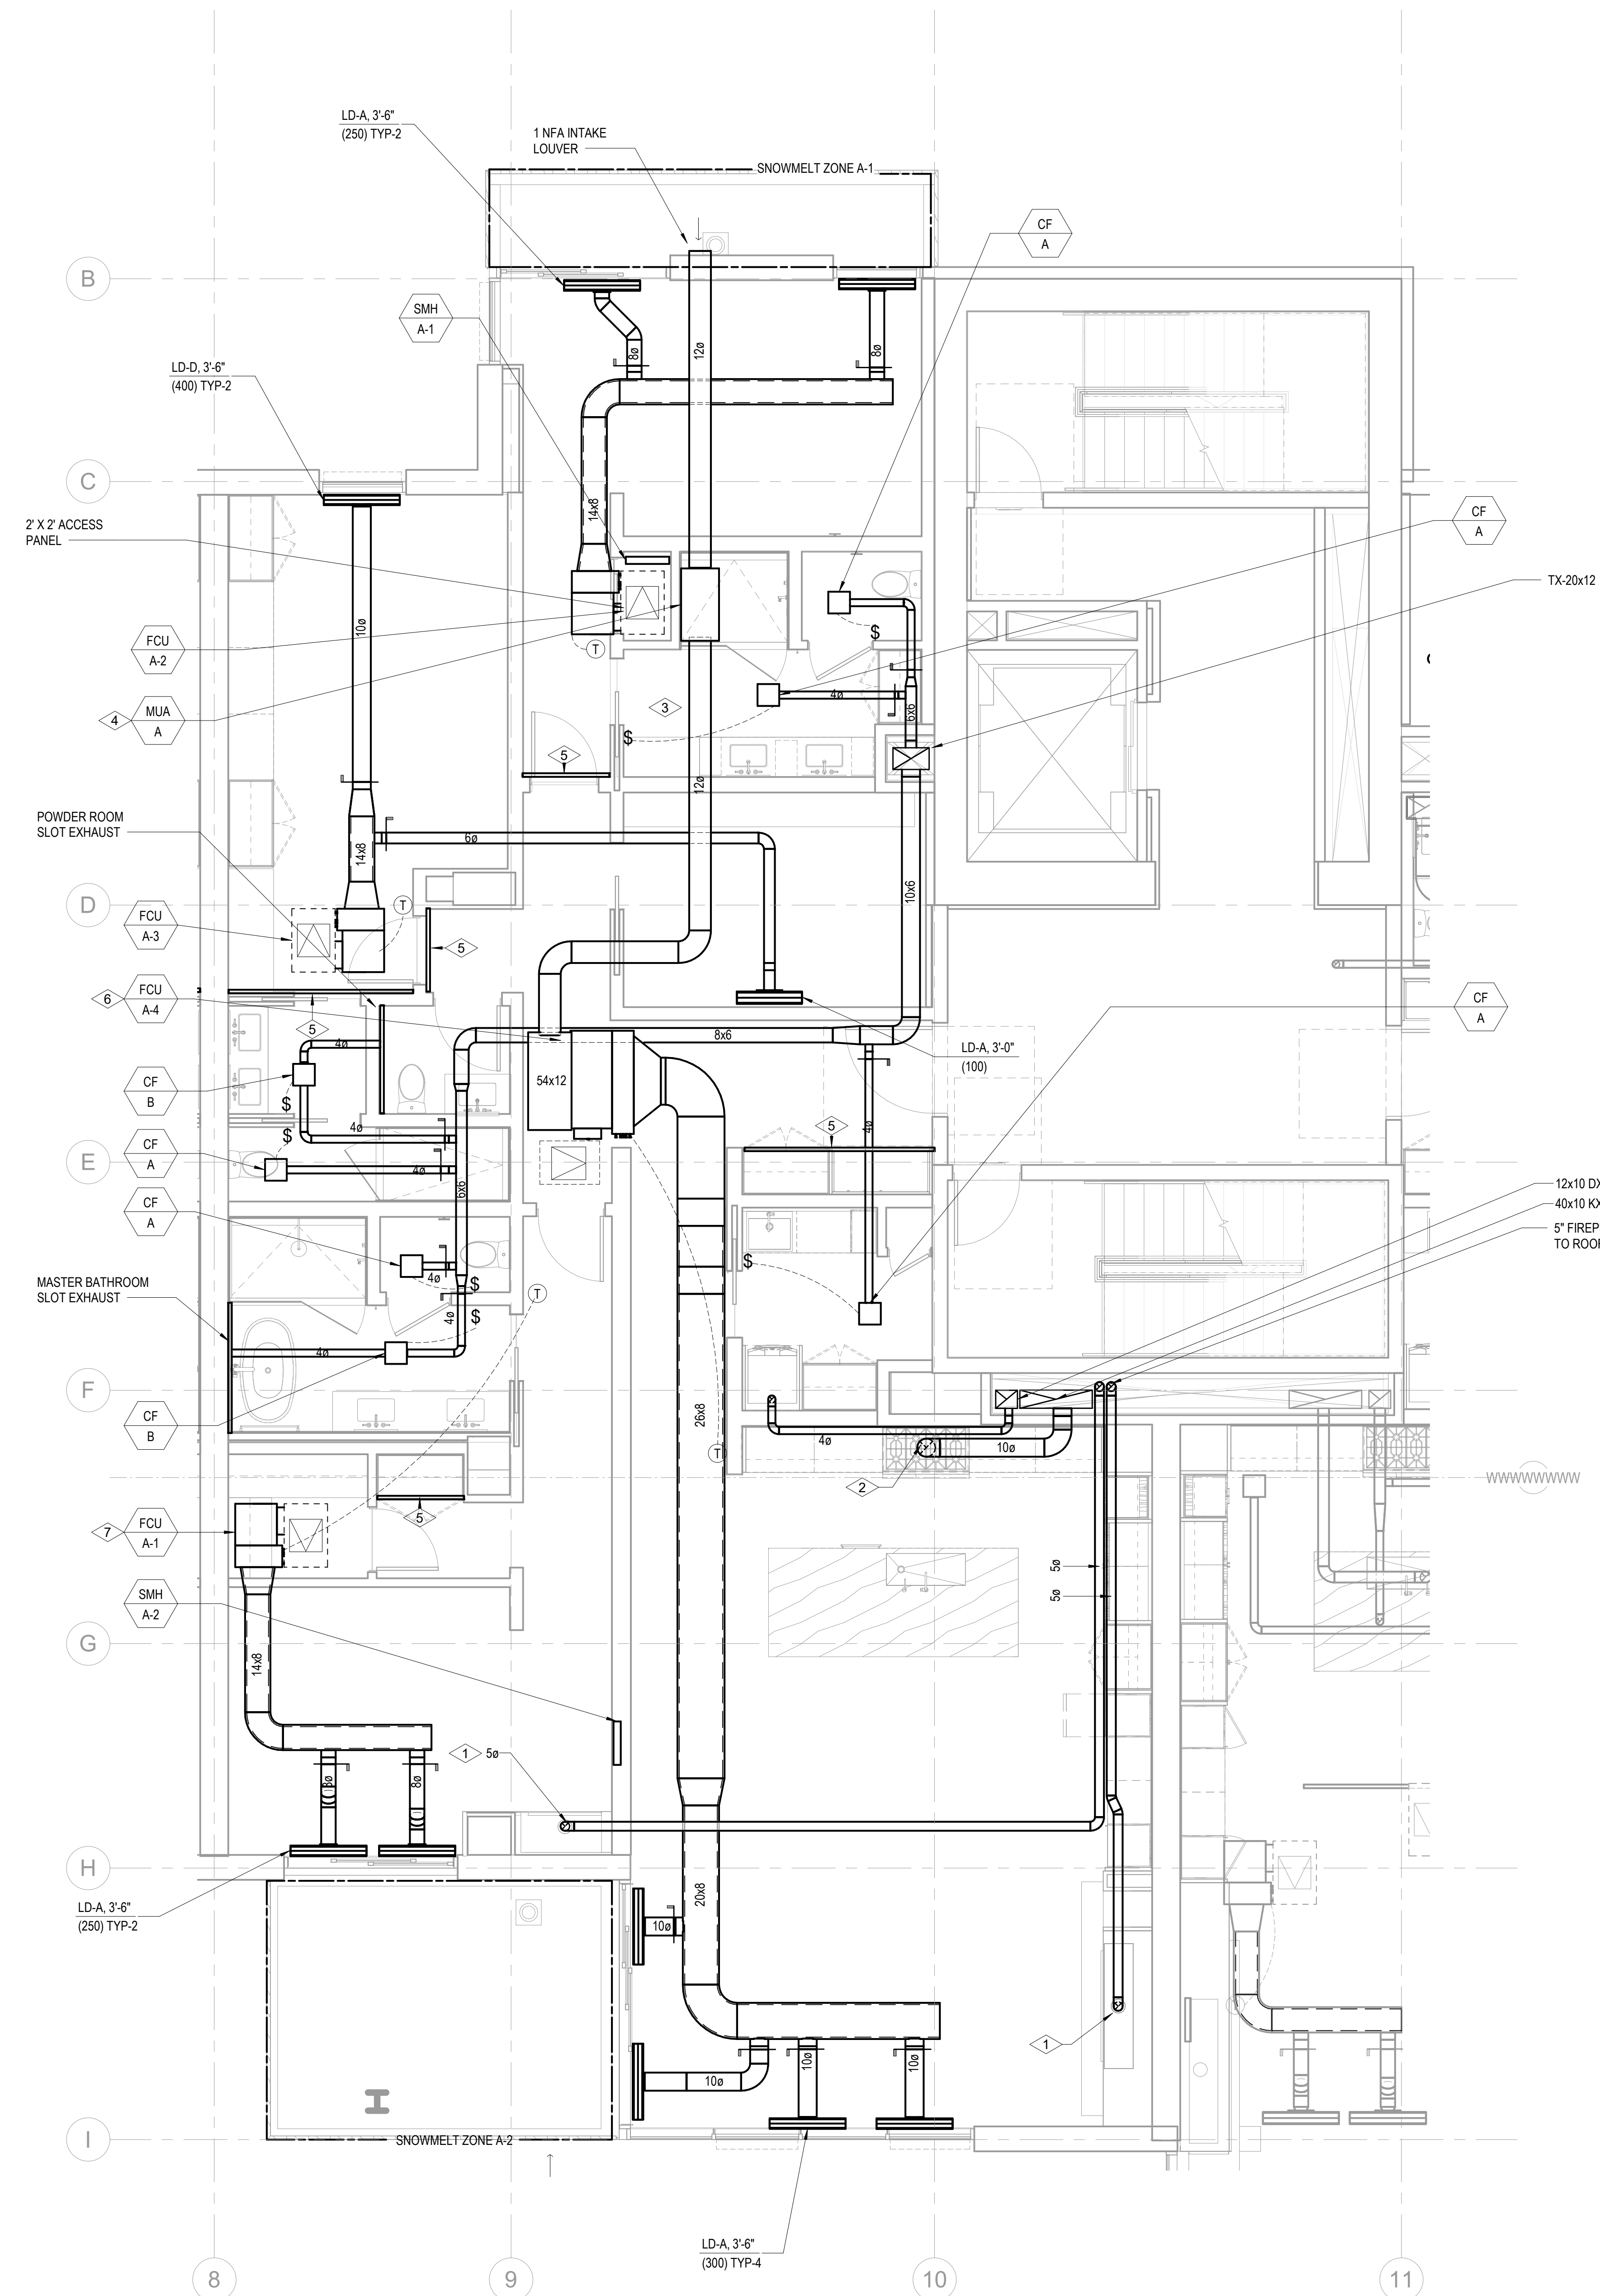

1 TOWER A/B - MECHANICAL PLAN - UNIT A  
SCALE: 1/4" = 1'-0"

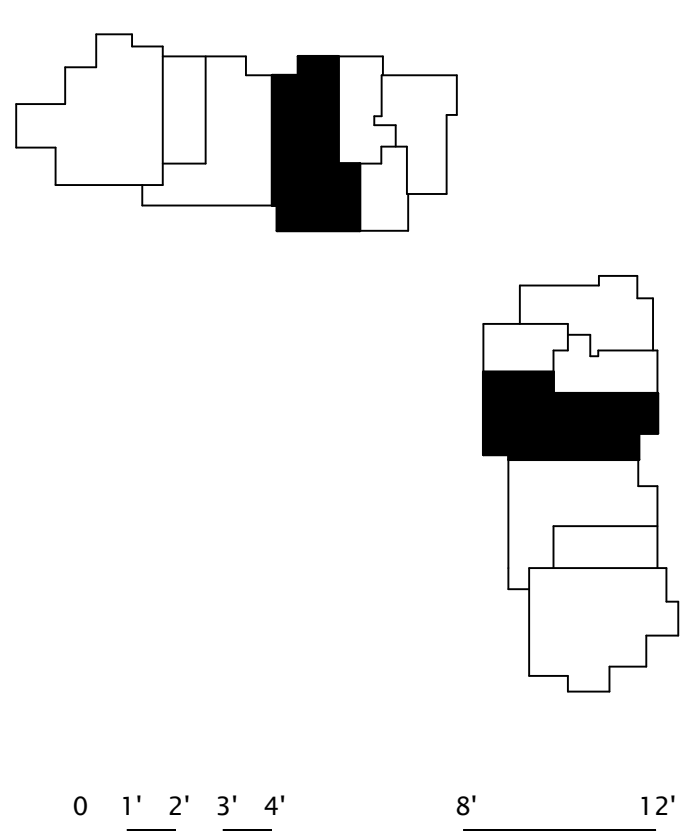

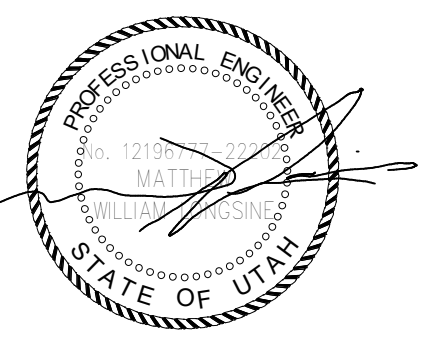

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ENLARGED MECHANICAL PLAN - UNIT B


M2.4.B

**SHEET NOTES:**


- A. CONFIRM EXACT LOCATION OF ALL WALL DEVICES WITH ARCHITECTURAL ELEVATIONS.
- B. CONFIRM ALL CEILING AND WALL ACCESS DOORS WITH ARCHITECTURAL ROFS AND WALL ELEVATIONS.
- C. REFER TO M3-2A-01 THROUGH M3-2C-R FOR RADIANT FLOOR HWYSR PIPING ROUTING AND SIZING.
- D. PROVIDE 1-INCH ACOUSTIC LINING FOR ENTIRETY OF MAIN DUCT RUN OFF FAN COIL.
- E. ALL RESIDENTIAL TOILET EXHAUST, DRYER EXHAUST, AND KITCHEN RANGE HOOD EXHAUST TO BE PART OF A SUB-DUCT EXHAUST SYSTEM.
- F. ROUTE 3/4" CONDENSATE DRAINS FROM FCUS TO NEAREST SINK TAILPIECE.

**NUMBERED NOTES:**


- 1 5/8" CONCENTRIC FLUE TO GAS FIREPLACE. PROVIDE ORTAL IN-LINE 180 POWERVENT (120V/15A).
- 2 RANGE HOOD EXHAUST FAN TO BE INTEGRAL WITH RANGE SPECIFIED BY THE ARCHITECT. INTERLOCK CONTROL WITH MUA-A.
- 3 ELECTRICAL RADIANT FLOOR TO BE PROVIDED IN MASTER BATHROOM. SEE ELECTRICAL DRAWINGS.
- 4 PROVIDE APRILAIRE 800 HUMIDIFIER. ASSUME 1/2" CW, 3/4" CD TO NEAREST SINK TAILPIECE, AND 120V1 ELECTRICAL CONNECTION.
- 5 2" RETURN AIR SLOT.
- 6 PROVIDE 208/18A/1 CONNECTION FOR APRILAIRE 800 HUMIDIFIER DOWNSTREAM OF FAN COIL UNIT. REFER TO ELECTRICAL DRAWINGS FOR DETAIL. THIS IS AN OWNER OPTION. CONFIRM WITH OWNER AND ARCHITECT PRIOR TO PROVIDING HUMIDIFIER.
- 7 PROVIDE 120/16A/1 CONNECTION FOR APRILAIRE 800 HUMIDIFIER DOWNSTREAM OF FAN COIL UNIT. REFER TO ELECTRICAL DRAWINGS FOR DETAIL. THIS IS AN OWNER OPTION. CONFIRM WITH OWNER AND ARCHITECT PRIOR TO PROVIDING HUMIDIFIER.

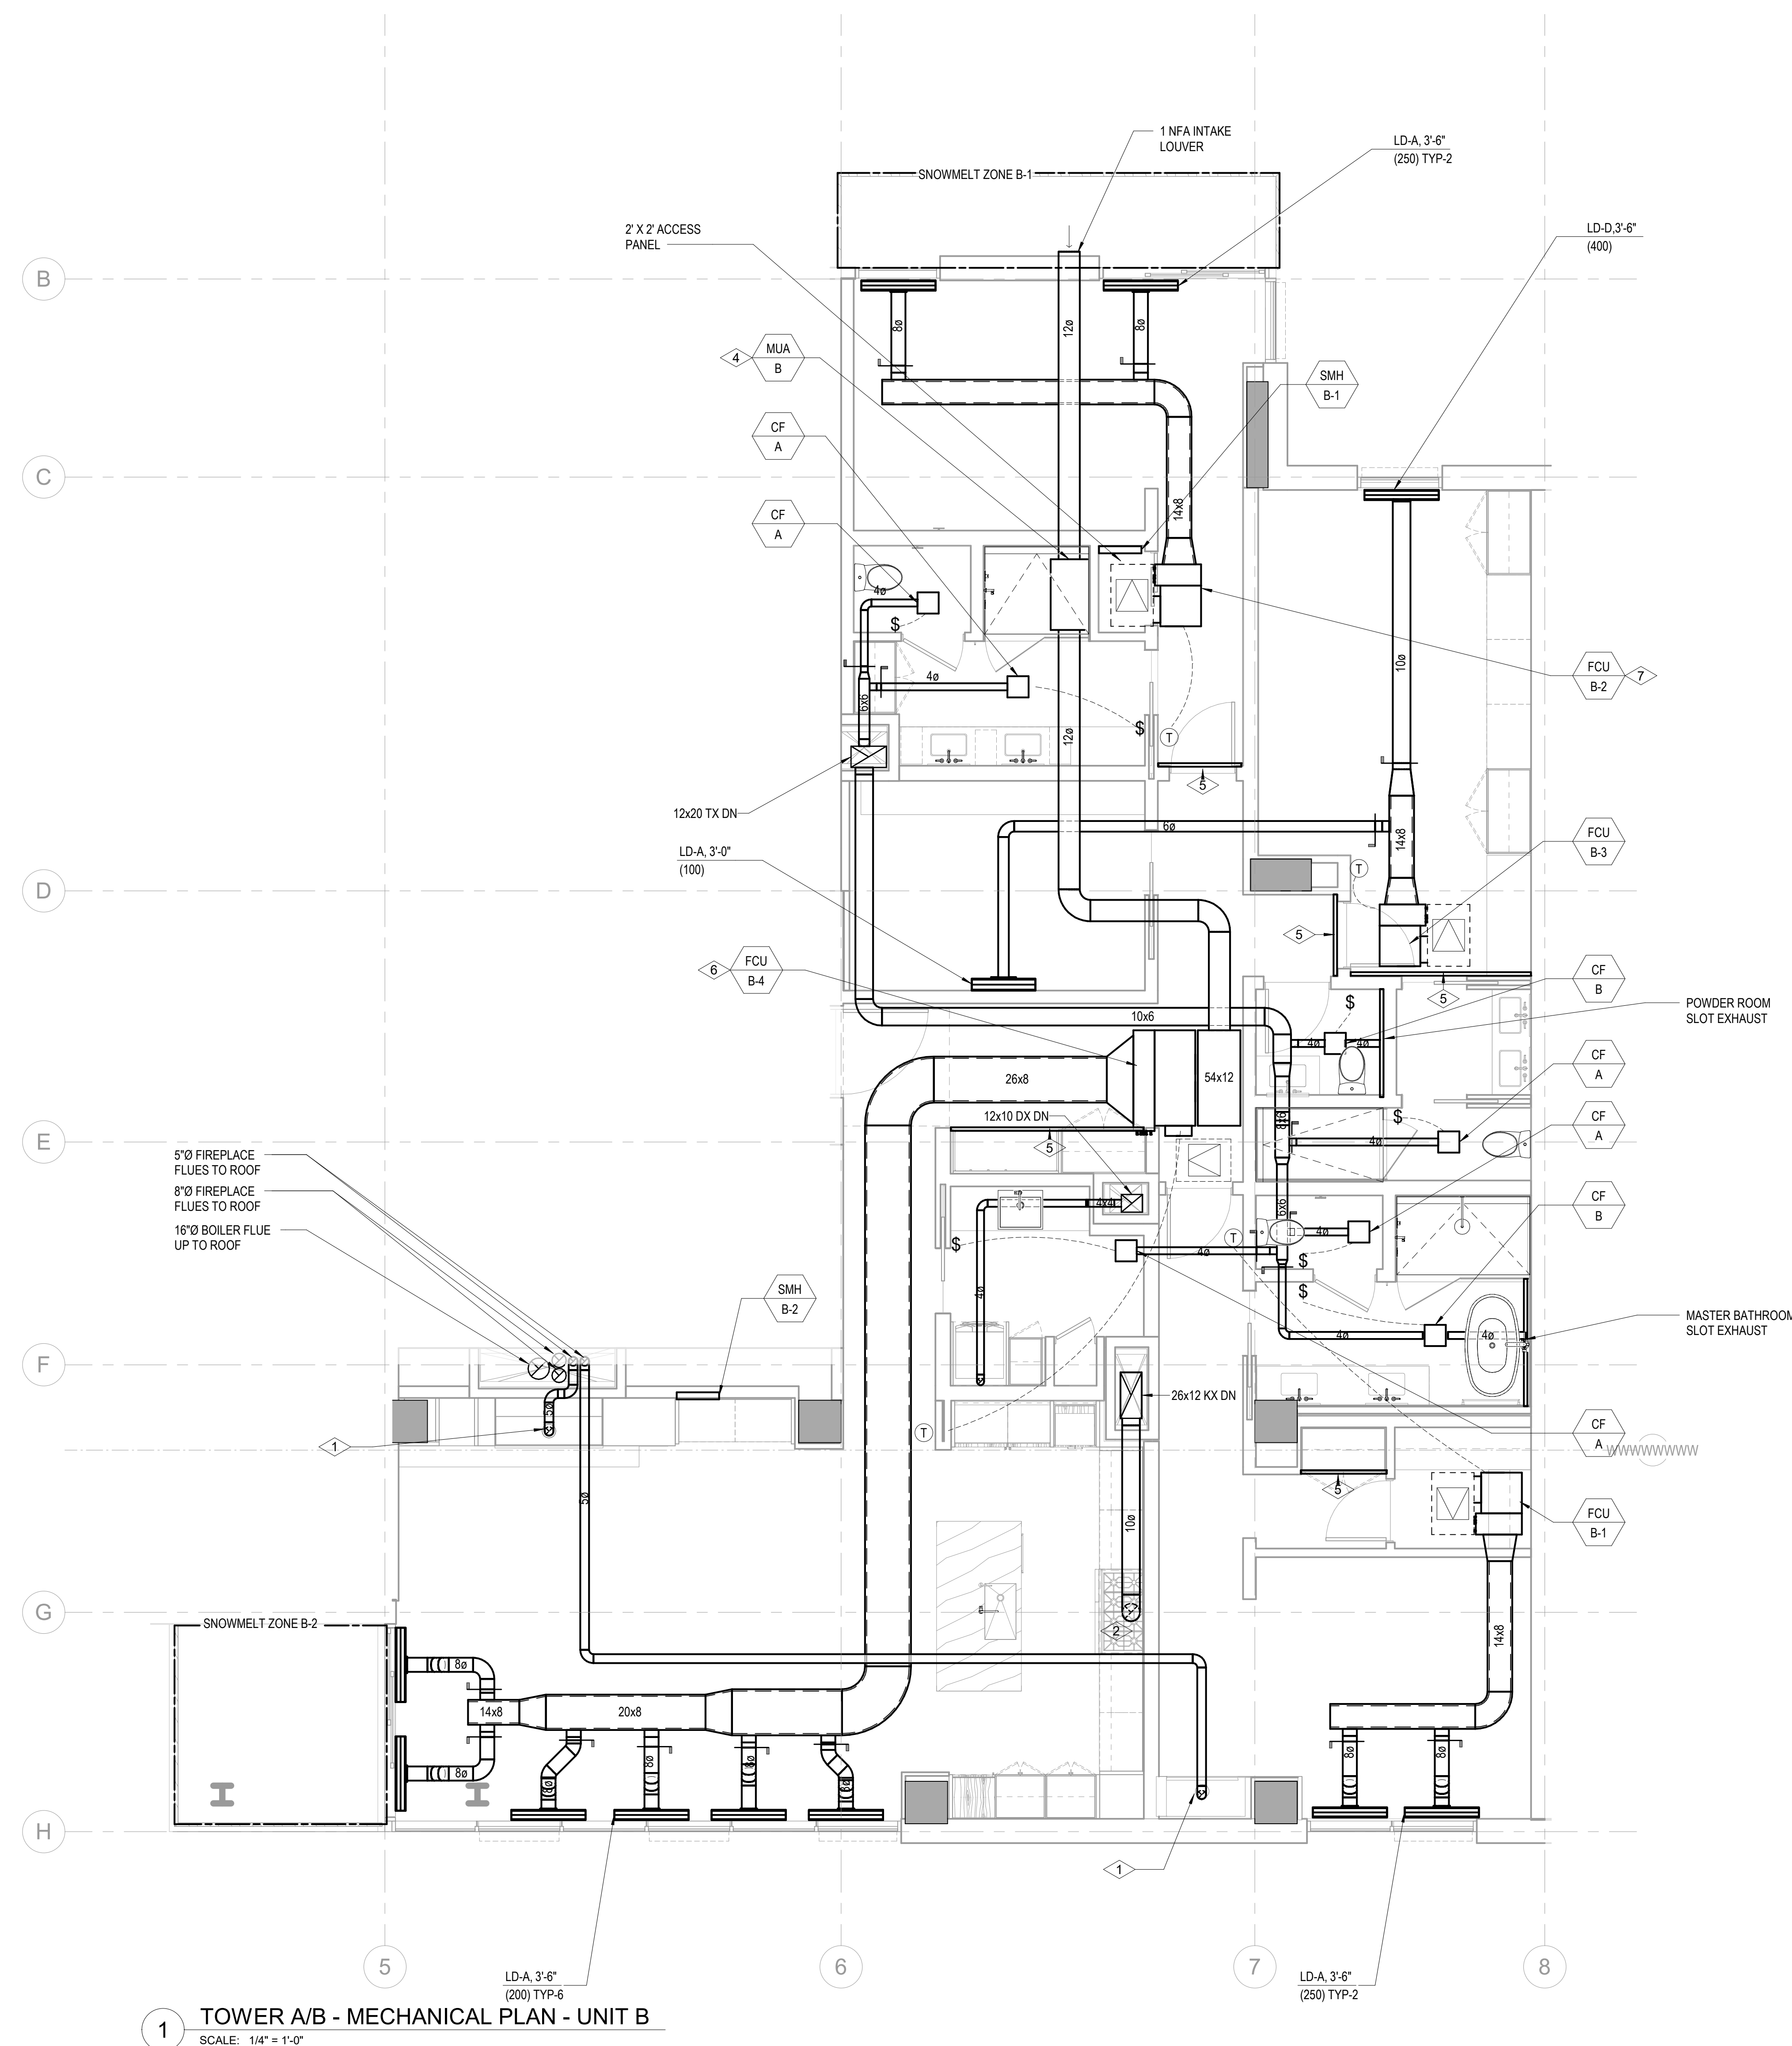

**1 TOWER A/B - MECHANICAL PLAN - UNIT B**  
SCALE: 1/4" = 1'-0"

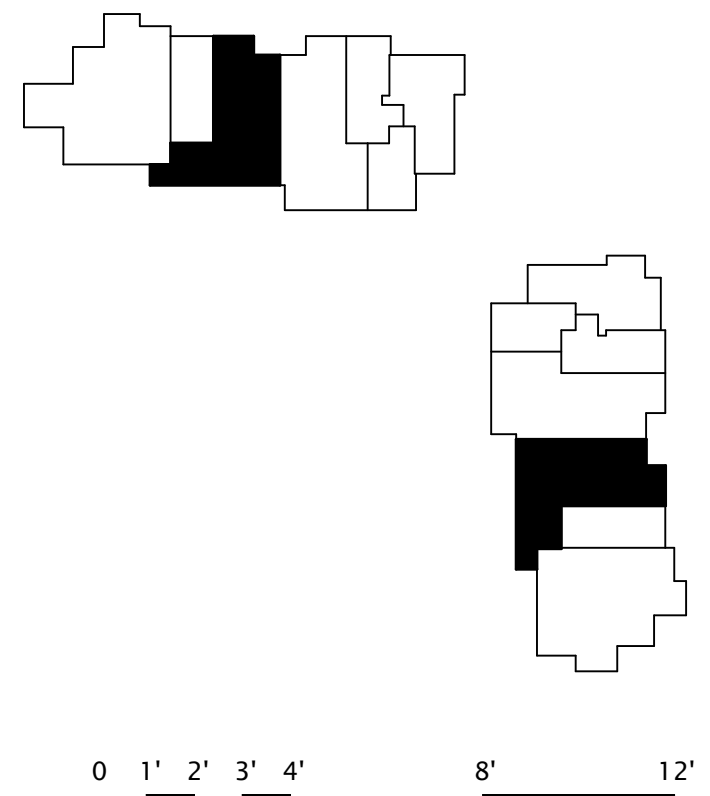



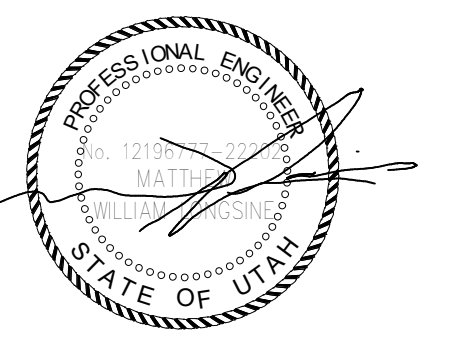

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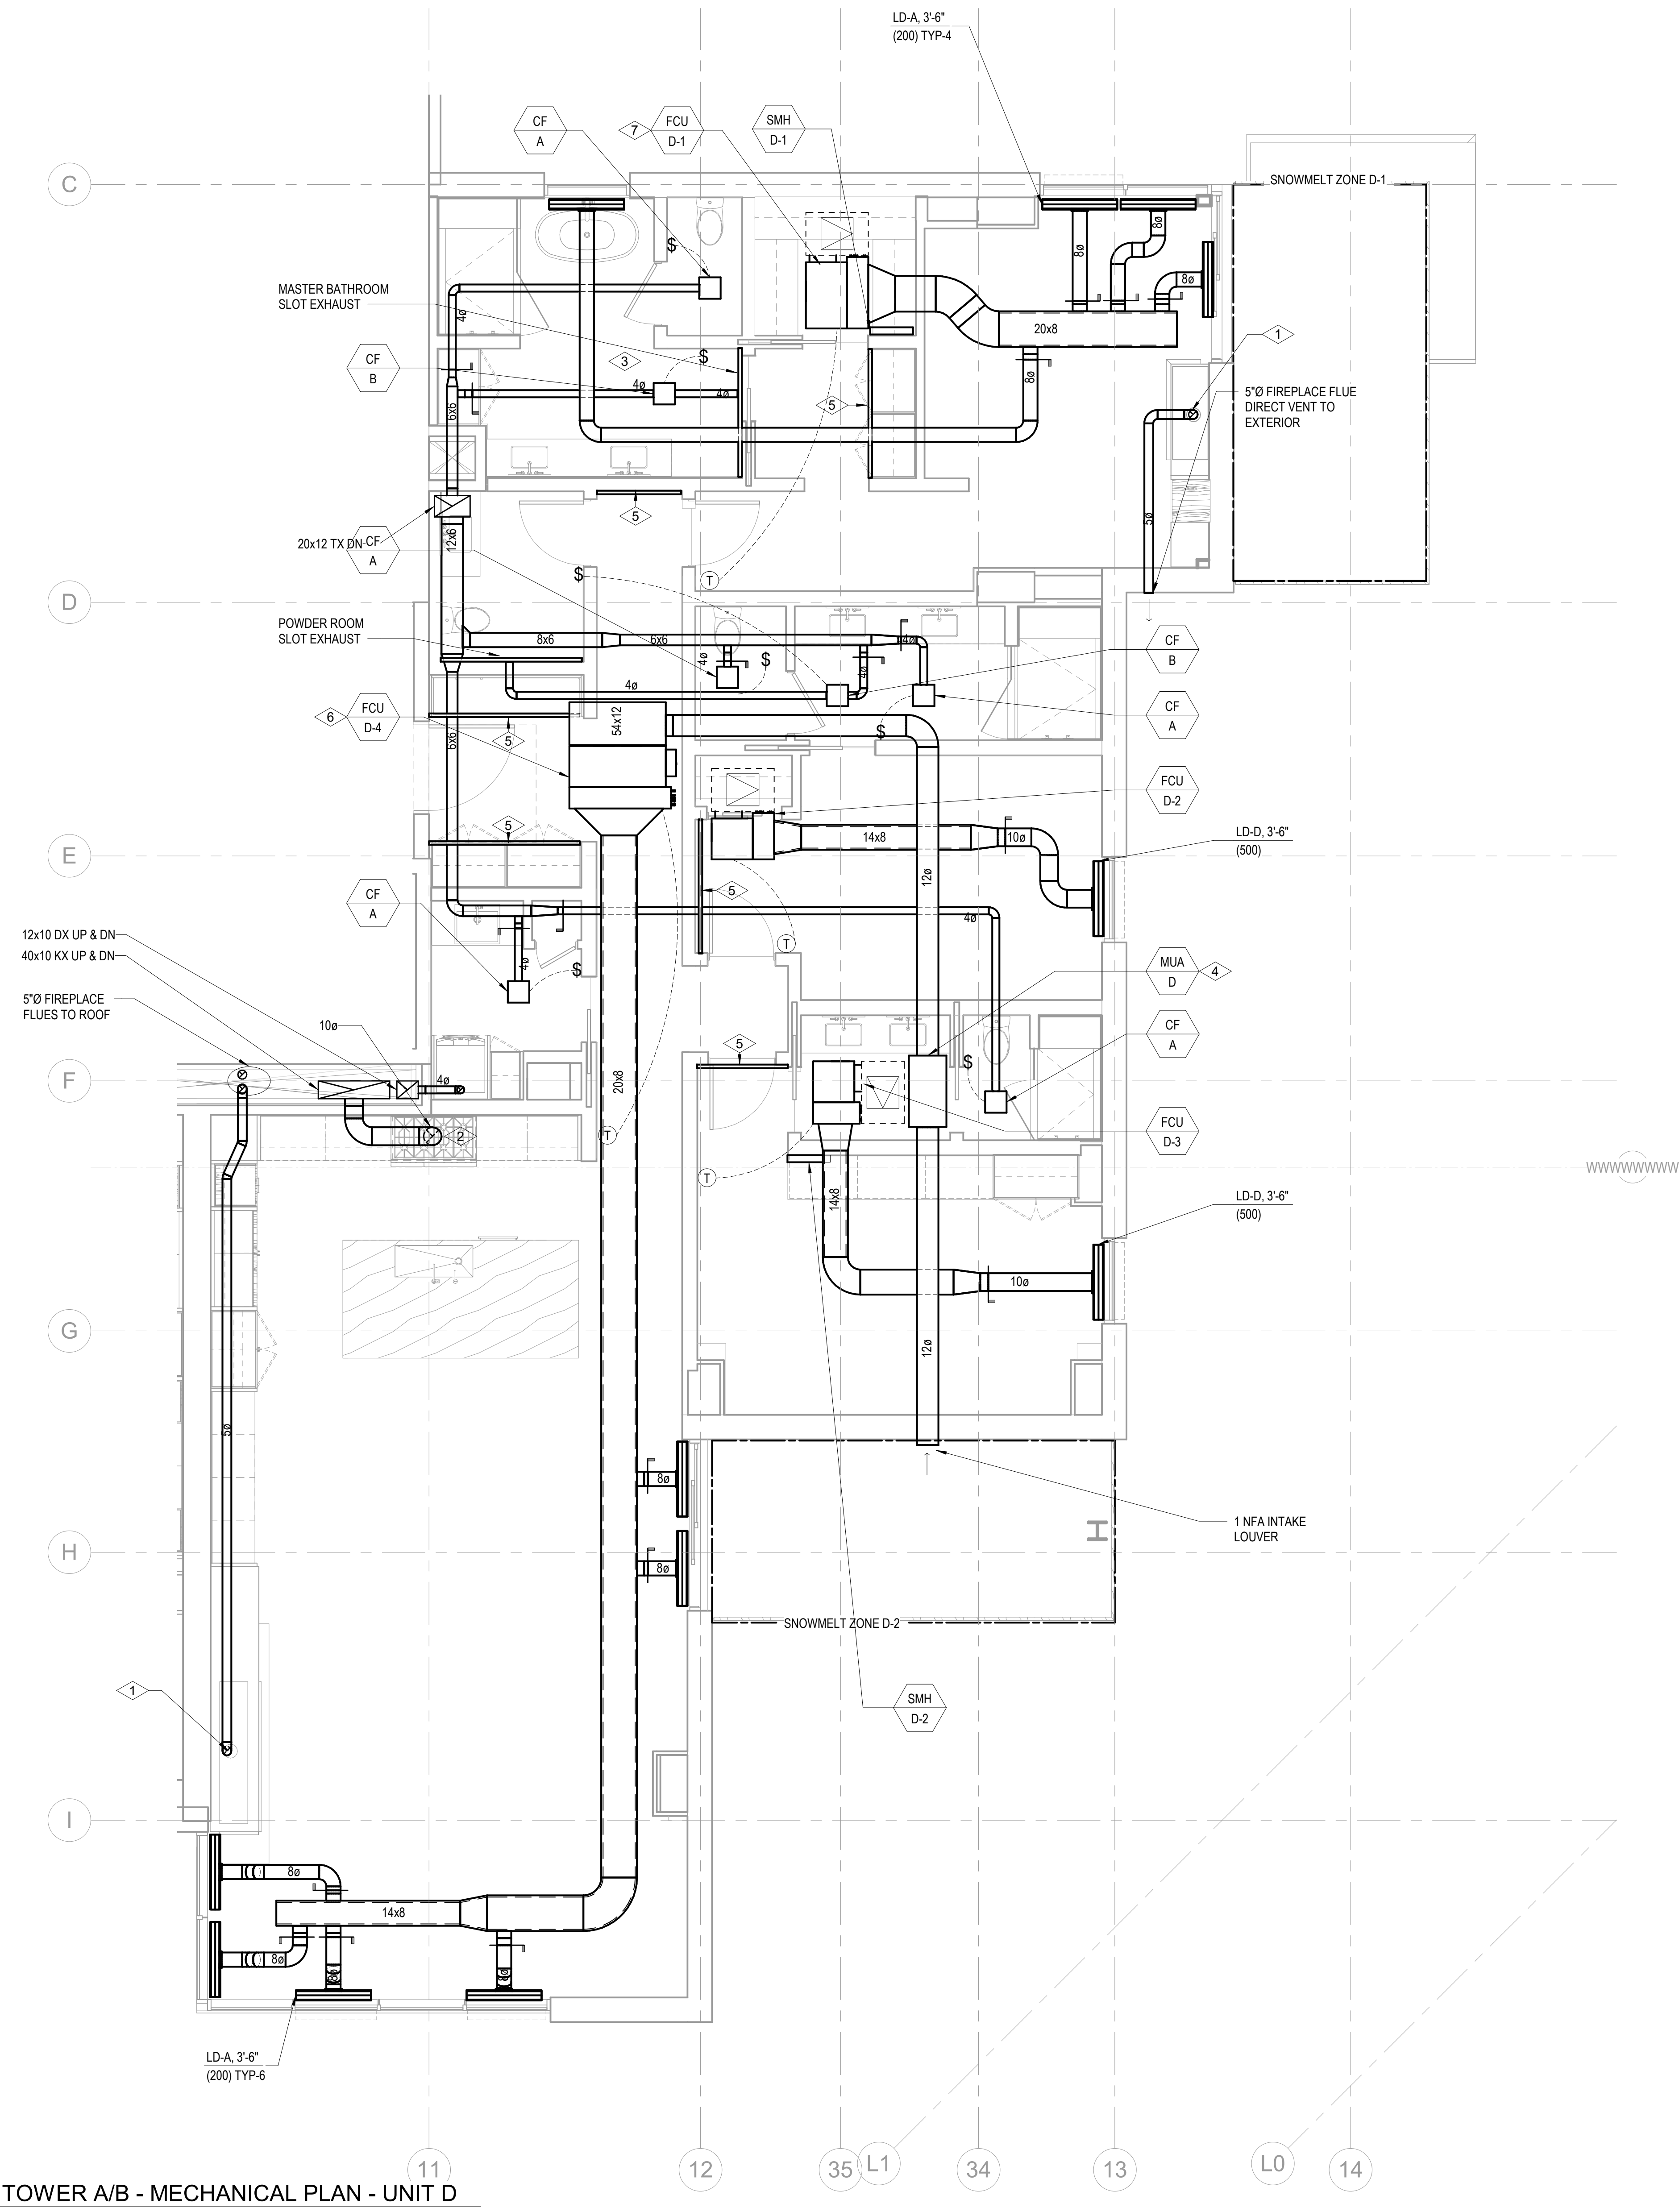
ENLARGED MECHANICAL PLAN - UNIT D  
**M2.4.D**

**SHEET NOTES:**


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- E. ALL RESIDENTIAL TOILET EXHAUST, DRYER EXHAUST, AND KITCHEN RANGE HOOD EXHAUST TO BE PART OF A SUB-DUCT EXHAUST SYSTEM.
- F. ROUTE 3/4" CONDENSATE DRAINS FROM FCUS TO NEAREST SINK TAILPIECE.


**NUMBERED NOTES:**

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- 4. PROVIDE APRILAIRE 800 HUMIDIFIER. ASSUME 1/2" CW, 3/4" CD TO NEAREST SINK TAILPIECE, AND 120V1 ELECTRICAL CONNECTION.
- 5. 2" RETURN AIR SLOT.
- 6. PROVIDE 208V/16A/1 CONNECTION FOR APRILAIRE 800 HUMIDIFIER DOWNSTREAM OF FAN COIL UNIT. REFER TO ELECTRICAL DRAWINGS FOR DETAIL. THIS IS AN OWNER OPTION. CONFIRM WITH OWNER AND ARCHITECT PRIOR TO PROVIDING HUMIDIFIER.
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**1 TOWER A/B - MECHANICAL PLAN - UNIT D**  
SCALE: 1/4" = 1'-0"



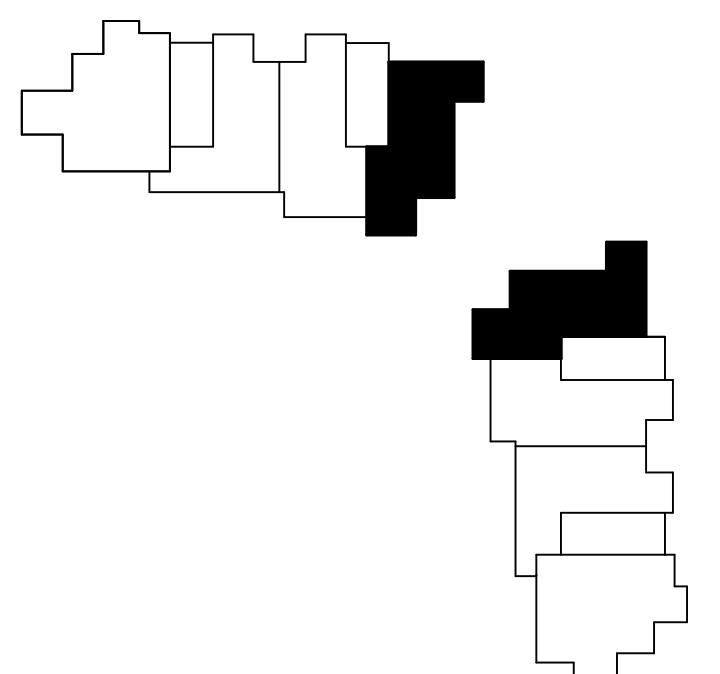

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**MEP Engineer**  
WSP USA  
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principal architect \_\_\_\_\_  
project manager \_\_\_\_\_  
drawn by \_\_\_\_\_  
checked by \_\_\_\_\_  
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revisions:  
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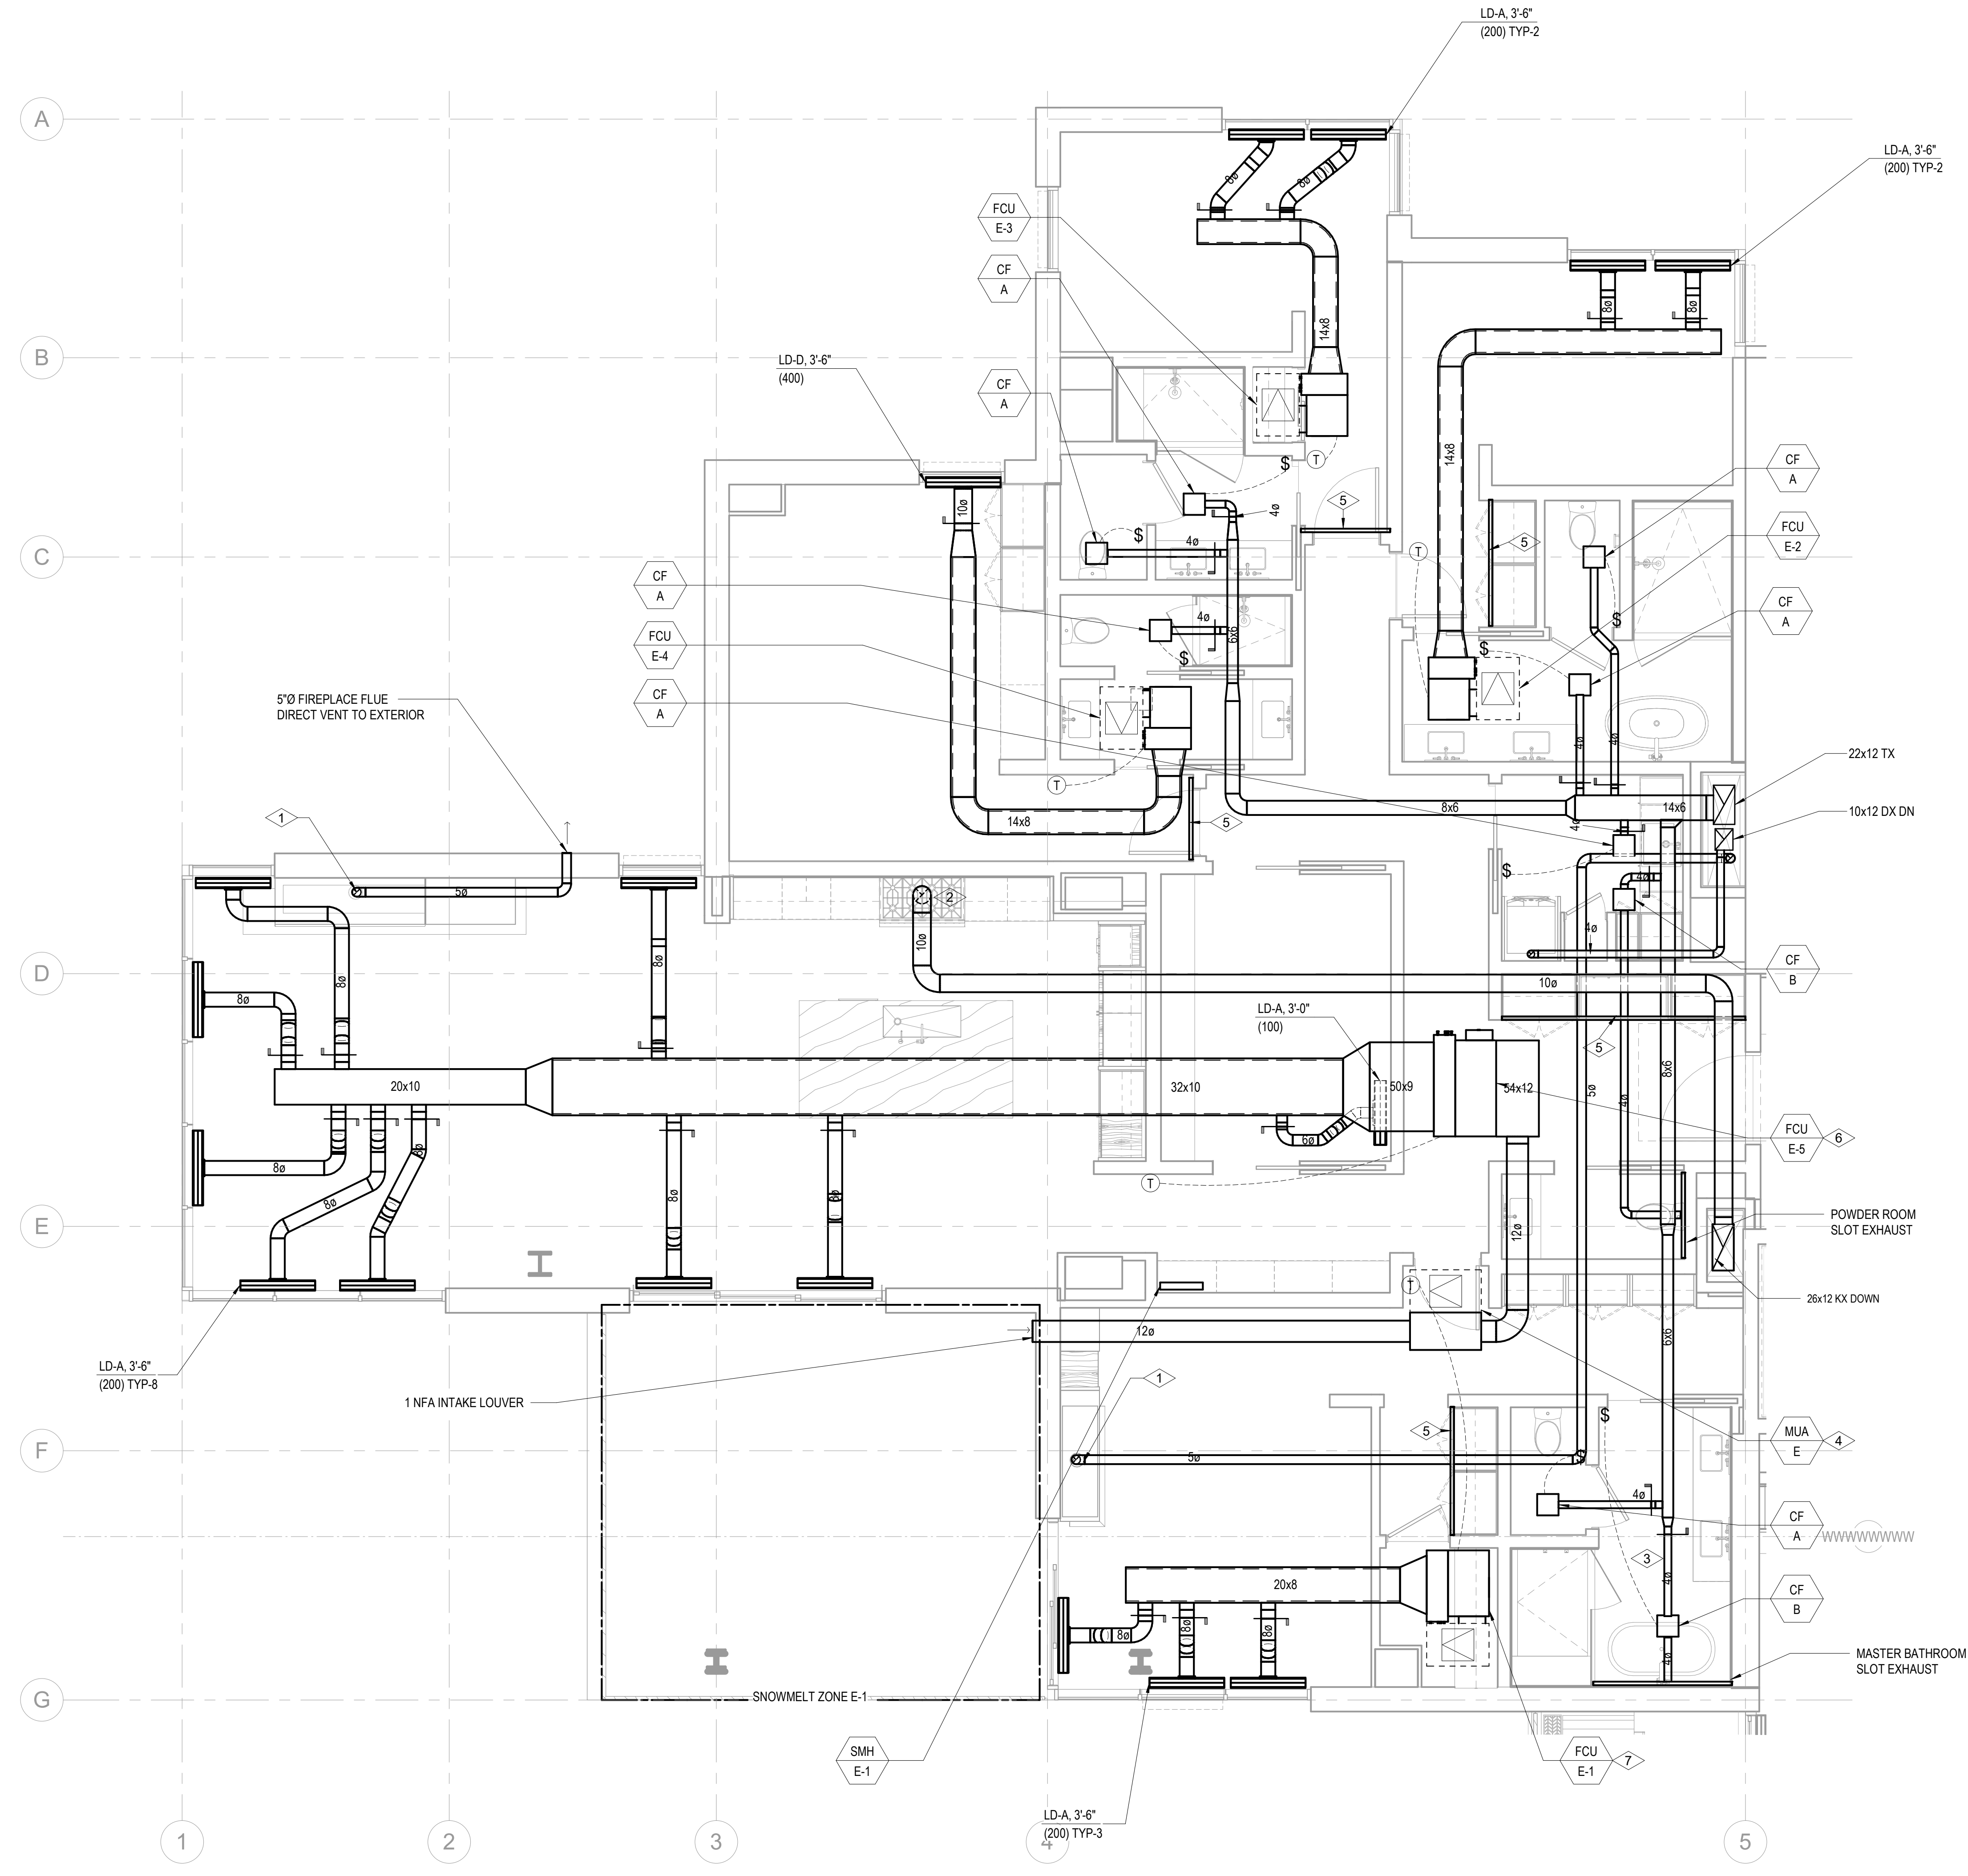
ENLARGED MECHANICAL PLAN - UNIT E  
**M2.4.E**

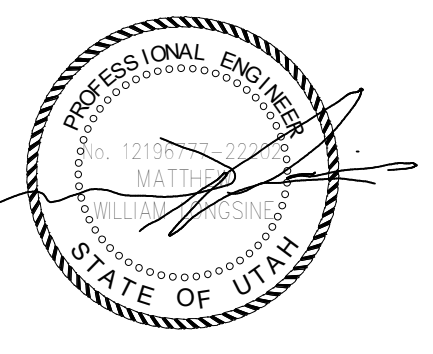**SHEET NOTES:**


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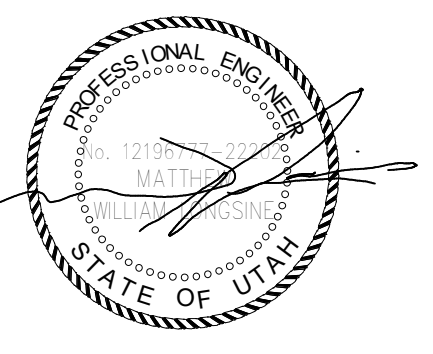
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- 4 PROVIDE APRILAIRE 800 HUMIDIFIER. ASSUME 1/2" CW, 3/4" CD TO NEAREST SINK TAILPIECE, AND 120V1 ELECTRICAL CONNECTION.
- 5 2" RETURN AIR SLOT.
- 6 PROVIDE 208/16A/1 CONNECTION FOR APRILAIRE 800 HUMIDIFIER DOWNSTREAM OF FAN COIL UNIT. REFER TO ELECTRICAL DRAWINGS FOR DETAIL. THIS IS AN OWNER OPTION. CONFIRM WITH OWNER AND ARCHITECT PRIOR TO PROVIDING HUMIDIFIER.
- 7 PROVIDE 120/16A/1 CONNECTION FOR APRILAIRE 800 HUMIDIFIER DOWNSTREAM OF FAN COIL UNIT. REFER TO ELECTRICAL DRAWINGS FOR DETAIL. THIS IS AN OWNER OPTION. CONFIRM WITH OWNER AND ARCHITECT PRIOR TO PROVIDING HUMIDIFIER.



**1 TOWER A/B - MECHANICAL PLAN - UNIT E**  
SCALE: 1/4" = 1'-0"



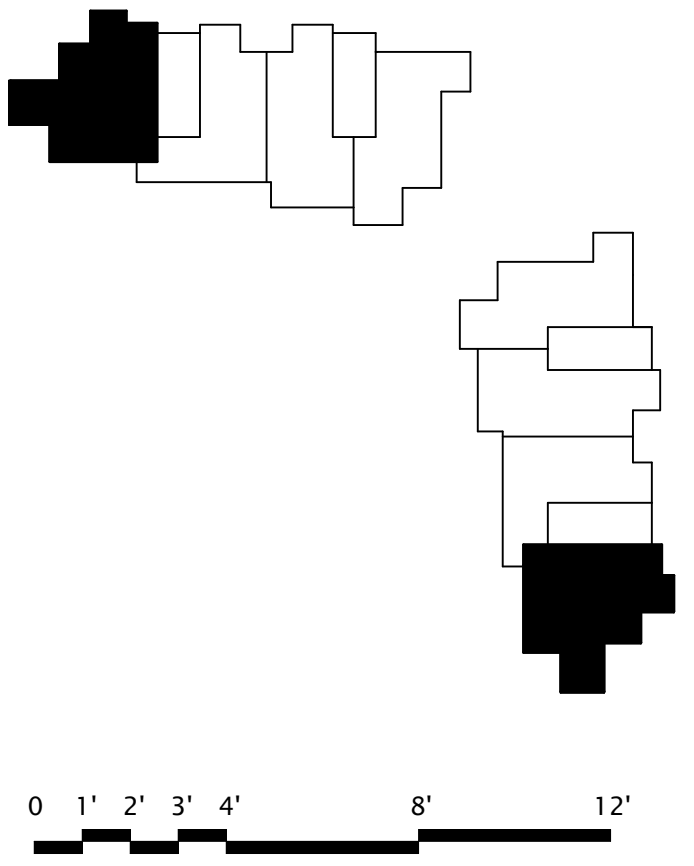

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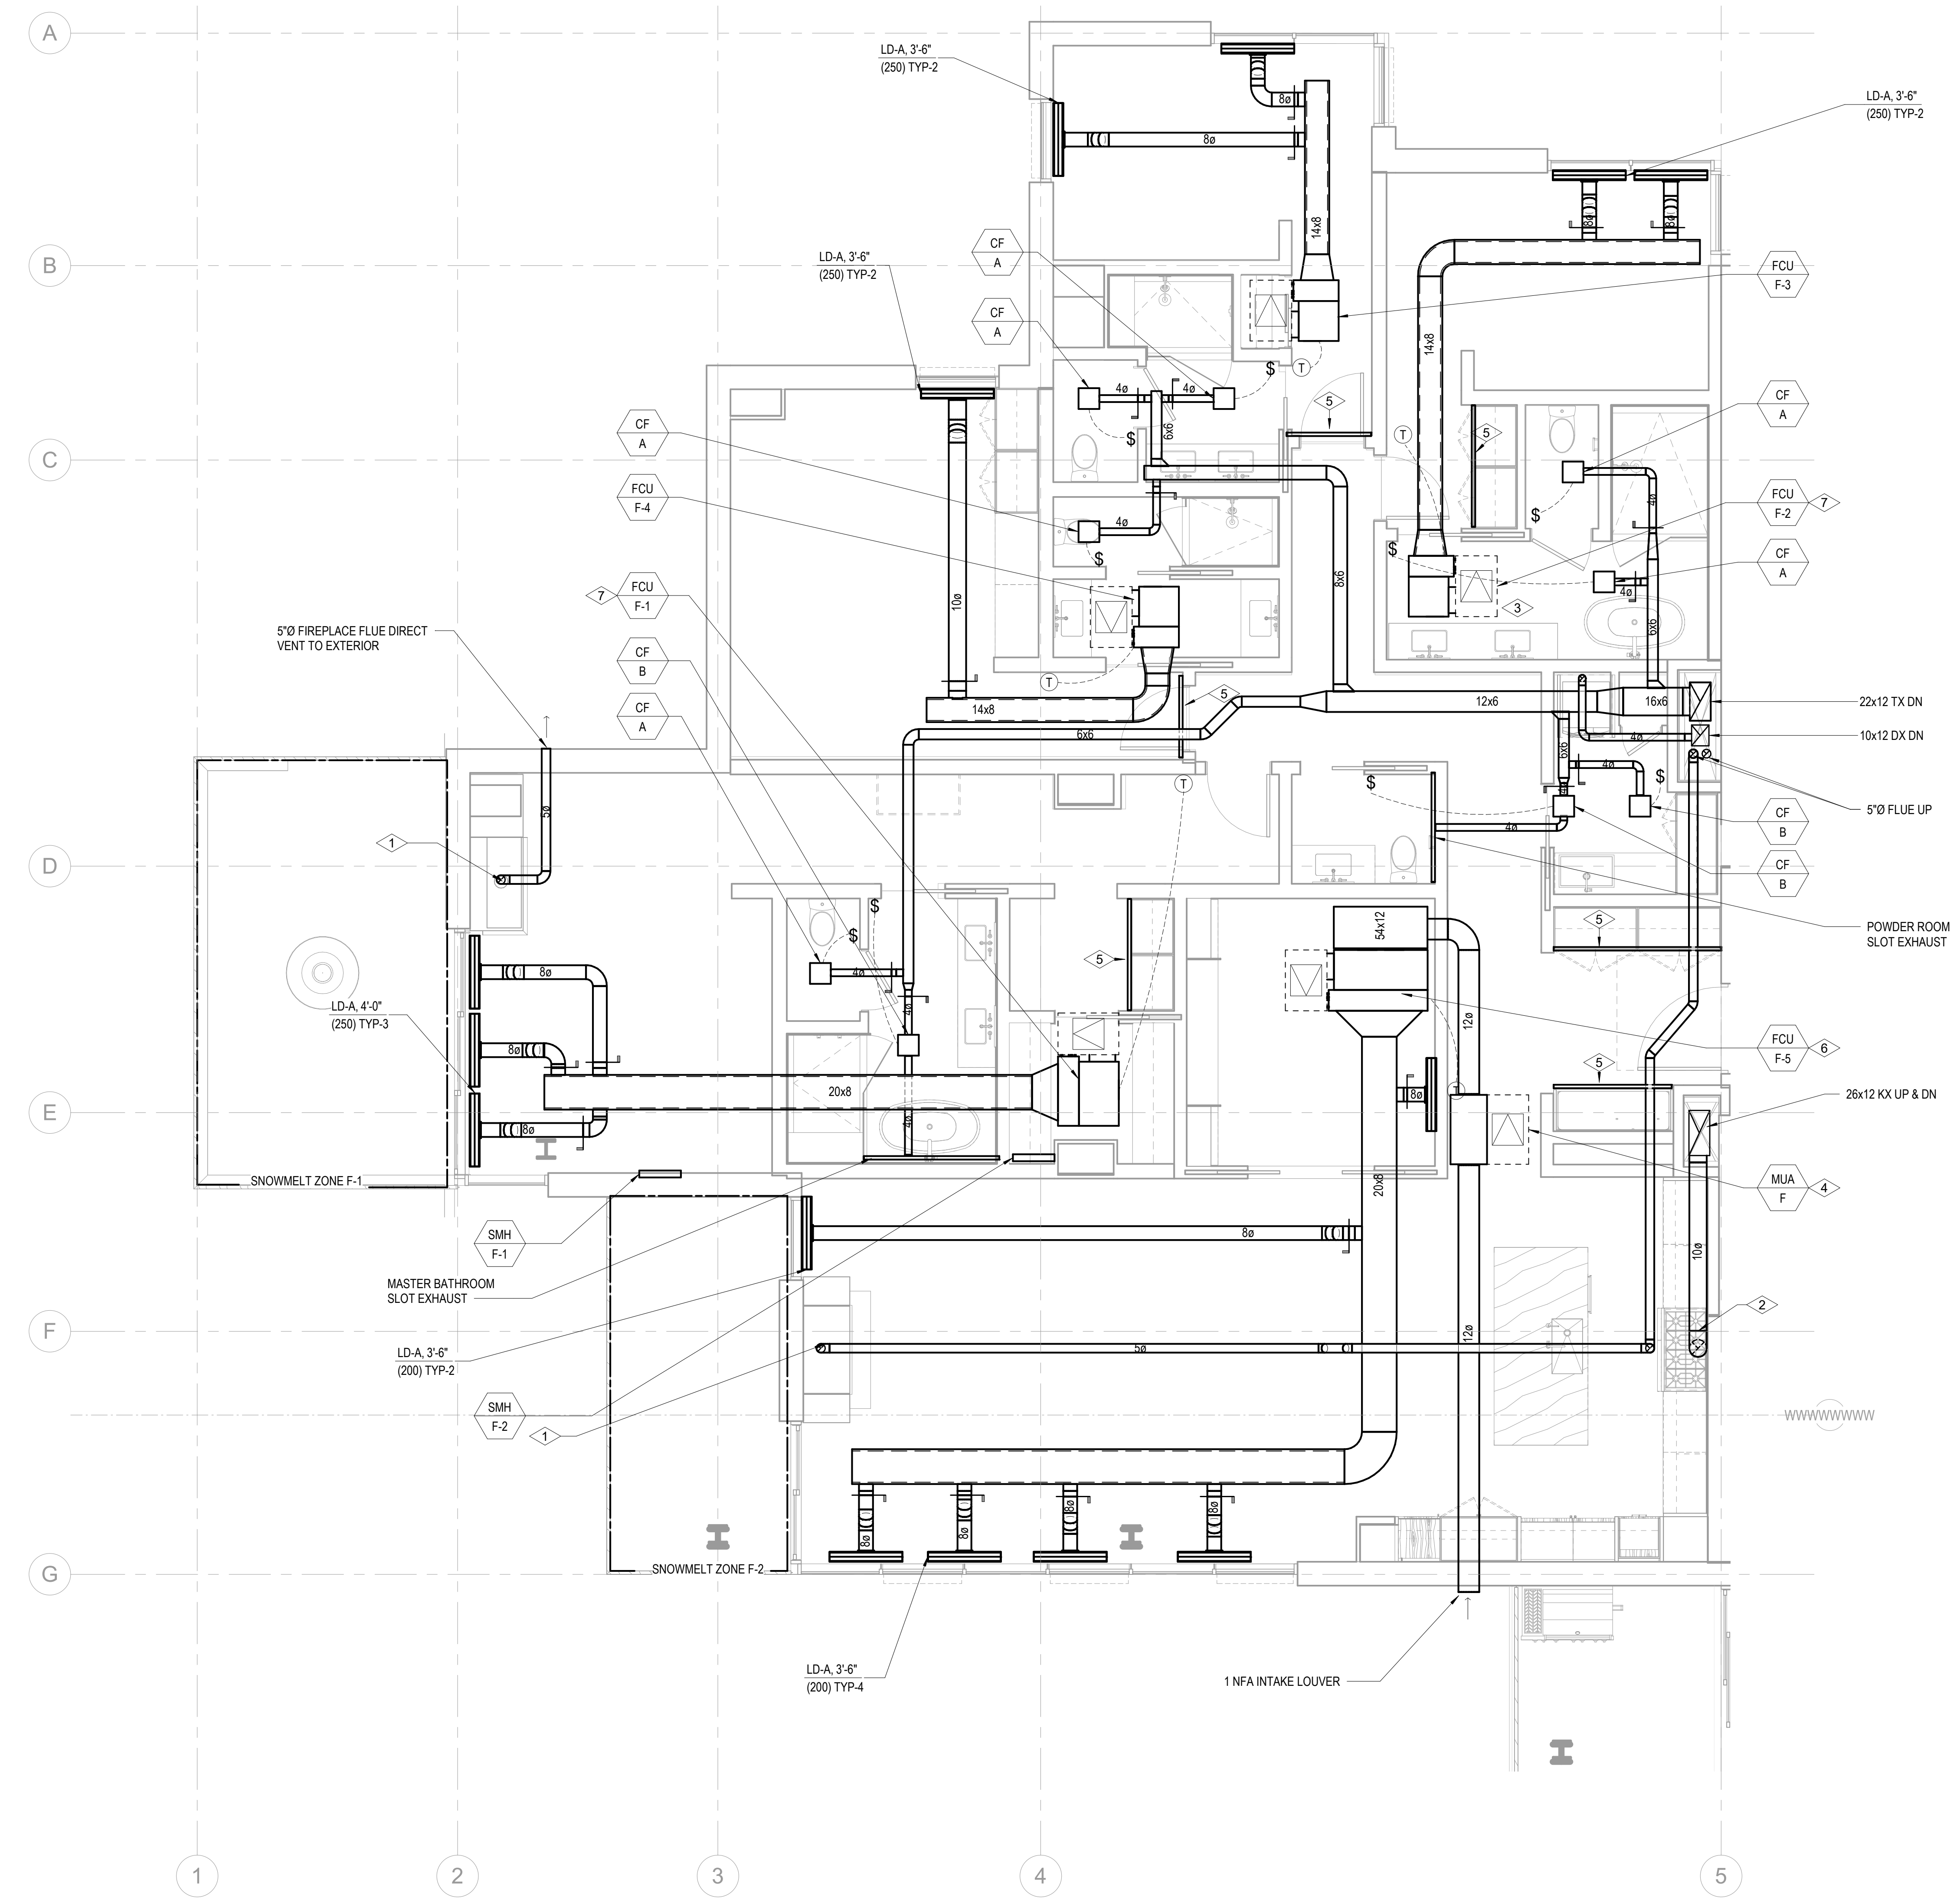
ENLARGED MECHANICAL PLAN - UNIT F  
**M2.4.F**

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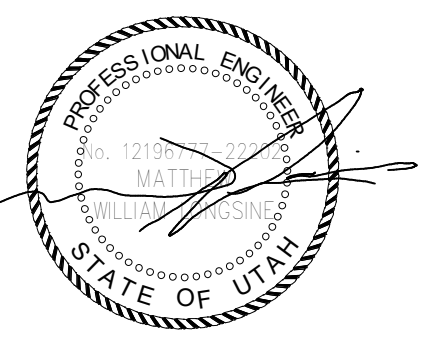
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- 3 ELECTRICAL RADIANT FLOOR TO BE PROVIDED IN MASTER BATHROOM. SEE ELECTRICAL DRAWINGS.
- 4 PROVIDE APRILAIRE 800 HUMIDIFIER. ASSUME 1/2" CW, 3/4" CD TO NEAREST SINK TAILPIECE, AND 120V1 ELECTRICAL CONNECTION.
- 5 2" RETURN AIR SLOT.
- 6 PROVIDE 208/184V1 CONNECTION FOR APRILAIRE 800 HUMIDIFIER DOWNSTREAM OF FAN COIL UNIT. REFER TO ELECTRICAL DRAWINGS FOR DETAIL. THIS IS AN OWNER OPTION. CONFIRM WITH OWNER AND ARCHITECT PRIOR TO PROVIDING HUMIDIFIER.
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**1 TOWER A/B - MECHANICAL PLAN - UNIT F**  
SCALE: 1/4" = 1'-0"





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principal architect \_\_\_\_\_  
project manager \_\_\_\_\_  
drawn by \_\_\_\_\_  
checked by \_\_\_\_\_ checker \_\_\_\_\_  
job no. \_\_\_\_\_  
date 11/18/2022

revisions:  
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no. date by

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11/18/2022

ENLARGED MECHANICAL PLAN - UNIT G


M2.4.G

**SHEET NOTES:**


- A. CONFIRM EXACT LOCATION OF ALL WALL DEVICES WITH ARCHITECTURAL ELEVATIONS.
- B. CONFIRM ALL CEILING AND WALL ACCESS DOORS WITH ARCHITECTURAL ROFS AND WALL ELEVATIONS.
- C. REFER TO M3-2A-01 THROUGH M3-2C-R FOR RADIANT FLOOR HWYSR PIPING ROUTING AND SIZING.
- D. PROVIDE 1-INCH ACOUSTIC LINING FOR ENTIRETY OF MAIN DUCT RUN OFF FAN COIL.
- E. ALL RESIDENTIAL TOILET EXHAUST, DRYER EXHAUST, AND KITCHEN RANGE HOOD EXHAUST TO BE PART OF A SUB-DUCT EXHAUST SYSTEM.
- F. ROUTE 3/4" CONDENSATE DRAINS FROM FCUS TO NEAREST SINK TAILPIECE.


**NUMBERED NOTES:**

- 1 5"Ø CONCENTRIC FLUE TO GAS FIREPLACE. PROVIDE ORTAL IN-LINE 180 POWERVENT (120V/15A).
- 2 PROVIDE APRILAIRE 800 HUMIDIFIER. ASSUME 1/2" CW, 3/4" CD TO NEAREST SINK TAILPIECE. AND 120V1 ELECTRICAL CONNECTION.
- 3 ELECTRICAL RADIANT FLOOR TO BE PROVIDED IN MASTER BATHROOM. SEE ELECTRICAL DRAWINGS.
- 4 2" RETURN AIR SLOT
- 5 PROVIDE 208 (16A/1) CONNECTION FOR APRILAIRE 800 HUMIDIFIER DOWNSTREAM OF FAN COIL UNIT. REFER TO ELECTRICAL DRAWINGS FOR DETAIL. THIS IS AN OWNER OPTION. CONFIRM WITH OWNER AND ARCHITECT PRIOR TO PROVIDING HUMIDIFIER.
- 6 PROVIDE 120(16A/1) CONNECTION FOR APRILAIRE 800 HUMIDIFIER DOWNSTREAM OF FAN COIL UNIT. REFER TO ELECTRICAL DRAWINGS FOR DETAIL. THIS IS AN OWNER OPTION. CONFIRM WITH OWNER AND ARCHITECT PRIOR TO PROVIDING HUMIDIFIER.

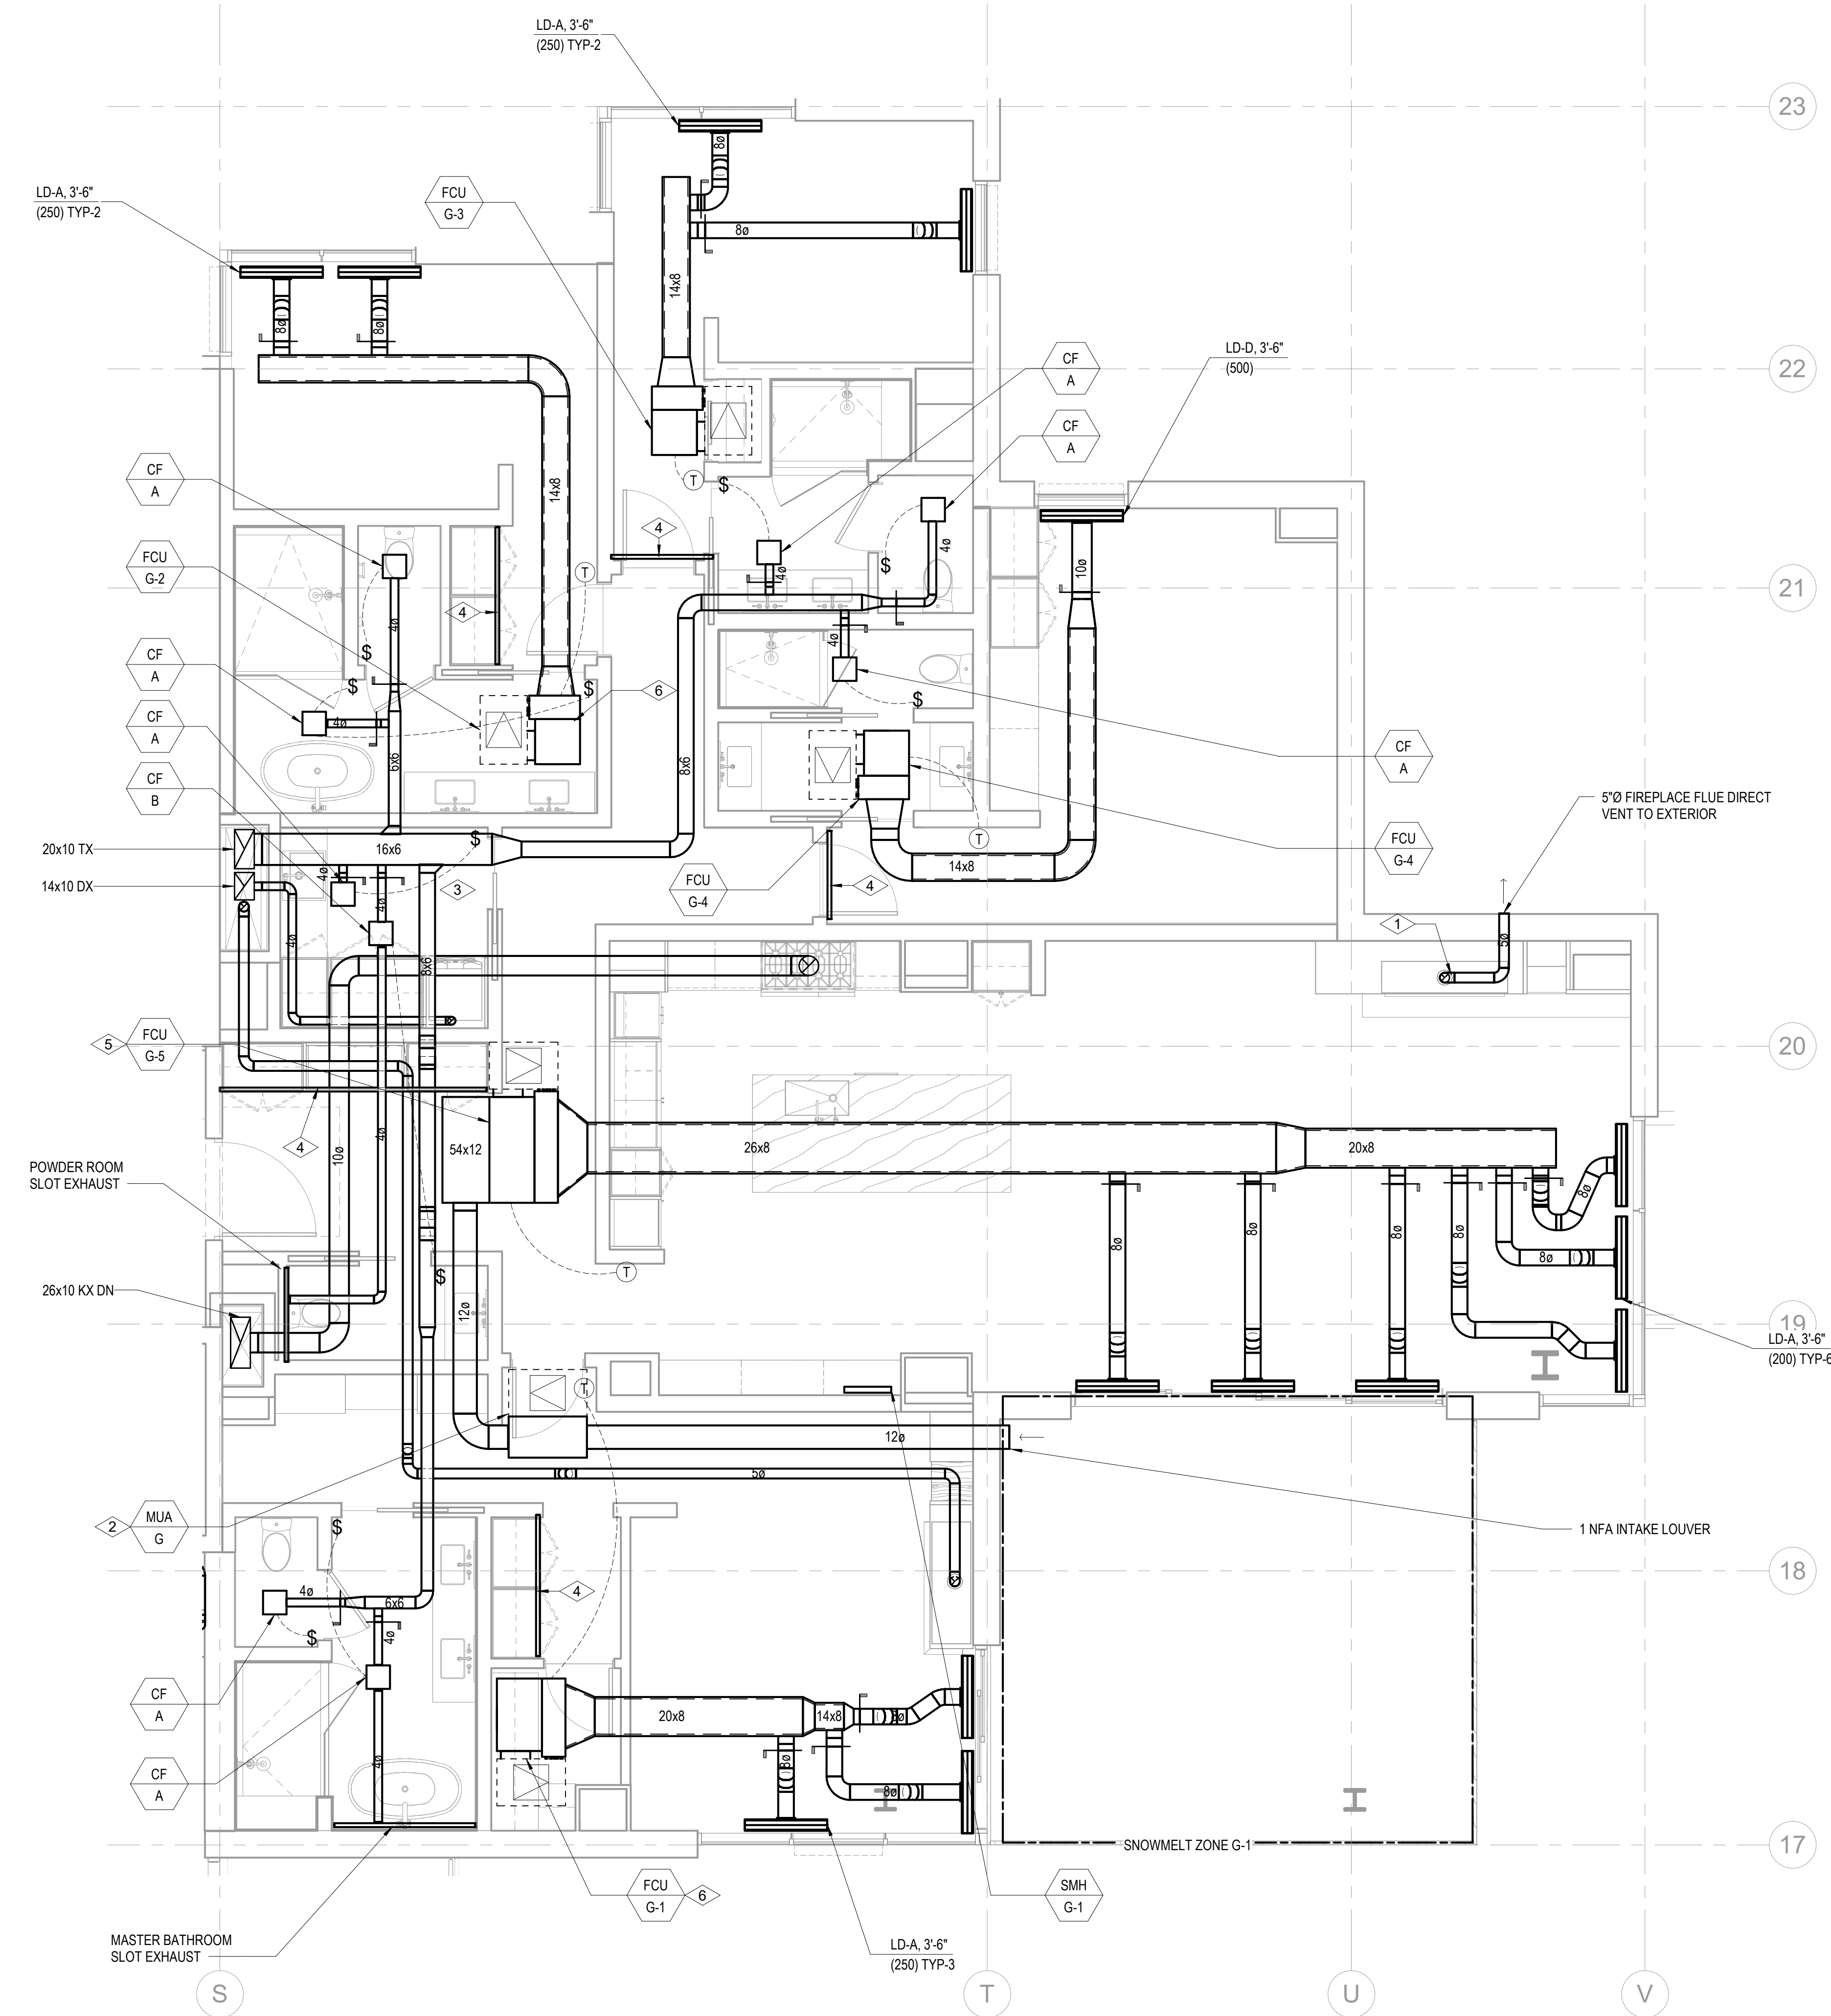

1 TOWER A/B - MECHANICAL PLAN - UNIT G  
SCALE: 1/4" = 1'-0"

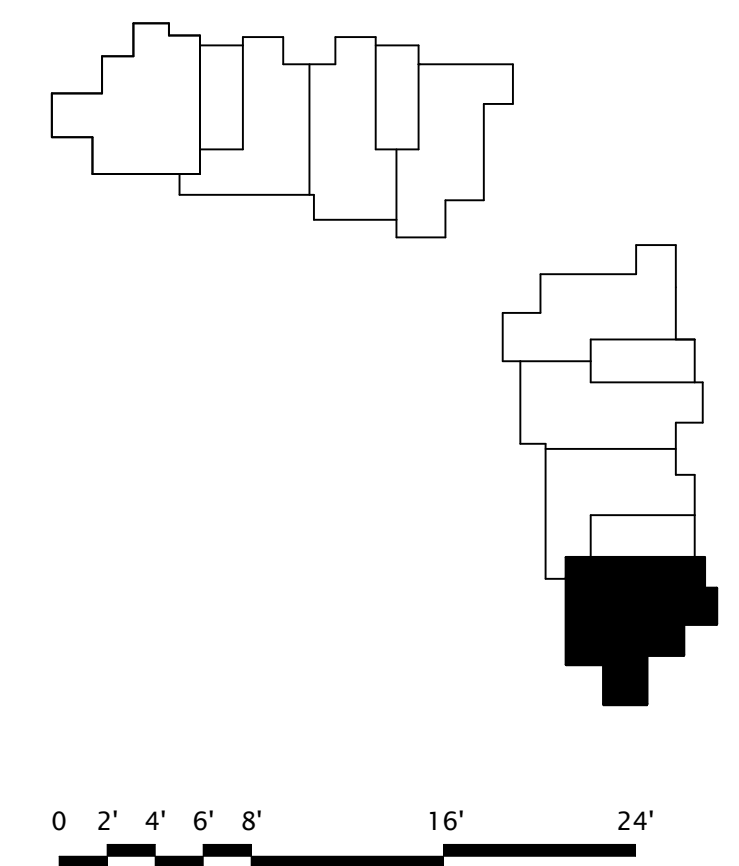

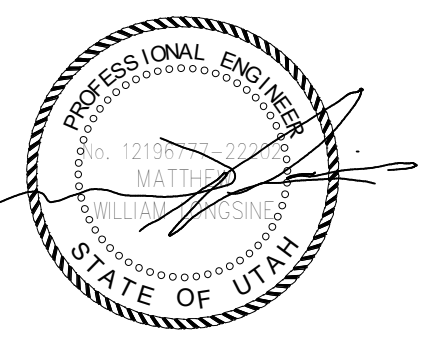

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principal architect \_\_\_\_\_  
project manager \_\_\_\_\_  
drawn by \_\_\_\_\_  
checked by: Checker \_\_\_\_\_  
job no. \_\_\_\_\_  
date 11/18/2022

revisions:  
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\_\_\_\_\_  
no. date by

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11/18/2022


ENLARGED MECHANICAL PLAN - UNIT H  
**M2.4.H**

**SHEET NOTES:**


- A. CONFIRM EXACT LOCATION OF ALL WALL DEVICES WITH ARCHITECTURAL ELEVATIONS.
- B. CONFIRM ALL CEILING AND WALL ACCESS DOORS WITH ARCHITECTURAL ROOPS AND WALL ELEVATIONS.
- C. REFER TO M3-2A-01 THROUGH M3-2C-R FOR RADIANT FLOOR HWYSR PIPING ROUTING AND SIZING.
- D. PROVIDE 1-INCH ACOUSTIC LINING FOR ENTIRETY OF MAIN DUCT RUN OFF FAN COIL.
- E. ALL RESIDENTIAL TOILET EXHAUST, DRYER EXHAUST, AND KITCHEN RANGE HOOD EXHAUST TO BE PART OF A SUB-DUCT EXHAUST SYSTEM.
- F. ROUTE 3/4" CONDENSATE DRAINS FROM FCUS TO NEAREST SINK TAILPIECE.

**NUMBERED NOTES:**


- 1 5/8" CONCENTRIC FLUE TO GAS PRELACE. PROVIDE ORTAL IN-LINE 180 POWERVENT (120V/15A).
- 2 RANGE HOOD EXHAUST FAN TO BE INTEGRAL WITH RANGE SPECIFIED BY THE ARCHITECT. INTERLOCK CONTROL WITH MUA-A.
- 3 ELECTRICAL RADIANT FLOOR TO BE PROVIDED IN MASTER BATHROOM. SEE ELECTRICAL DRAWINGS.
- 4 PROVIDE APRILAIRE 800 HUMIDIFIER. ASSUME 1/2" CW, 3/4" CD TO NEAREST SINK TAILPIECE, AND 120V1 ELECTRICAL CONNECTION.
- 5 2" RETURN AIR SLOT.
- 6 PROVIDE 120/18A/1 CONNECTION FOR APRILAIRE 800 HUMIDIFIER DOWNSTREAM OF FAN COIL UNIT. REFER TO ELECTRICAL DRAWINGS FOR DETAIL. THIS IS AN OWNER OPTION. CONFIRM WITH OWNER AND ARCHITECT PRIOR TO PROVIDING HUMIDIFIER.
- 7 PROVIDE 208/18A/1 CONNECTION FOR APRILAIRE 800 HUMIDIFIER DOWNSTREAM OF FAN COIL UNIT. REFER TO ELECTRICAL DRAWINGS FOR DETAIL. THIS IS AN OWNER OPTION. CONFIRM WITH OWNER AND ARCHITECT PRIOR TO PROVIDING HUMIDIFIER.
- 8 FLAT DIFFUSERS TO FIT BENEATH LOWERED SLAB.

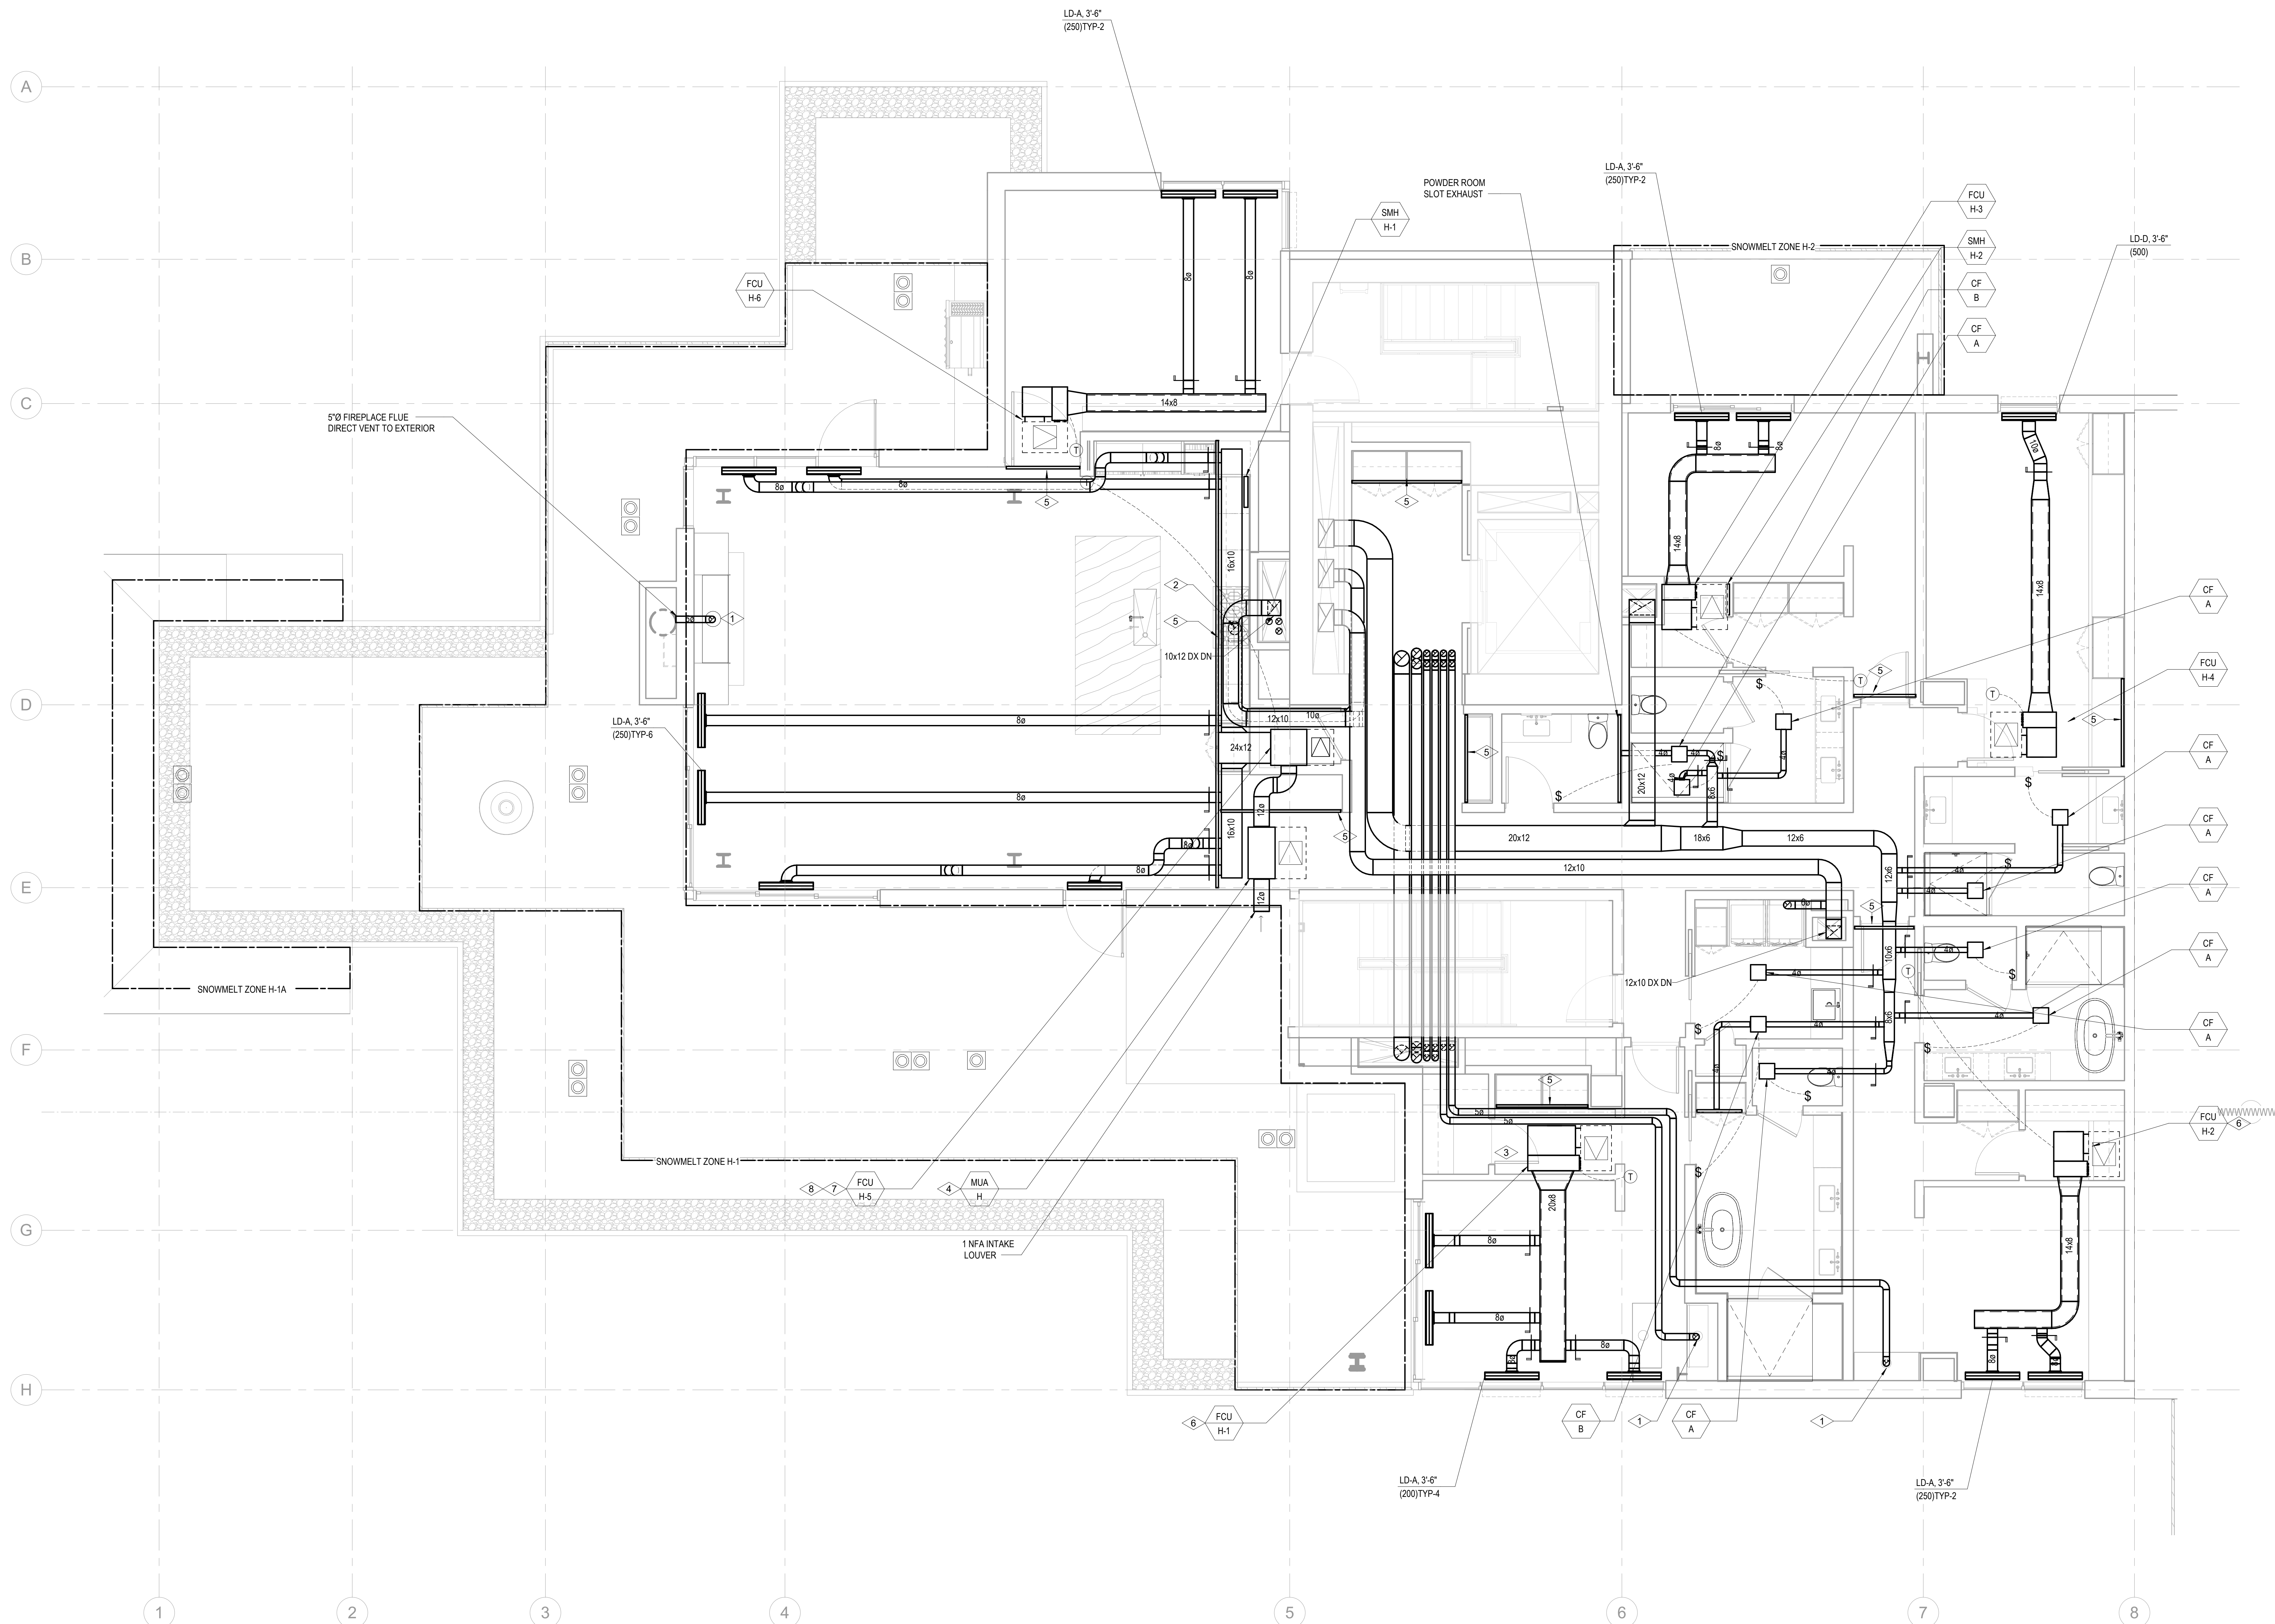

**1 TOWER A/B - MECHANICAL PLAN - UNIT H**  
SCALE: 1/4" = 1'-0"

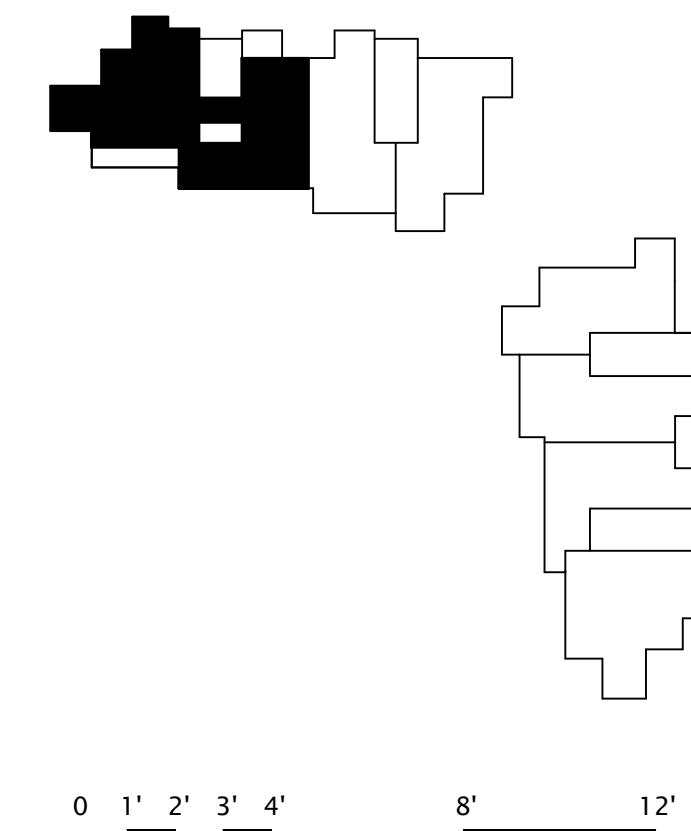



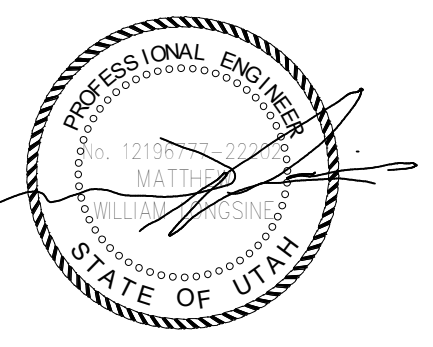

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**Accessibility Consultant**  
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**M/E/P Engineer**  
WSP USA  
1001 Fourth Ave., Suite 3100  
Seattle, WA 98154

principal architect \_\_\_\_\_  
project manager \_\_\_\_\_  
drawn by \_\_\_\_\_  
checked by \_\_\_\_\_  
job no. \_\_\_\_\_  
date 11/18/2022

revisions:  
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no. date by

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11/18/2022

ENLARGED MECHANICAL PLAN - UNIT I


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**SHEET NOTES:**


- A. CONFIRM EXACT LOCATION OF ALL WALL DEVICES WITH ARCHITECTURAL ELEVATIONS.
- B. CONFIRM ALL CEILING AND WALL ACCESS DOORS WITH ARCHITECTURAL ROOPS AND WALL ELEVATIONS.
- C. REFER TO M3-2A-01 THROUGH M3-2C-R FOR RADIANT FLOOR HWYSR PIPING ROUTING AND SIZING.
- D. PROVIDE 1-INCH ACOUSTIC LINING FOR ENTIRETY OF MAIN DUCT RUN OFF FAN COIL.
- E. ALL RESIDENTIAL TOILET EXHAUST, DRYER EXHAUST, AND KITCHEN RANGE HOOD EXHAUST TO BE PART OF A SUB-DUCT EXHAUST SYSTEM.
- F. ROUTE 3/4" CONDENSATE DRAINS FROM FCUS TO NEAREST SINK TAILPIECE.


**NUMBERED NOTES:**

- 1 5/8" CONCENTRIC FLUE TO GAS FIREPLACE. PROVIDE ORTAL IN-LINE 180 POWERVENT (120V/15A).
- 2 RANGE HOOD EXHAUST FAN TO BE INTEGRAL WITH RANGE SPECIFIED BY THE ARCHITECT. INTERLOCK CONTROL WITH MUA-A.
- 3 PROVIDE APRILAIRE 800 HUMIDIFIER. ASSUME 1/2" CW, 3/4" CD TO NEAREST SINK TAILPIECE, AND 120V ELECTRICAL CONNECTION.
- 4 2" RETURN AIR SLOT.
- 5 PROVIDE 120V 18A/1" CONNECTION FOR APRILAIRE 800 HUMIDIFIER DOWNSTREAM OF FAN COIL UNIT. REFER TO ELECTRICAL DRAWINGS FOR DETAIL. THIS IS AN OWNER OPTION. CONFIRM WITH OWNER AND ARCHITECT PRIOR TO PROVIDING HUMIDIFIER.

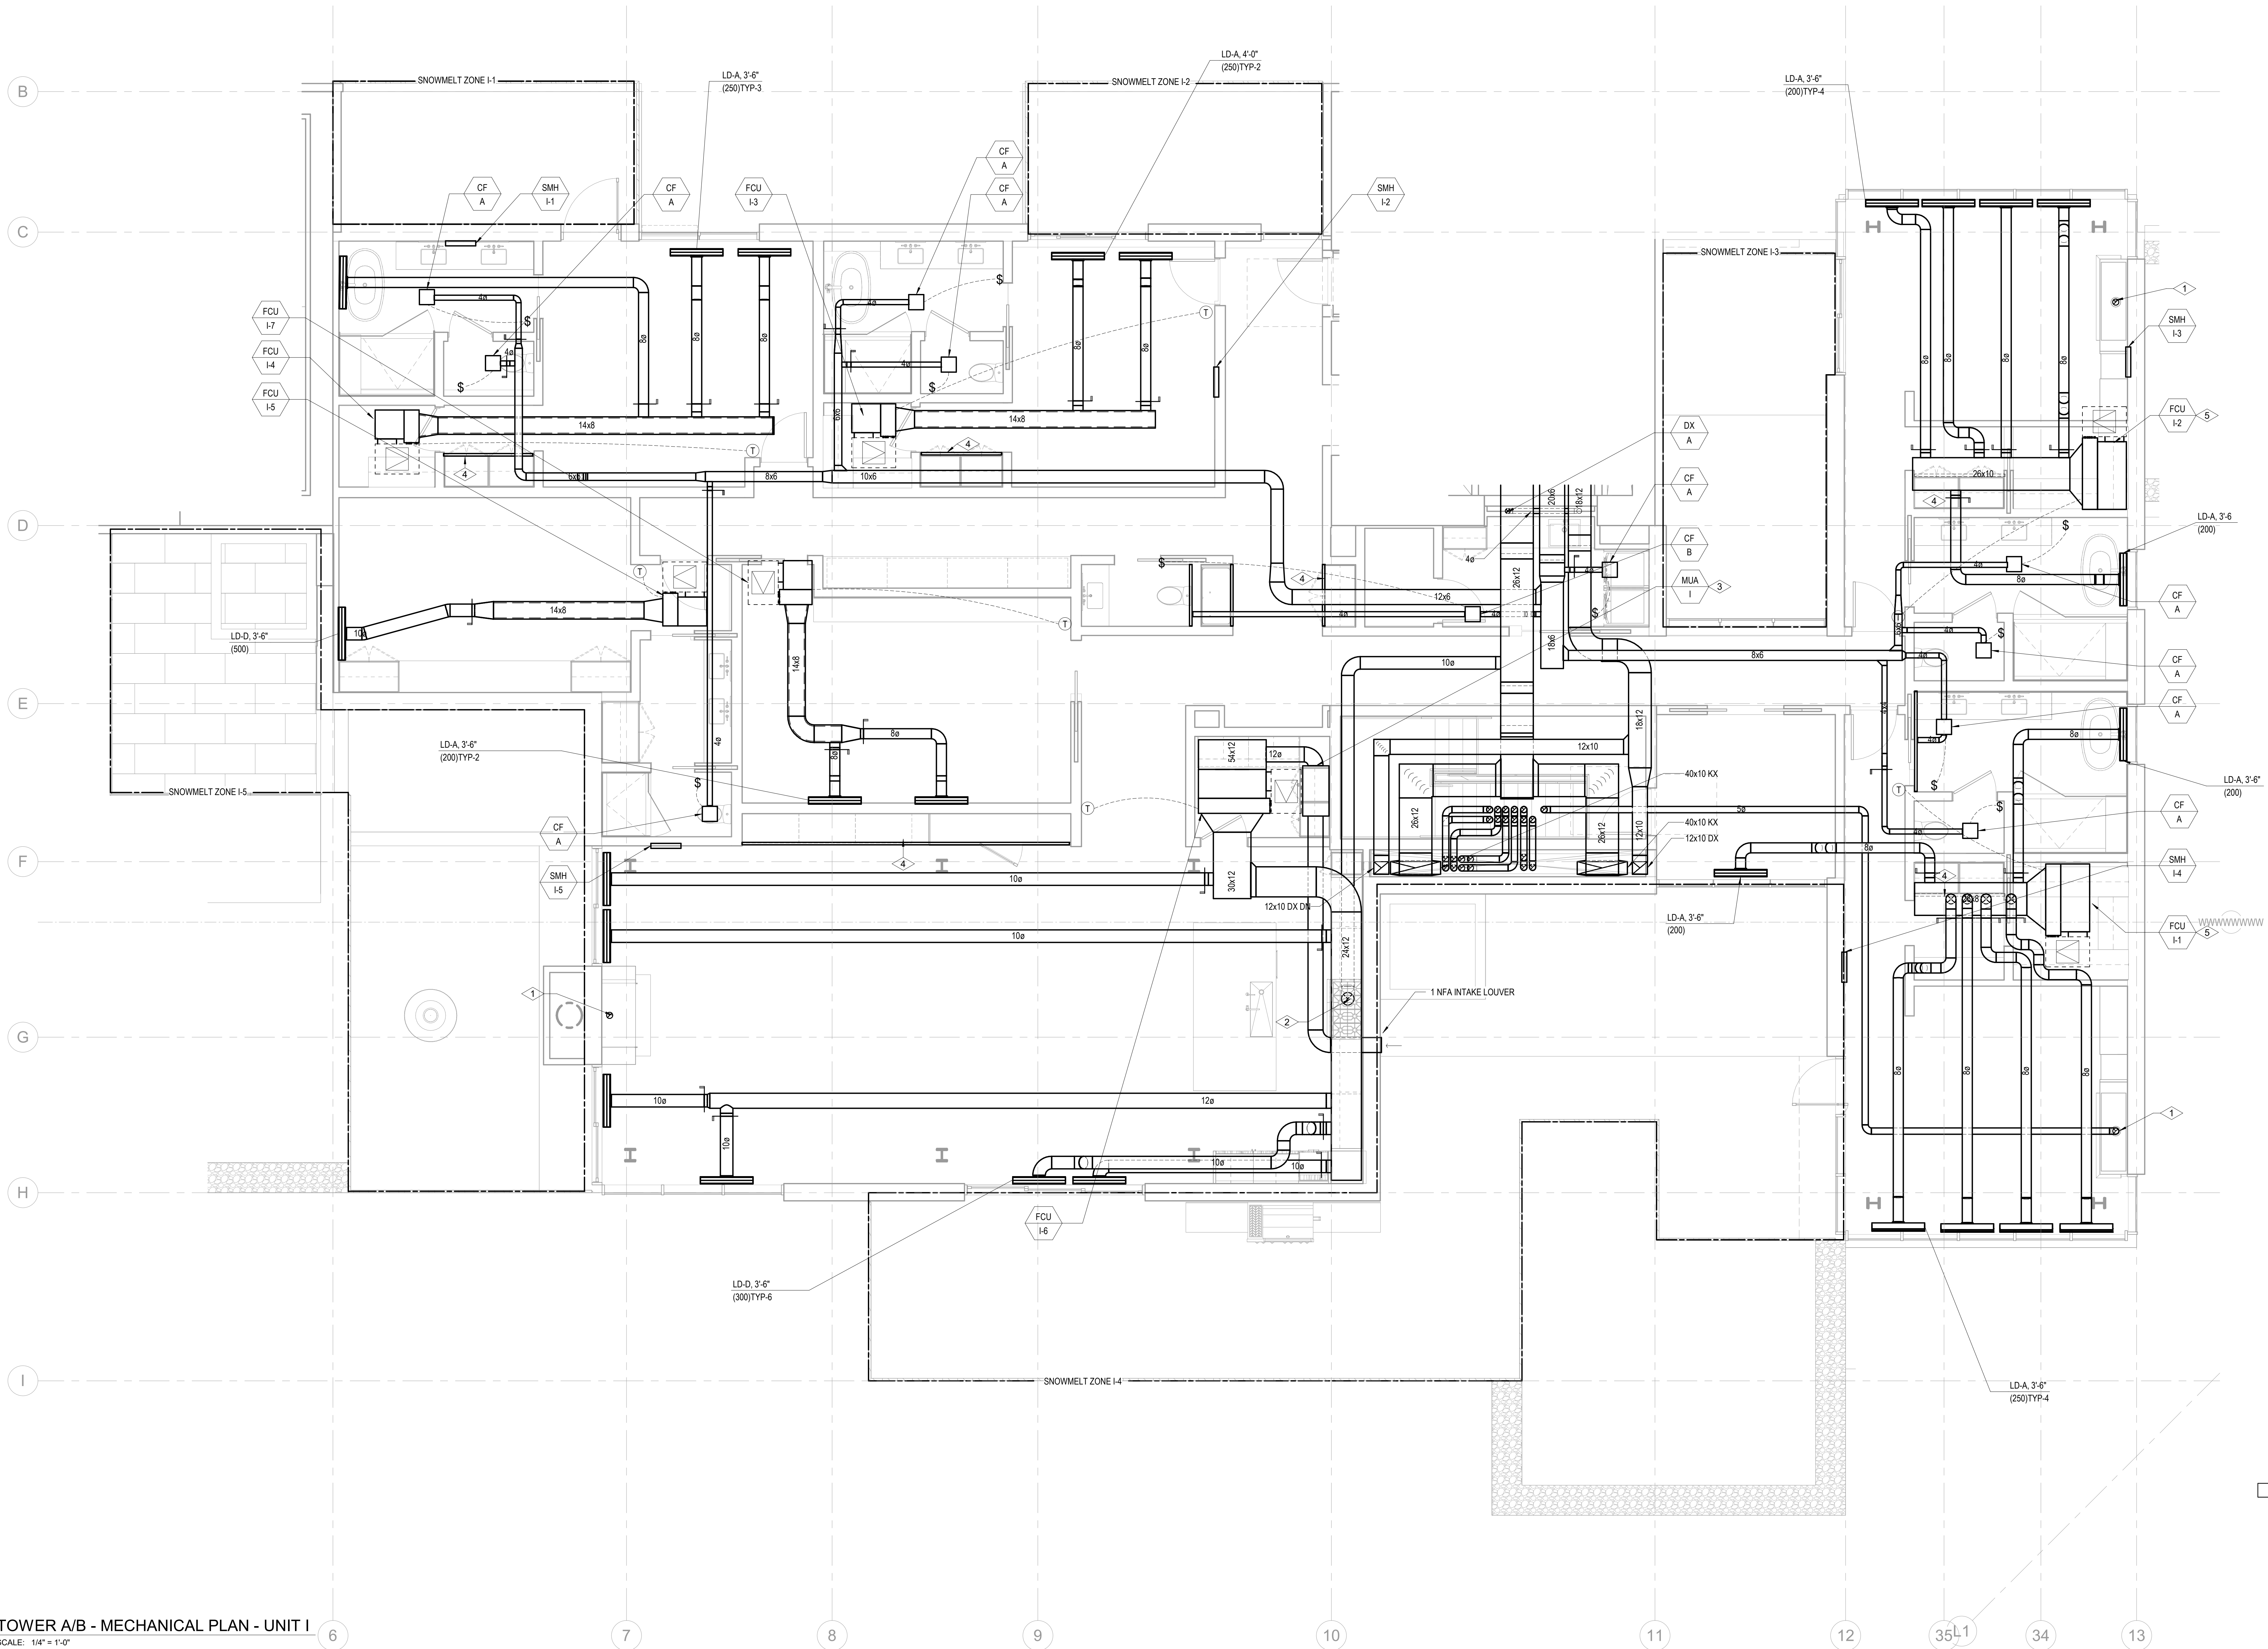

1 TOWER A/B - MECHANICAL PLAN - UNIT I  
SCALE: 1/4" = 1'-0"

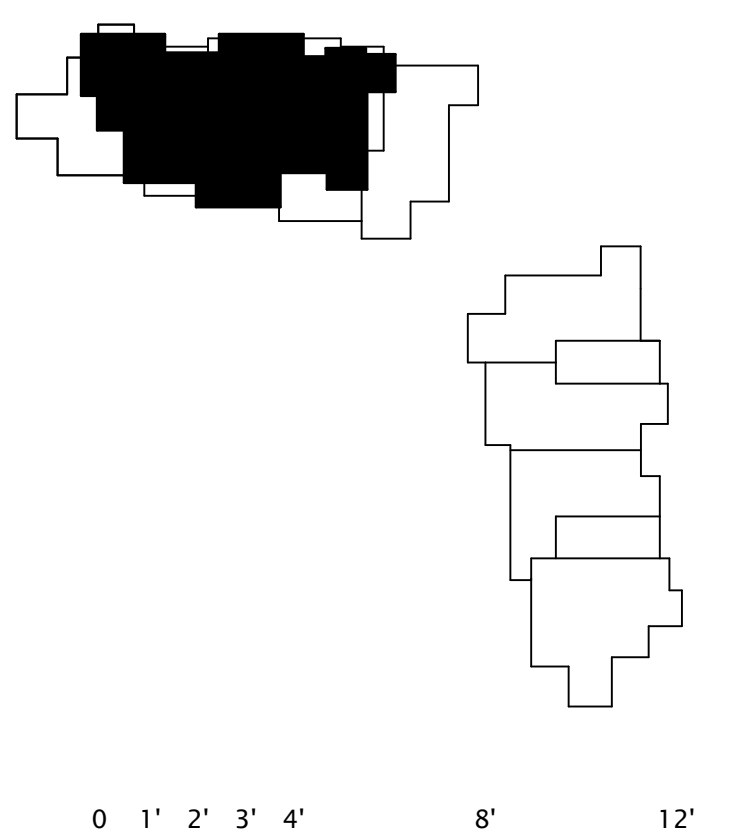

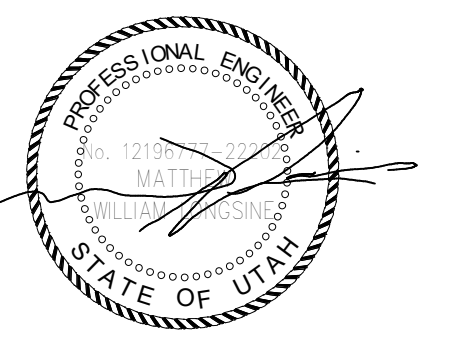

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**Vertical Transportation Consultant**  
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**MEP Engineer**  
WSP USA  
1001 Fourth Ave., Suite 3100  
Seattle, WA 98154

principal architect \_\_\_\_\_  
project manager \_\_\_\_\_  
drawn by \_\_\_\_\_  
checked by \_\_\_\_\_  
job no. \_\_\_\_\_  
date 11/18/2022

revisions:

no.	date	by

ISSUE FOR CONSTRUCTION  
11/18/2022

ENLARGED MECHANICAL PLAN - UNIT J


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**SHEET NOTES:**


- A. CONFIRM EXACT LOCATION OF ALL WALL DEVICES WITH ARCHITECTURAL ELEVATIONS.
- B. CONFIRM ALL CEILING AND WALL ACCESS DOORS WITH ARCHITECTURAL ROFS AND WALL ELEVATIONS.
- C. REFER TO M3-2A-01 THROUGH M3-2C-R FOR RADIANT FLOOR HWYSR PIPING ROUTING AND SIZING.
- D. PROVIDE 1-INCH ACOUSTIC LINING FOR ENTIRETY OF MAIN DUCT RUN OFF FAN COIL.
- E. ALL RESIDENTIAL TOILET EXHAUST, DRYER EXHAUST, AND KITCHEN RANGE HOOD EXHAUST TO BE PART OF A SUB-DUCT EXHAUST SYSTEM.
- F. ROUTE 3/4" CONDENSATE DRAINS FROM FCUS TO NEAREST SINK TAILPIPE.


**NUMBERED NOTES:**

- 1 RANGE HOOD EXHAUST FAN TO BE INEGRAL WITH RANGE SPECIFIED BY THE ARCHITECT. INTERLOCK CONTROL WITH MUA-A.
- 2 5/8" CONCENTRIC FLUE TO GAS FIREPLACE. PROVIDE ORTAL IN-LINE 180 POWERVENT (120V/15A).
- 3 ELECTRICAL RADIANT FLOOR TO BE PROVIDED IN MASTER BATHROOM. SEE ELECTRICAL DRAWINGS.
- 4 2" RETURN AIR SLOT
- 5 PROVIDE 120/16A/1 CONNECTION FOR APRILAIRE 800 HUMIDIFIER DOWNSTREAM OF FAN COIL UNIT. REFER TO ELECTRICAL DRAWINGS FOR DETAIL. THIS IS AN OWNER OPTION. CONFIRM WITH OWNER AND ARCHITECT PRIOR TO PROVIDING HUMIDIFIER.
- 6 PROVIDE 208/16A/1 CONNECTION FOR APRILAIRE 800 HUMIDIFIER DOWNSTREAM OF FAN COIL UNIT. REFER TO ELECTRICAL DRAWINGS FOR DETAIL. THIS IS AN OWNER OPTION. CONFIRM WITH OWNER AND ARCHITECT PRIOR TO PROVIDING HUMIDIFIER.
- 7 VERTICAL FAN COIL UNIT

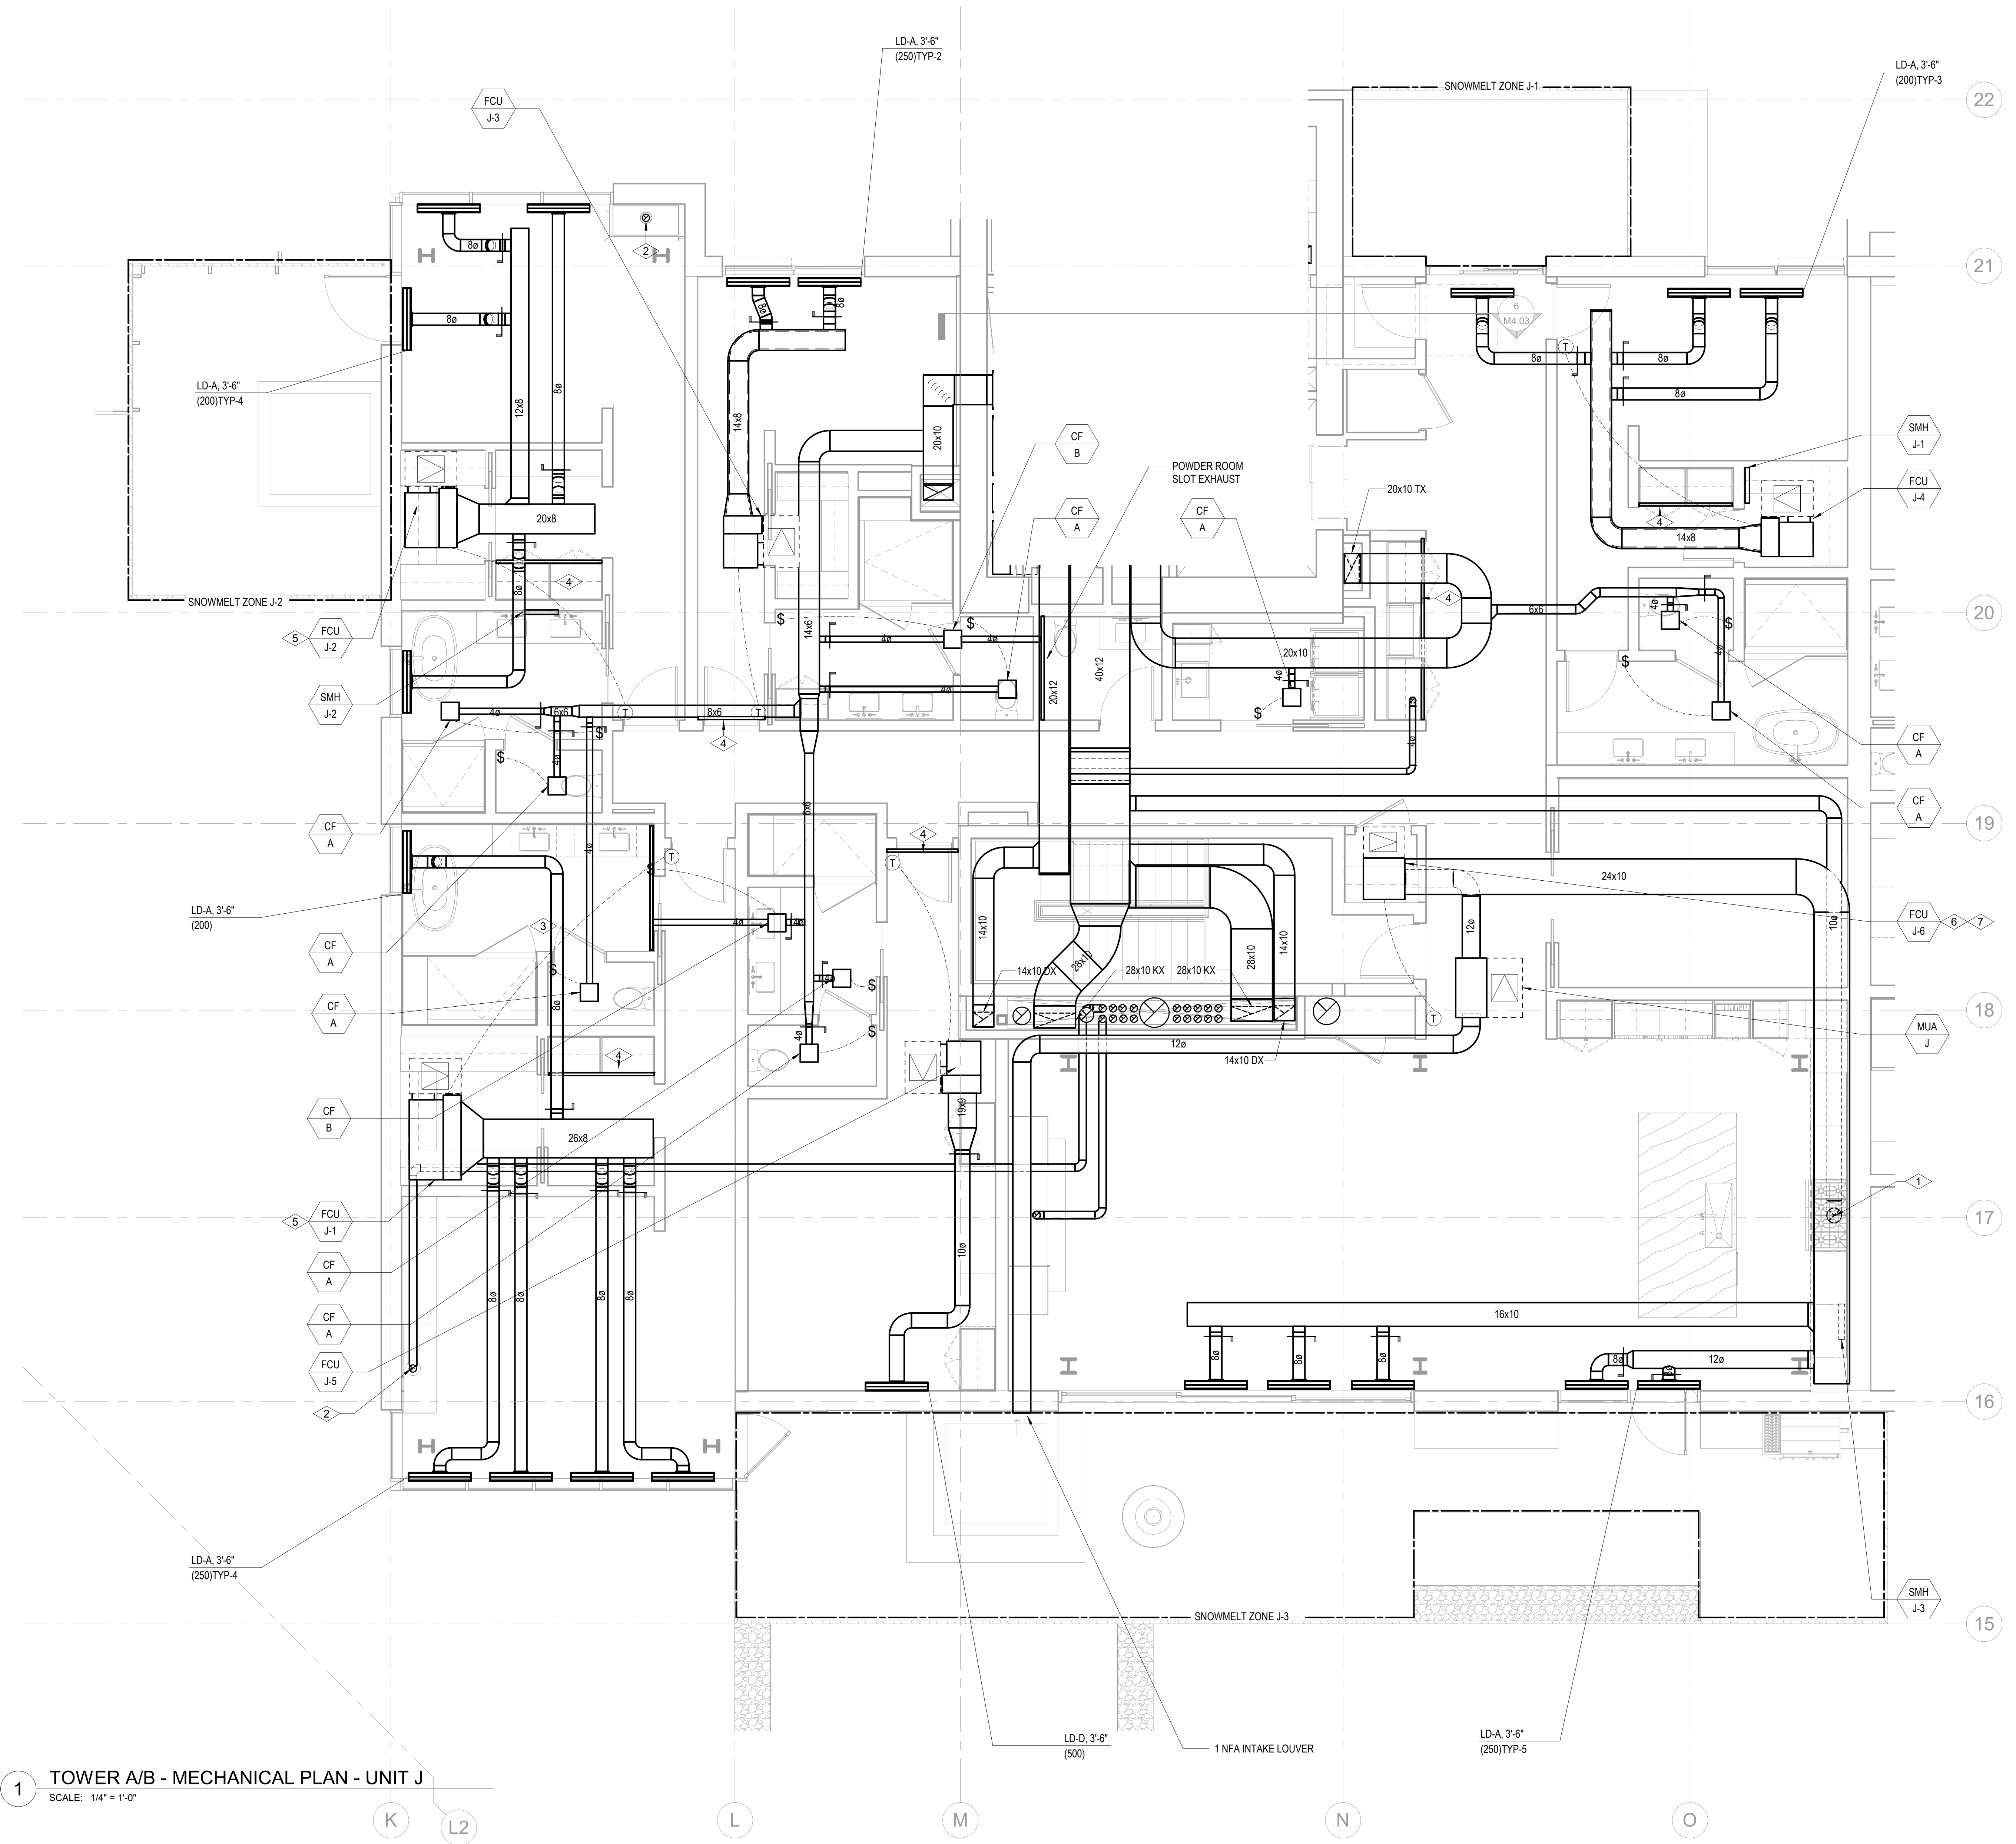

1 TOWER A/B - MECHANICAL PLAN - UNIT J  
SCALE: 1/4" = 1'-0"

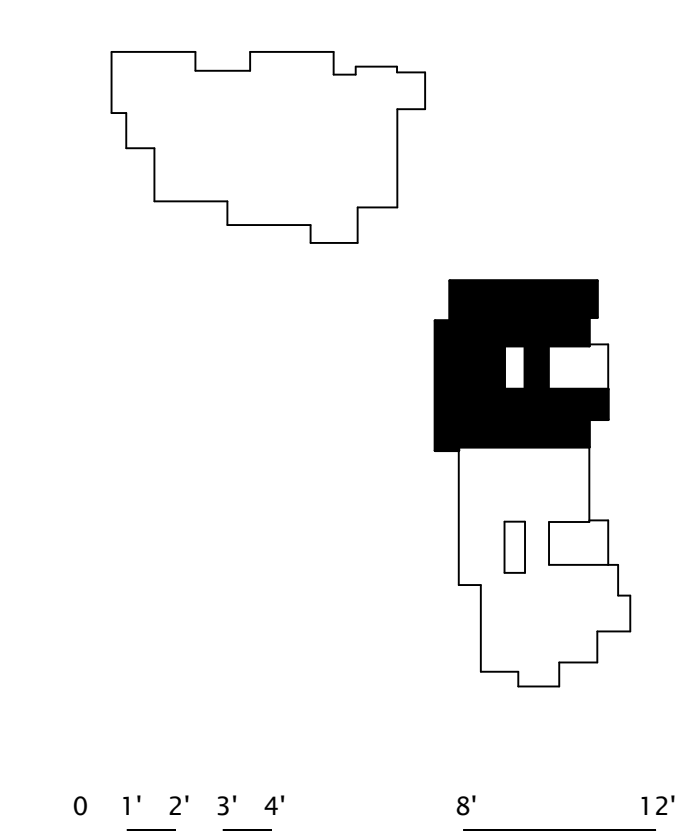

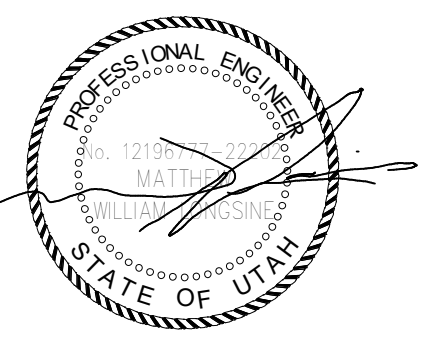

Reserved for permit stamp

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**MEP Engineer**  
WSP USA  
1001 Fourth Ave., Suite 3100  
Seattle, WA 98154

principal architect \_\_\_\_\_  
project manager \_\_\_\_\_  
drawn by \_\_\_\_\_  
checked by \_\_\_\_\_  
date 11/18/2022

revisions:  
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no. date by

ISSUE FOR CONSTRUCTION  
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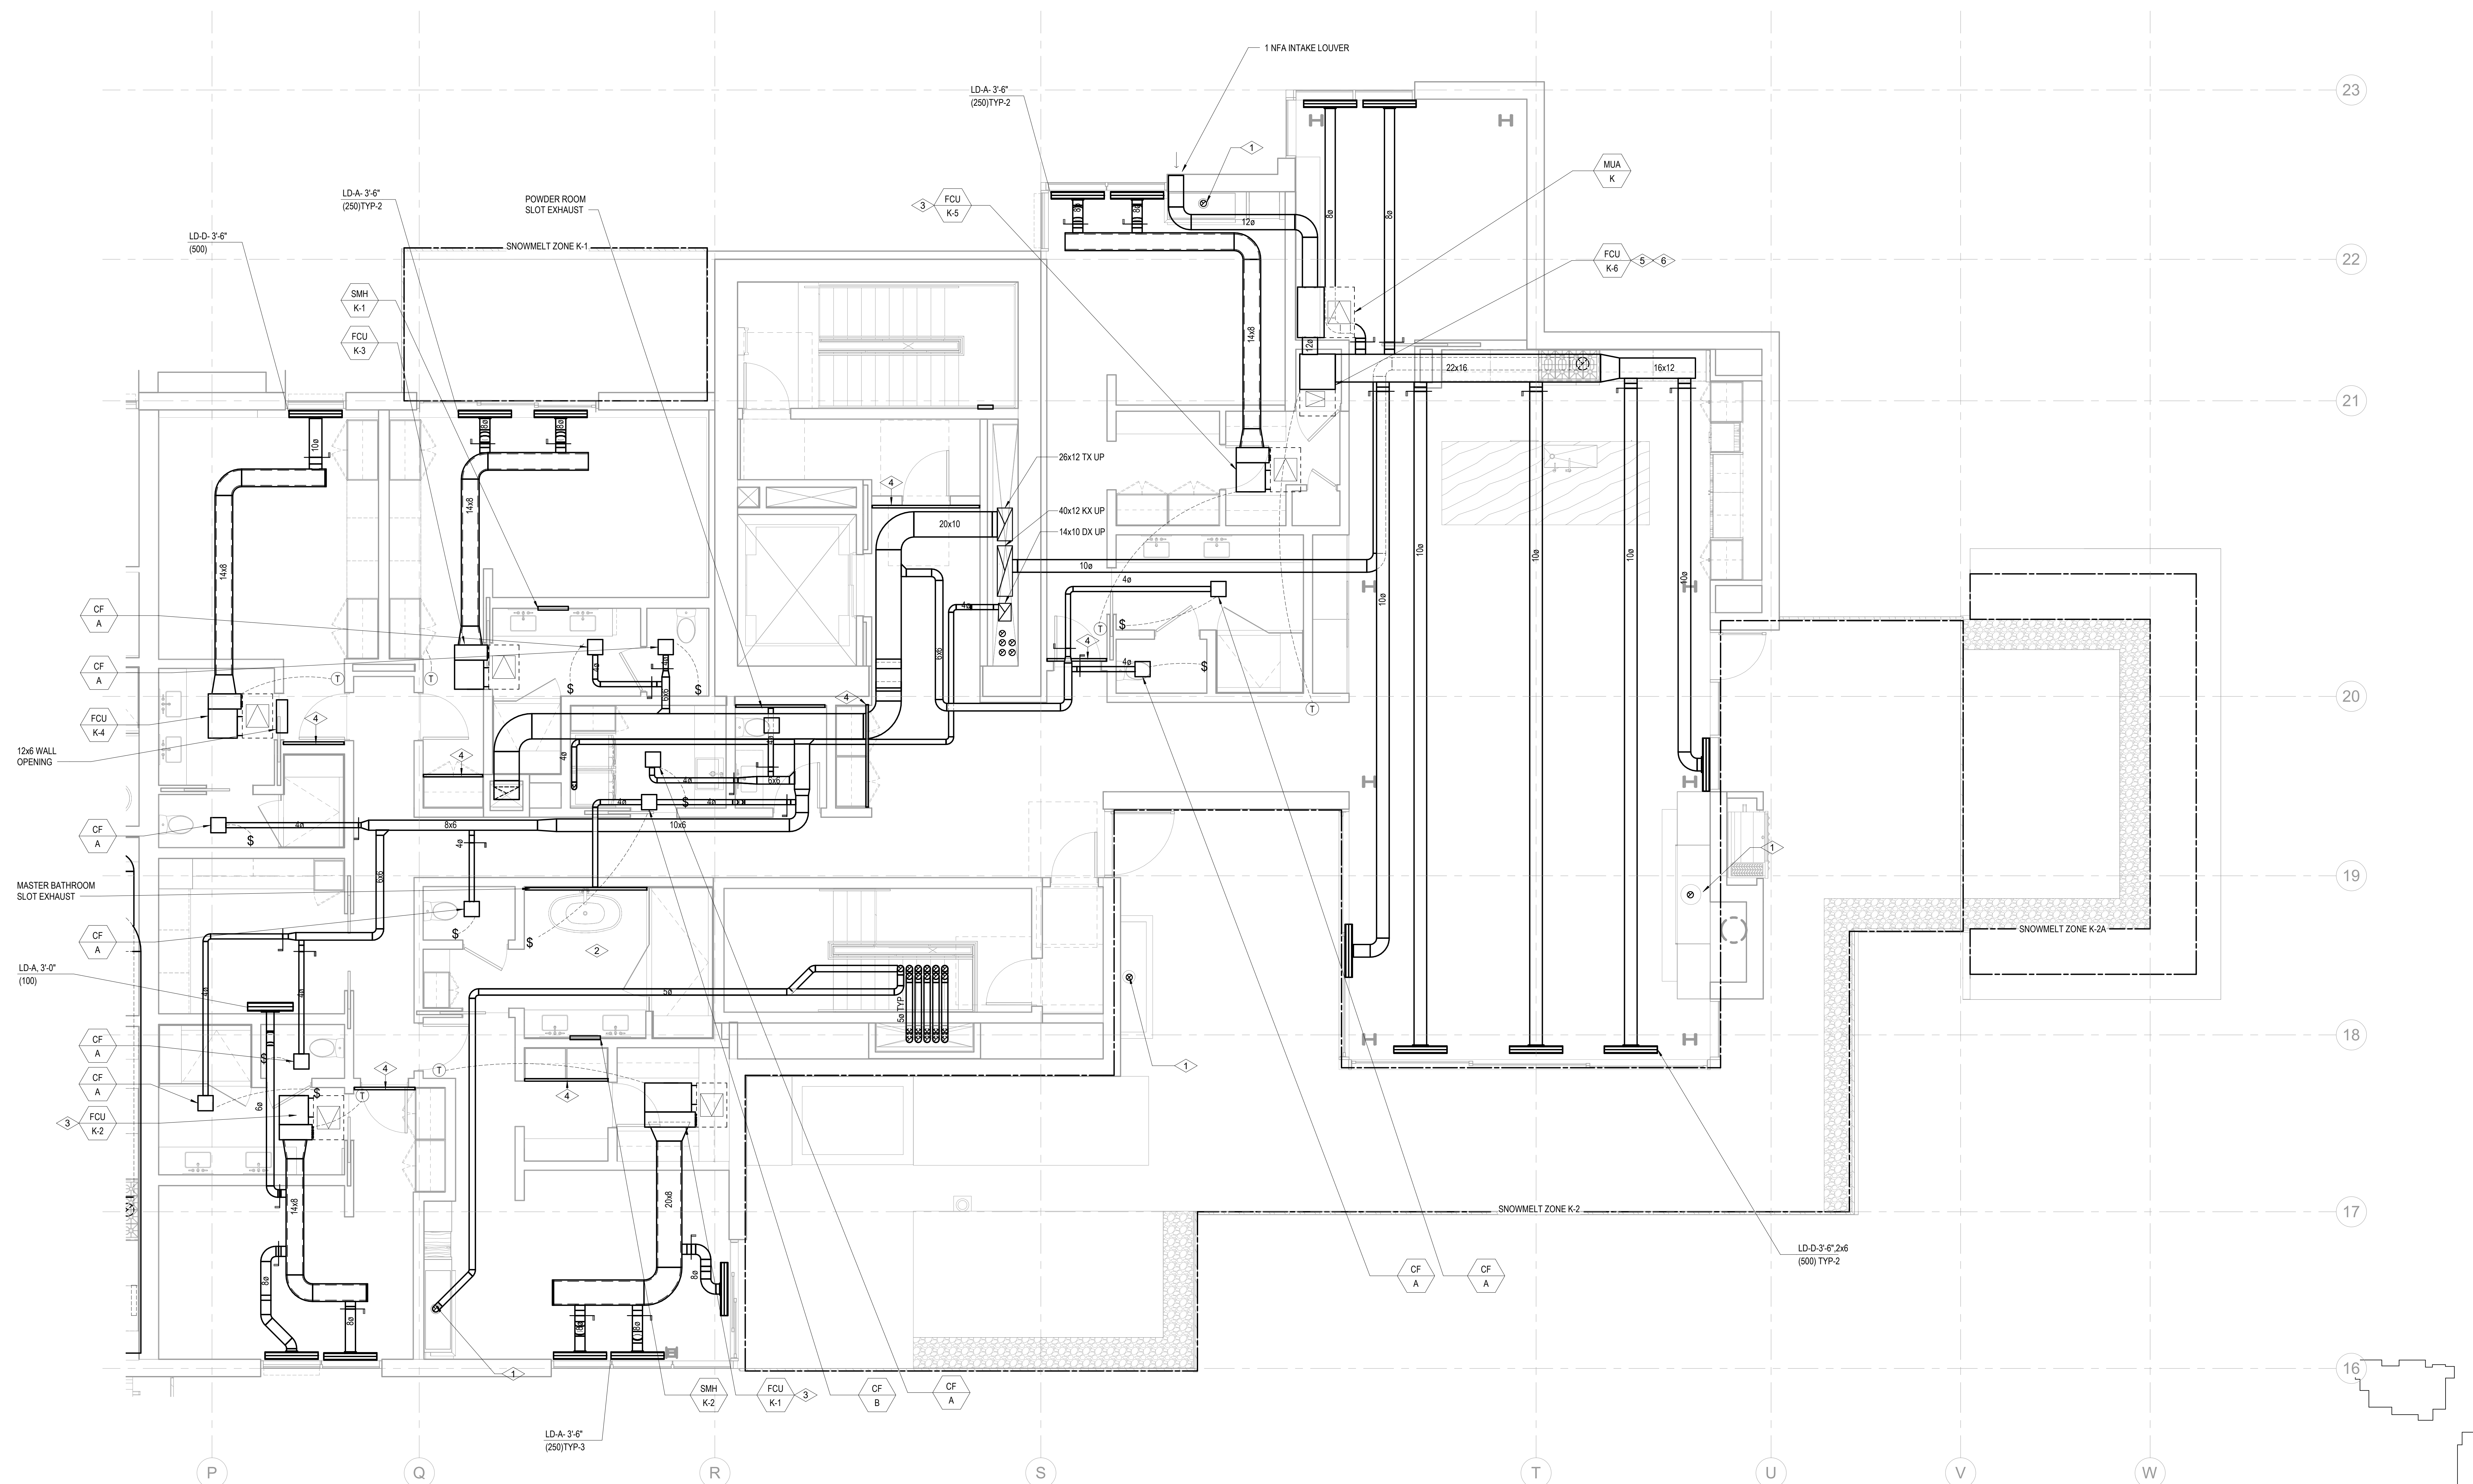
ENLARGED MECHANICAL PLAN - UNIT K  
**M2.4.K**

**SHEET NOTES:**

- A. CONFIRM EXACT LOCATION OF ALL WALL DEVICES WITH ARCHITECTURAL ELEVATIONS.
- B. CONFIRM ALL CEILING AND WALL ACCESS DOORS WITH ARCHITECTURAL ROFS AND WALL ELEVATIONS.
- C. REFER TO M3-2A-01 THROUGH M3-2C-R FOR RADIANT FLOOR HW/SR PIPING ROUTING AND SIZING.
- D. PROVIDE 1-INCH ACOUSTIC LINING FOR ENTIRETY OF MAIN DUCT RUN OFF FAN COIL.
- E. ALL RESIDENTIAL TOILET EXHAUST, DRYER EXHAUST, AND KITCHEN RANGE HOOD EXHAUST TO BE PART OF A SUB-DUCT EXHAUST SYSTEM.
- F. ROUTE 3/4" CONDENSATE DRAINS FROM FCUS TO NEAREST SINK TAILPIECE.


**NUMBERED NOTES:**

- 1 5/8" CONCENTRIC FLUE TO GAS FIREPLACE. PROVIDE ORTAL IN-LINE 180 POWERVENT (120V/15A).
- 2 ELECTRICAL RADIANT FLOOR TO BE PROVIDED IN MASTER BATHROOM. SEE ELECTRICAL DRAWINGS.
- 3 PROVIDE 120/16A/1 CONNECTION FOR APRILAIRE 800 HUMIDIFIER DOWNSTREAM OF FAN COIL UNIT. REFER TO ELECTRICAL DRAWINGS FOR DETAIL. THIS IS AN OWNER OPTION. CONFIRM WITH OWNER AND ARCHITECT PRIOR TO PROVIDING HUMIDIFIER.
- 4 2" RETURN AIR SLOT.
- 5 PROVIDE 208/16A/1 CONNECTION FOR APRILAIRE 800 HUMIDIFIER DOWNSTREAM OF FAN COIL UNIT. REFER TO ELECTRICAL DRAWINGS FOR DETAIL. THIS IS AN OWNER OPTION. CONFIRM WITH OWNER AND ARCHITECT PRIOR TO PROVIDING HUMIDIFIER.
- 6 VERTICAL FAN COIL UNIT.



**1 TOWER A/B - MECHANICAL PLAN - UNIT K**  
SCALE: 1/4" = 1'-0"



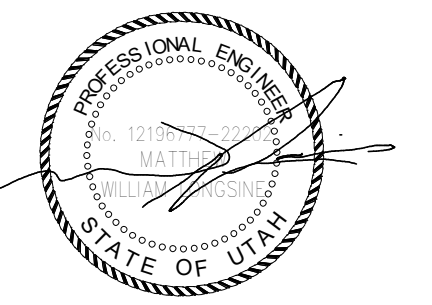

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EPG Design  
6849 South High Tech Drive, Suite 100  
Midvale, Utah 84047
- Specifications Writer**  
Friday Group  
88 Main Street  
Middlebury, VT
- Code Consultant**  
Holmes  
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- Fire Protection Engineer**  
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1519 SE 8th Ave, Suite 210  
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- Building Envelope Consultant**  
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- Accessibility Consultant**  
Studio Pacifica  
2144 Westlake Ave N, Suite F  
Seattle, WA 98109
- MEP Engineer**  
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1011 Fourth Ave, Suite 3100  
Seattle, WA 98154

principal architect \_\_\_\_\_  
project manager \_\_\_\_\_  
drawn by \_\_\_\_\_  
checked by \_\_\_\_\_  
job no. \_\_\_\_\_  
date 11/18/2022  
revisions:  
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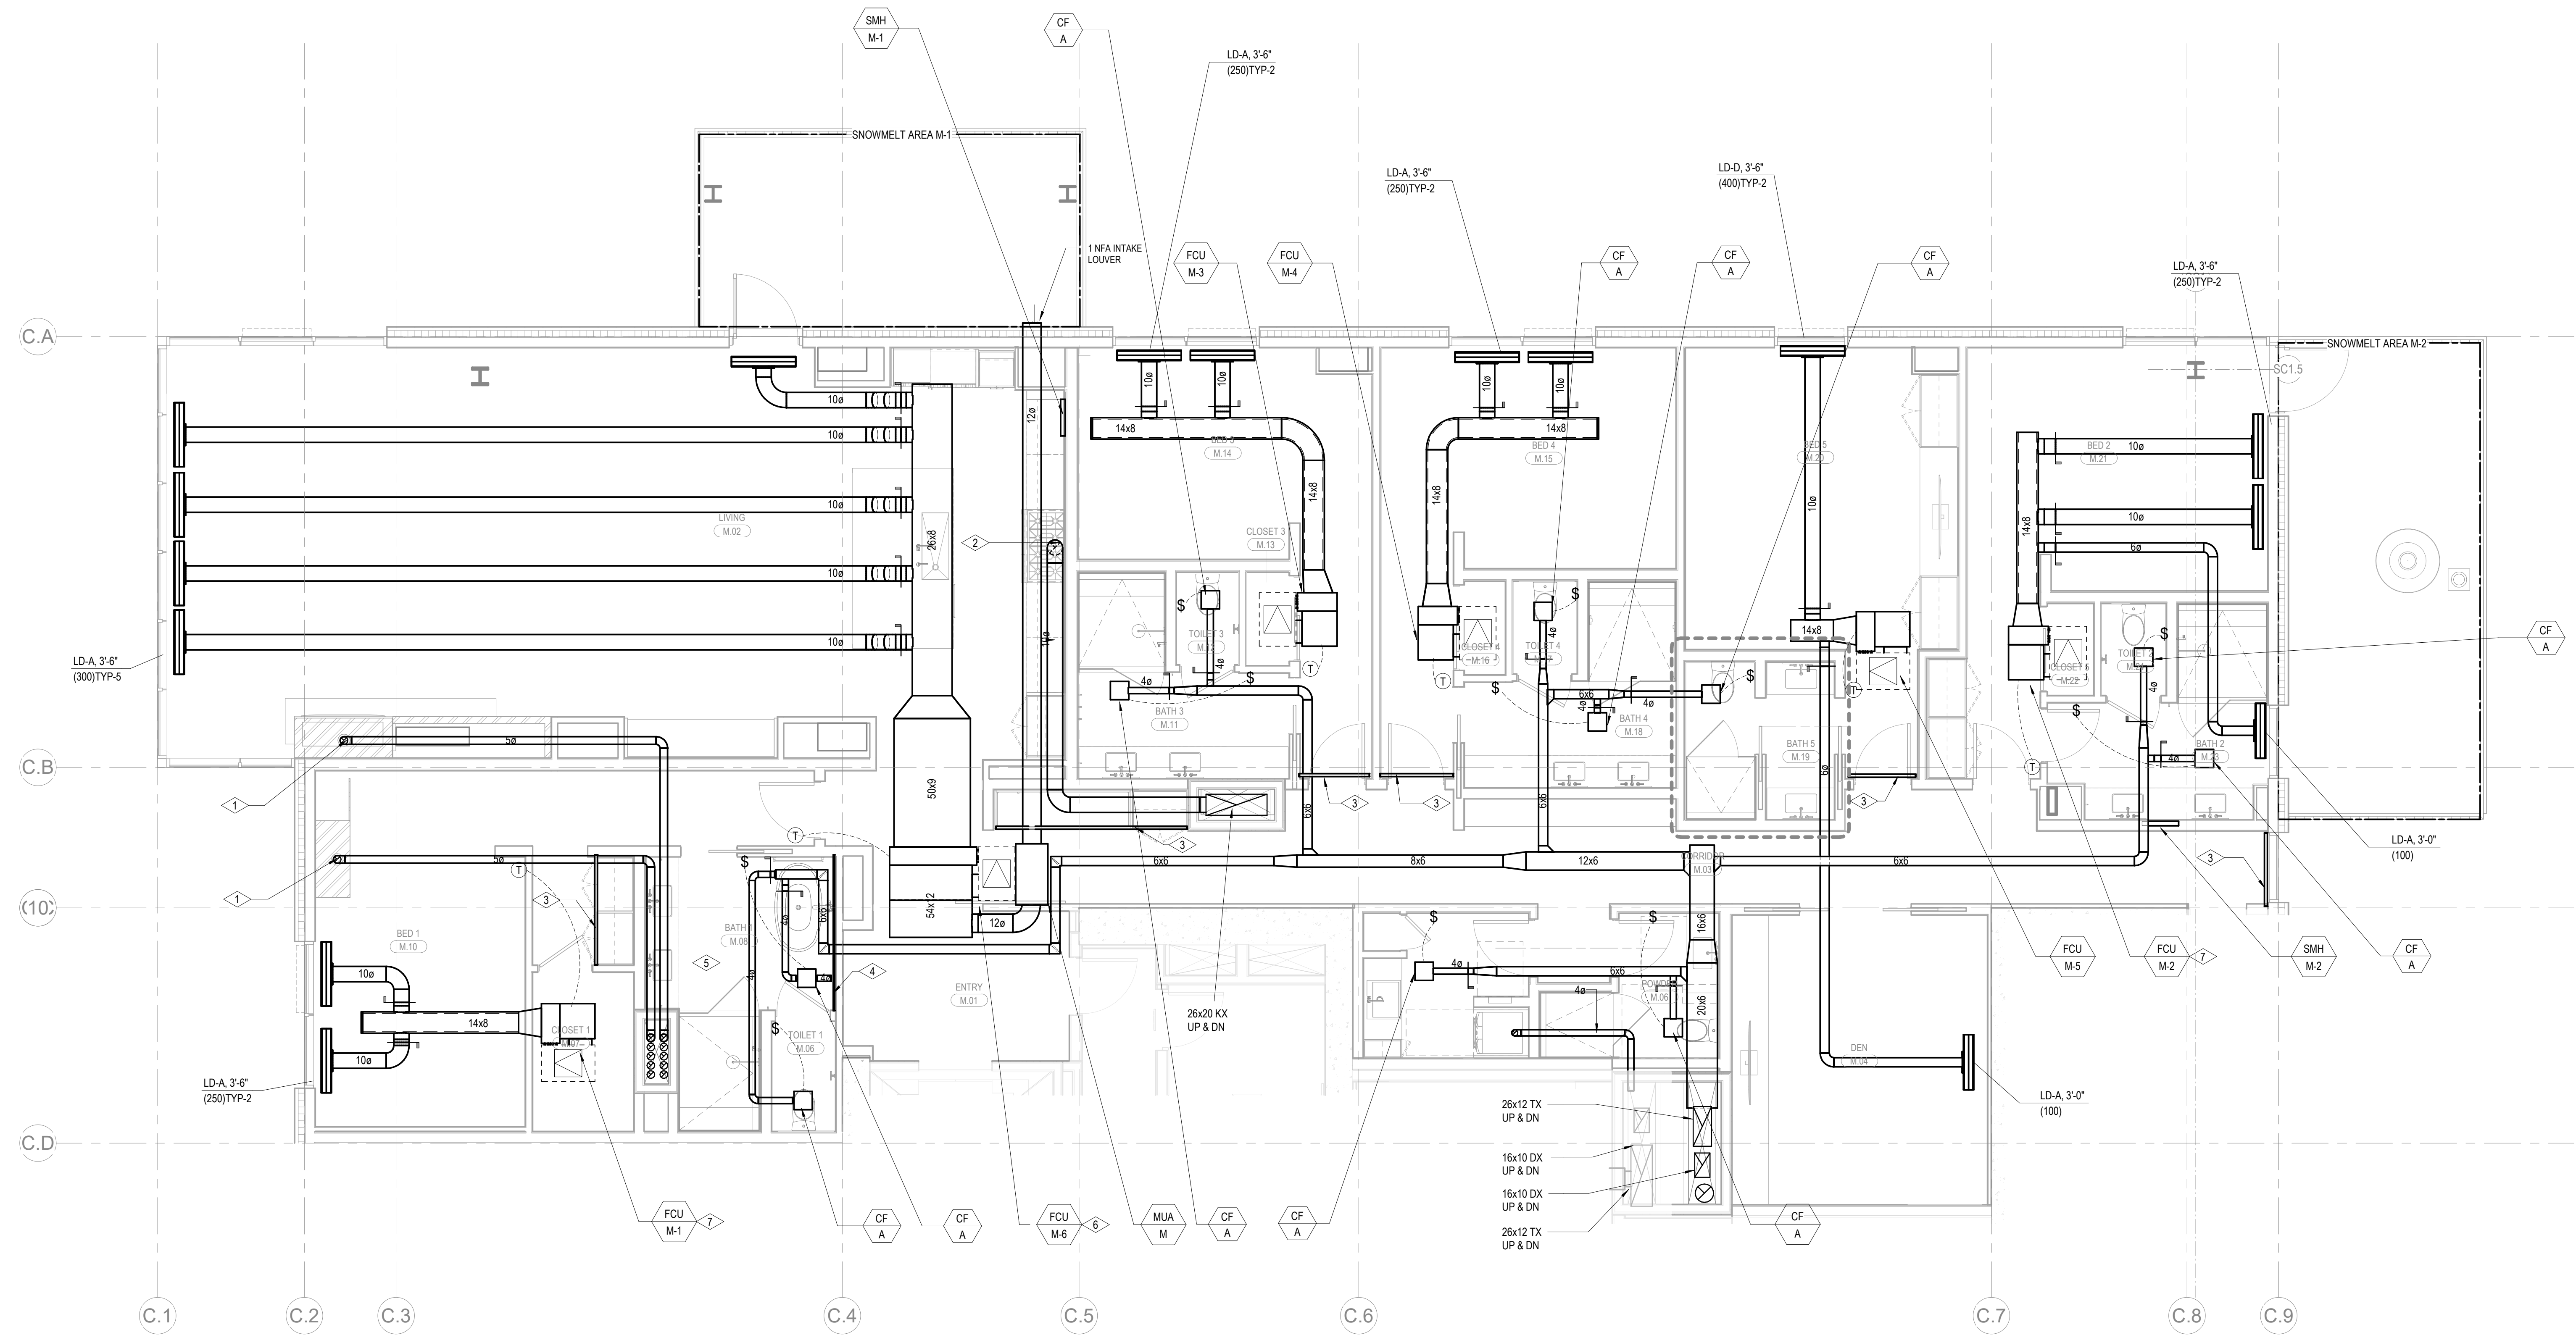
ENLARGED MECHANICAL PLAN - UNIT M  
**M2.4.M**

**SHEET NOTES:**


- A. CONFIRM EXACT LOCATION OF ALL WALL DEVICES WITH ARCHITECTURAL ELEVATIONS.
- B. CONFIRM ALL CEILING AND WALL ACCESS DOORS WITH ARCHITECTURAL RCPs AND WALL ELEVATIONS.
- C. REFER TO M3-2A-01 THROUGH M3-2C-R FOR RADIANT FLOOR HYDR PIPING ROUTING AND SIZING.
- D. PROVIDE 1-INCH ACOUSTIC LINING FOR ENTIRETY OF MAIN DUCT RUN OFF FAN COIL.
- E. ROUTE 3/4" CONDENSATE DRAINS FROM FCUS TO NEAREST TAILPIECE.


**NUMBERED NOTES:**

- 1 5/8" CONCENTRIC FLUE TO GAS FIREPLACE. PROVIDE ORTAL IN LINE 180 POWERVENT (120/15A).
- 2 RANGE HOOD EXHAUST FAN TO BE INTEGRAL WITH RANGE SPECIFIED BY THE ARCHITECT.
- 3 INTERLOCK CONTROL WITH M.J.A.
- 4 2" RETURN AIR SLOT.
- 5 1" RETURN AIR SLOT.
- 6 ELECTRICAL RADIANT FLOOR TO BE PROVIDED IN MASTER BATHROOM. SEE ELECTRICAL DRAWINGS.
- 7 PROVIDE 200/15A/1 CONNECTION FOR APRILAIRE 800 HUMIDIFIER DOWNSTREAM OF FAN COIL UNIT. REFER TO ELECTRICAL DRAWINGS FOR DETAIL. THIS IS AN OWNER OPTION. CONFIRM WITH OWNER AND ARCHITECT PRIOR TO PROVIDING HUMIDIFIER.
- 8 PROVIDE 120/15A/1 CONNECTION FOR APRILAIRE 800 HUMIDIFIER DOWNSTREAM OF FAN COIL UNIT. REFER TO ELECTRICAL DRAWINGS FOR DETAIL. THIS IS AN OWNER OPTION. CONFIRM WITH OWNER AND ARCHITECT PRIOR TO PROVIDING HUMIDIFIER.



1 BLDG C - MECHANICAL UNIT PLAN - M  
SCALE: 1/4" = 1'-0"

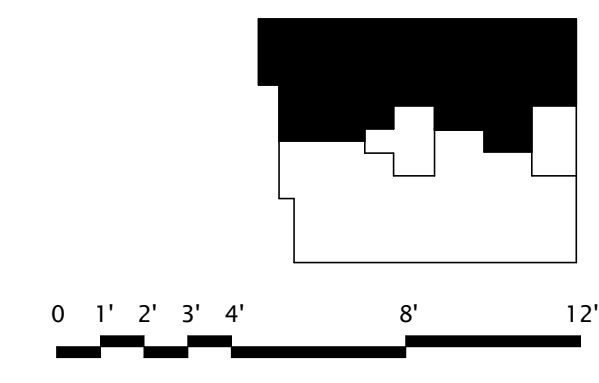

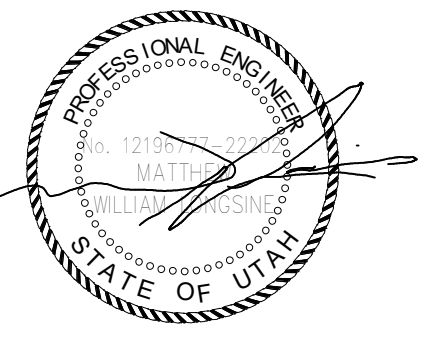

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**MEP Engineer**  
WSP USA  
1001 Fourth Ave., Suite 3100  
Seattle, WA 98154

principal architect \_\_\_\_\_  
project manager \_\_\_\_\_  
drawn by \_\_\_\_\_  
checked by \_\_\_\_\_  
job no. \_\_\_\_\_  
date 11/18/2022

revisions:  
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no. date by

**ISSUE FOR CONSTRUCTION**  
11/18/2022


**ENLARGED MECHANICAL DUCT PLAN - UNIT P**  
**M2.4.P**

**SHEET NOTES:**


- A. CONFIRM EXACT LOCATION OF ALL WALL DEVICES WITH ARCHITECTURAL ELEVATIONS.
- B. CONFIRM ALL CEILING AND WALL ACCESS DOORS WITH ARCHITECTURAL ROFS AND WALL ELEVATIONS.
- C. REFER TO M3-2A-01 THROUGH M3-2C-R FOR RADIANT FLOOR HWYSR PIPING ROUTING AND SIZING.
- D. PROVIDE 1-INCH ACOUSTIC LINING FOR ENTRITRY OF MAIN DUCT RUN OFF FAN COIL.
- E. ALL RESIDENTIAL TOILET EXHAUST, DRYER EXHAUST, AND KITCHEN RANGE HOOD EXHAUST TO BE PART OF A SUB-DUCT EXHAUST SYSTEM.
- F. ROUTE 3/4" CONDENSATE DRAINS FROM FCUS TO NEAREST SINK TAILPIECE.


**NUMBERED NOTES:**

- 1 RANGE HOOD EXHAUST FAN TO BE INTEGRAL WITH RANGE SPECIFIED BY THE ARCHITECT. INTERLOCK CONTROL WITH MUA-A.
- 2 ELECTRICAL RADIANT FLOOR TO BE PROVIDED IN MASTER BATHROOM. SEE ELECTRICAL DRAWINGS.
- 3 PROVIDE APRILAIRE 800 HUMIDIFIER. ASSUME 1/2" CW, 3/4" CD TO NEAREST SINK TAILPIECE. AND 120/1 ELECTRICAL CONNECTION
- 4 PROVIDE 208/16A/1 CONNECTION FOR APRILAIRE 800 HUMIDIFIER DOWNSTREAM OF FAN COIL UNIT. REFER TO ELECTRICAL DRAWINGS FOR DETAIL. THIS IS AN OWNER OPTION. CONFIRM WITH OWNER AND ARCHITECT PRIOR TO PROVIDING HUMIDIFIER
- 5 2" RETURN AIR SLOT
- 6 PROVIDE 120/16A/1 CONNECTION FOR APRILAIRE 800 HUMIDIFIER DOWNSTREAM OF FAN COIL UNIT. REFER TO ELECTRICAL DRAWINGS FOR DETAIL. THIS IS AN OWNER OPTION. CONFIRM WITH OWNER AND ARCHITECT PRIOR TO PROVIDING HUMIDIFIER

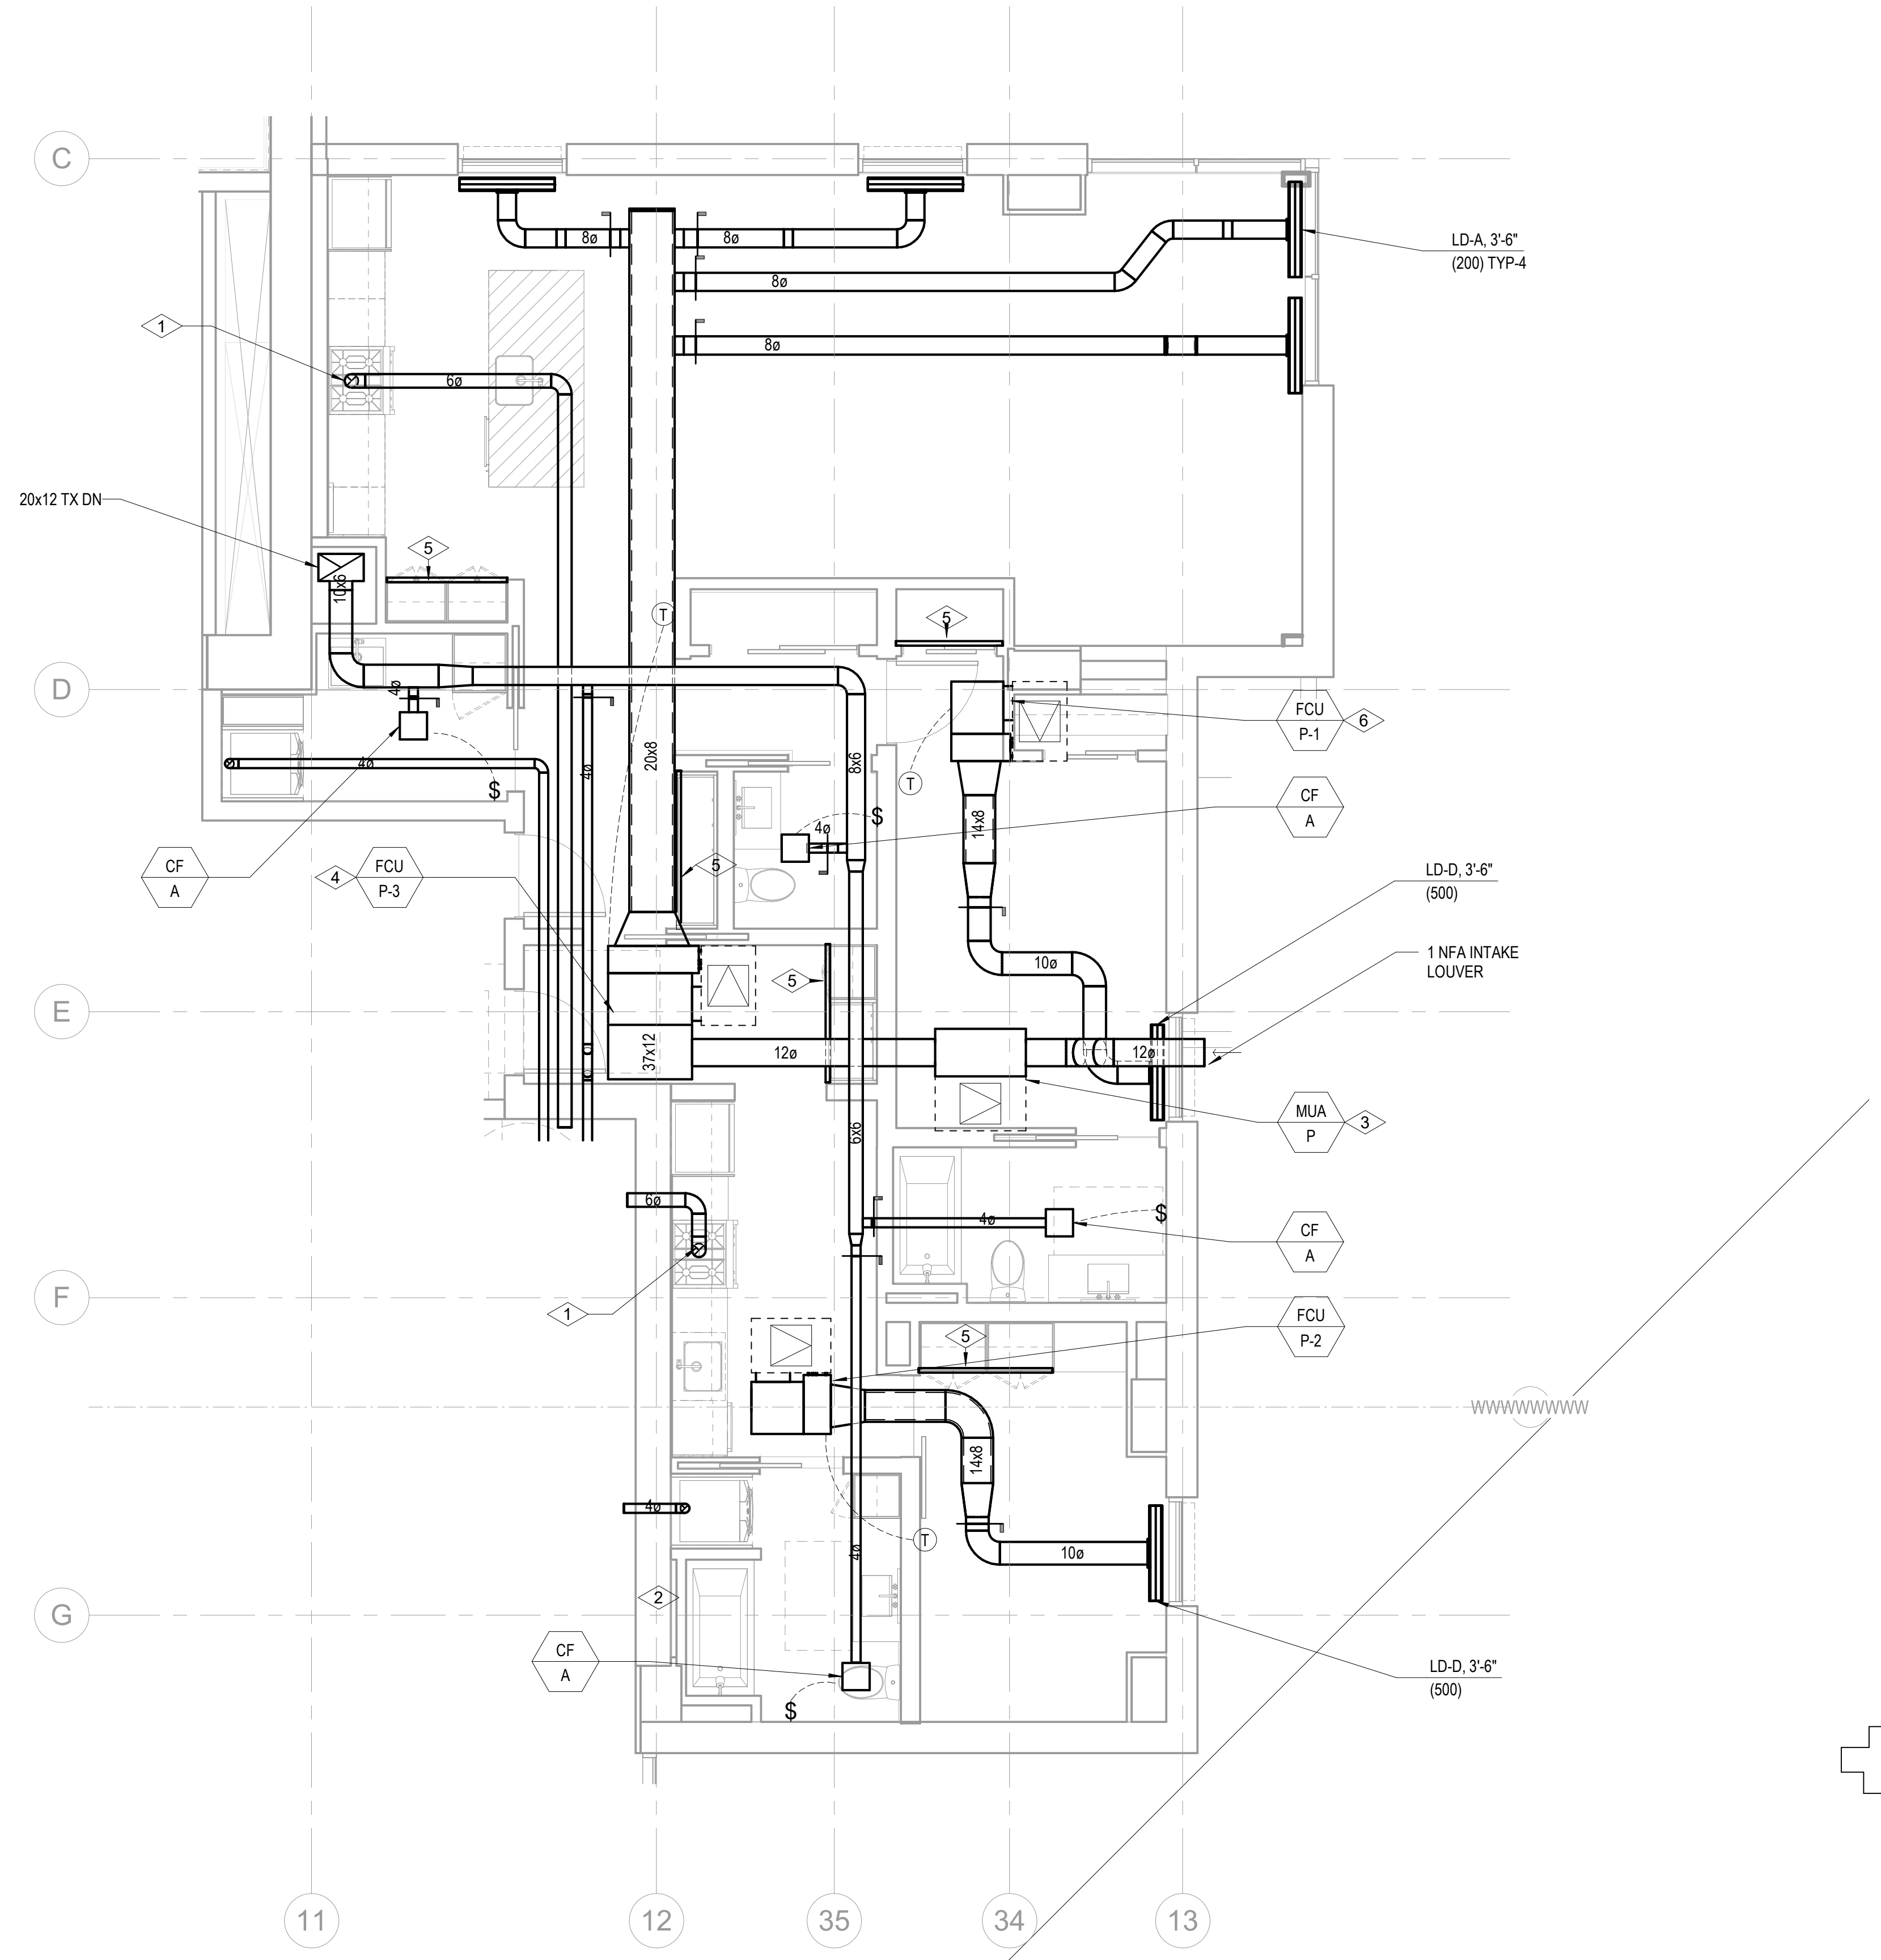

**1 TOWER A/B - MECHANICAL PLAN - UNIT P**  
SCALE: 1/4" = 1'-0"

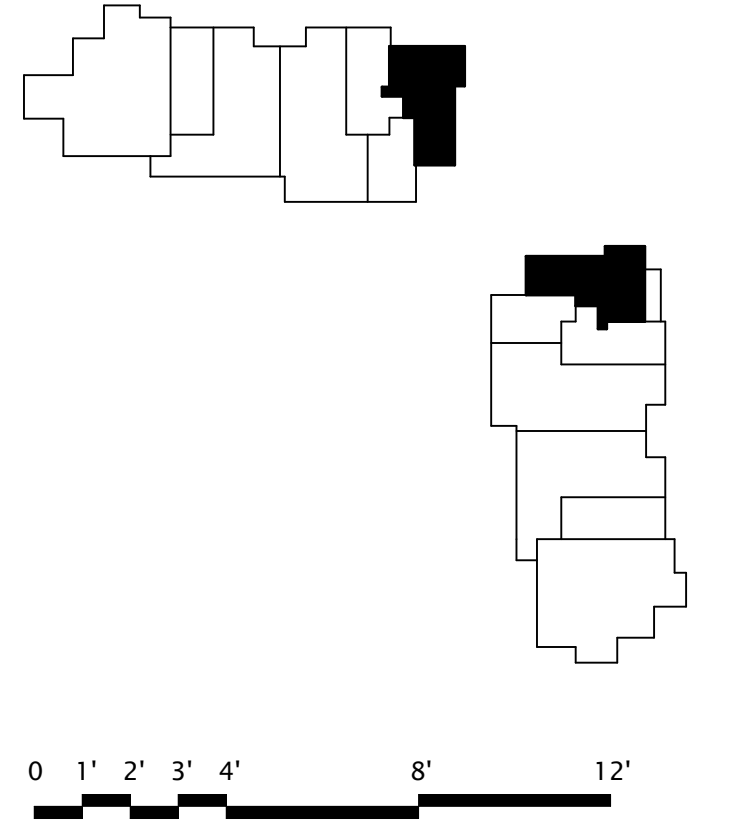

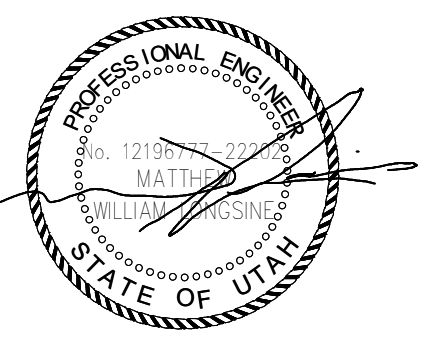

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principal architect \_\_\_\_\_  
project manager \_\_\_\_\_  
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11/18/2022

ENLARGED MECHANICAL DUCT PLAN - UNIT Q


M2.4.Q

**SHEET NOTES:**

- A. CONFIRM EXACT LOCATION OF ALL WALL DEVICES WITH ARCHITECTURAL ELEVATIONS.
- B. CONFIRM ALL CEILING AND WALL ACCESS DOORS WITH ARCHITECTURAL ROFS AND WALL ELEVATIONS.
- C. REFER TO M3-2A-01 THROUGH M3-2C-R FOR RADIANT FLOOR HWYSR PIPING ROUTING AND SIZING.
- D. PROVIDE 1-INCH ACOUSTIC LINING FOR ENTIRETY OF MAIN DUCT RUN OFF FAN COIL.
- E. ALL RESIDENTIAL TOILET EXHAUST, DRYER EXHAUST, AND KITCHEN RANGE HOOD EXHAUST TO BE PART OF A SUB-DUCT EXHAUST SYSTEM.
- F. ROUTE 3/4" CONDENSATE DRAINS FROM FCUS TO NEAREST SINK TAILPIECE.

**NUMBERED NOTES:**

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- 6 2" RETURN AIR SLOT

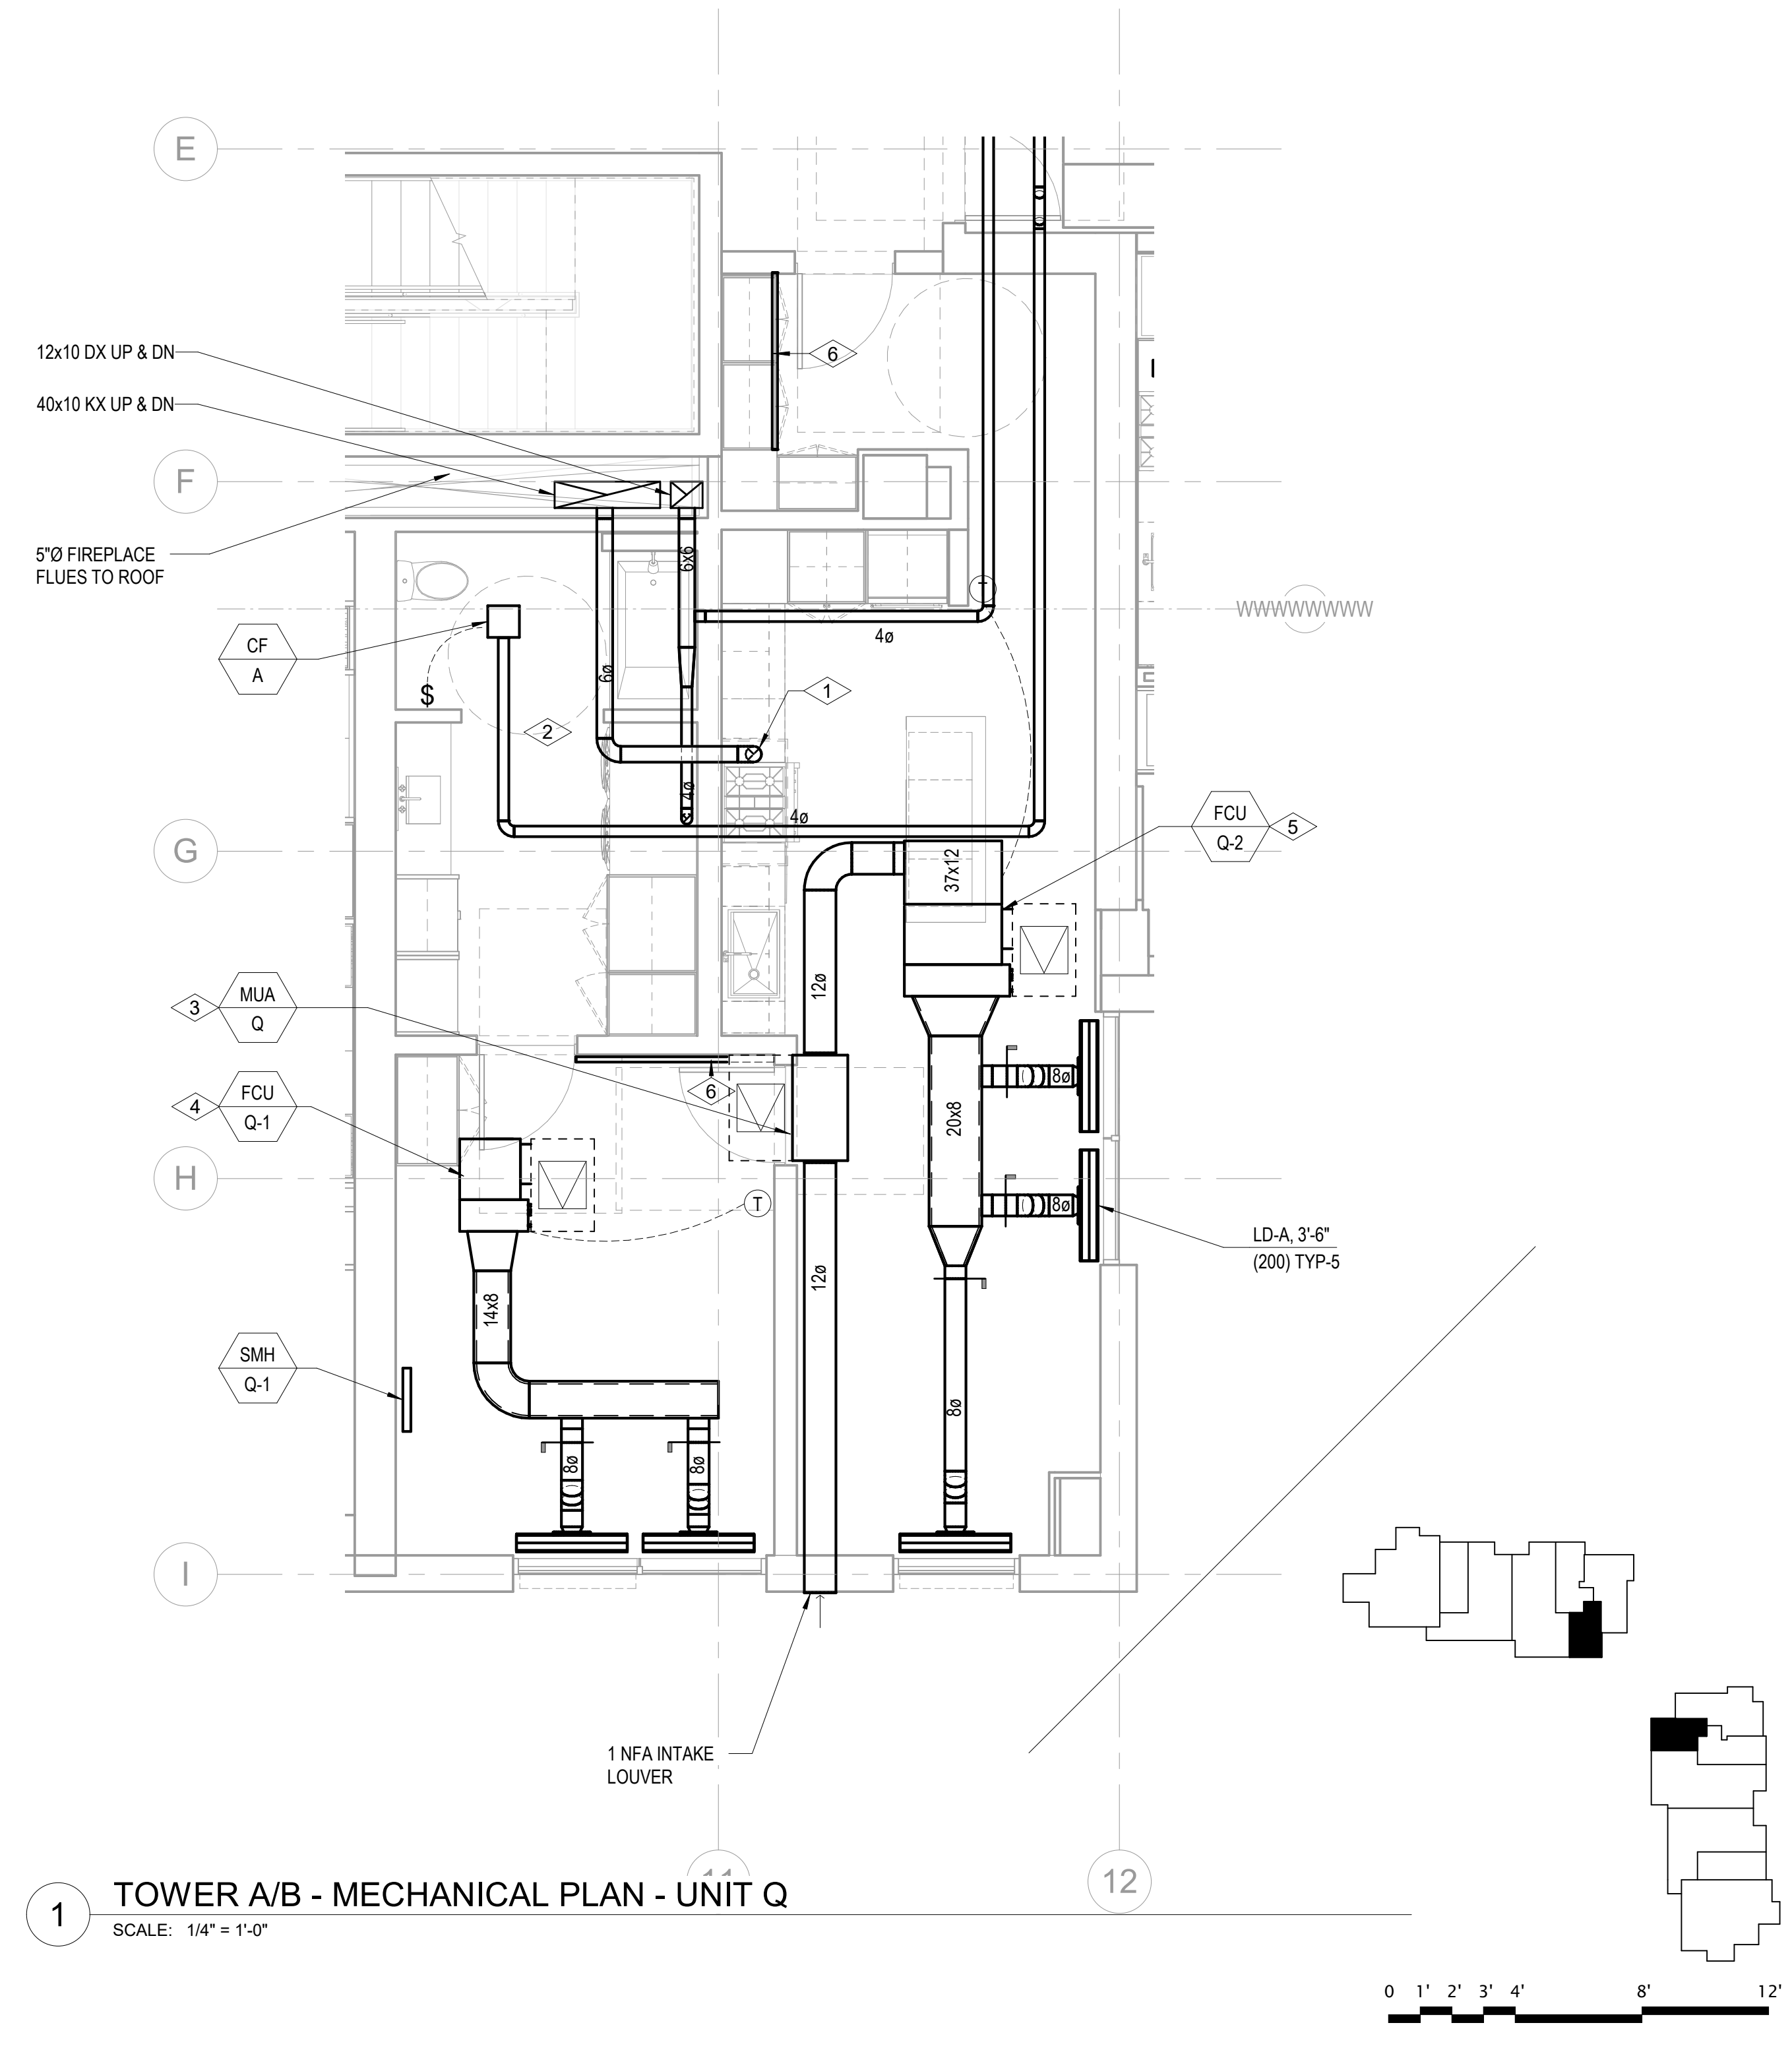

1 TOWER A/B - MECHANICAL PLAN - UNIT Q  
SCALE: 1/4" = 1'-0"

