

C 20x12 TX DN **D**

 (E)

(G)

SHEET NOTES:


- CONFIRM EXACT LOCATION OF ALL WALL DEVICES WITH ARCHITECTURAL ELEVATIONS. Α. CONFIRM ALL CEILING AND WALL ACCESS DOORS WITH ARCHITECTURAL RCP'S AND WALL ELEVATIONS. REFER TO M3-2A-01 THROUGH M3-2C-R FOR RADIANT FLOOR HWS/R PIPING ROUTING AND SIZING.
- PROVIDE 1-INCH ACOUSTIC LINING FOR ENTIRITIY OF MAIN DUCT RUN OFF FAN COIL. ALL RESIDENTIAL TOILET EXHAUST, DRYER EXHAUST, AND KITCHEN RANGE HOOD EXHAUST TO BE PART OF A SUB-DUCT EXHAUST SYSTEM.
- F. ROUTE 3/4" CONDENSATE DRAINS FROM FCUS TO NEAREST SINK TAILPIECE.

<u>NUMBERED NOTES:</u>

- RANGE HOOD EXHUAST FAN TO BE INEGRAL WITH RANGE SPECIFIED BY THE ARCHITECT. INTERLOCK CONTROL WITH MUA-A. 2 3
 63
 125
 250
 500
 1000
 2000
 4000
 8000

 0
 4
 6
 8
 7
 9
 8
 0
 CONFIRM WITH OWNER AND ARCHITECT PRIOR TO PROVIDING HUMIDIFIER. 2" RETURN AIR SLOT 4 OWNER OPTION: PROVIDE 120(16A)/1 CONNECTION FOR APRILAIRE 800 HUMIDIFIER DOWNSTREAM OF FAN COIL UNIT. REFER TO 5 ELECTRICAL DRAWINGS FOR DETAIL. REFER TO PLUMBING DRAWINGS FOR 1/2" CW CONNECTION. ROUTE 3/4" CD TO NEAREST SINK TAILPIECE. REFER TO DETAILS M5.04/8 & M5.04/12 FOR INSTALLATION CONNECTION. REMOVE SOUND LINING FROM FCU AND PROVIDE PRICE RSP 3'-0" SOUND ATTENUATOR WITH A MINIMUM INSERTION LOSS OF:
 63
 125
 250
 500
 1000
 2000
 4000
 8000

 0
 4
 6
 8
 7
 9
 8
 0
- CONFIRM WITH OWNER AND ARCHITECT PRIOR TO PROVIDING HUMIDIFIER. CONNECT 4"Ø TO DRYER. 6 LOCATION OF STEAM GENERATOR FOR DUCT HUMIDIFIER. CONFIRM EXACT LOCATION WITH ARCHITECT PRIOR TO INSTALLING. 7

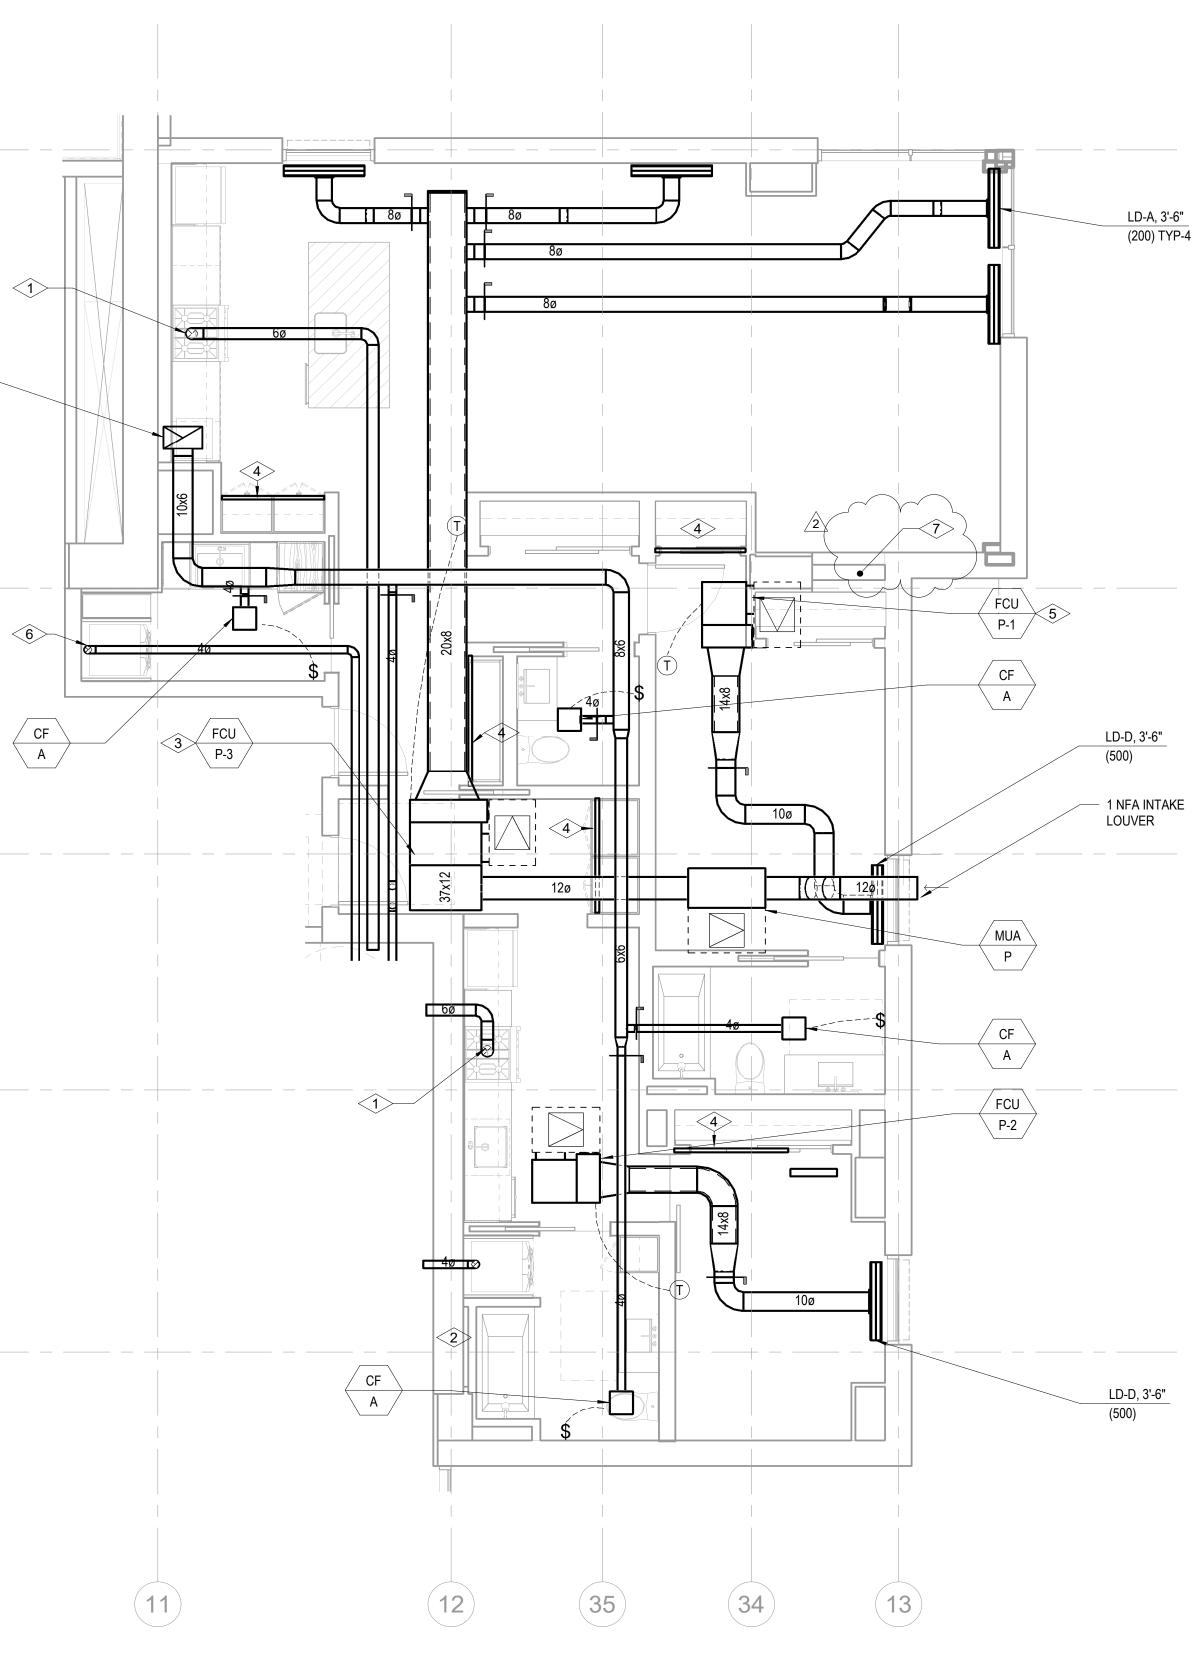

¹ TOWER A/B - MECHANICAL PLAN - UNIT P SCALE: 1/4" = 1'-0"

0 1' 2' 3' 4'	8'	12'

no.	date	by
	IFC Set 3 of 3	
	5/31/2024	
	5/51/2024	
	ARGED	
LAP	N - UNIT P	
	M2.4.P	

2 5/31/2024 IFC 3

<u>Building Envelope Consultant</u> RDH 2101 N 34th St Seattle, WA 98103
<u>Accessibility Consultant</u> Studio Pacifica 2144 Westlake Ave N, Suite F Seattle, WA 98109
<u>MEP Engineer</u> WSP USA 1001 Fourth Ave., Suite 3100 Seattle, WA 98154
principal architect
project manager
drawn by
checked by <u>Checker</u>
job no.
date 5/31/2024
revisions:

<u>Lighting Designer</u> **O-**1319 SE MLK Blvd, Suite 210 Portland, Oregon 97219

<u>Structural Engineer</u> **Magnusson Klemencic Associates** 1301 5th Ave, Suite 3200 Seattle, WA 98101

<u>Vertical Transportation Consulatant</u> **Lerch Bates** 19515 North Creek Parkway, Suite 304 Bothell, WA 98011

<u>Fire Protection Engineer</u> Jensen Hughes One Research Drive, Suite 305C Westborough, MA 01581

<u>Code Consultant</u> **Holmes** 600 1st Avenue, Suite 200A Seattle, WA 98104

<u>Specifications Writer</u> **Friday Group** 88 Mainelli Road Middlebury, VT

<u>Pool Consultant</u> **Cloward H20** 2696 N University Ave, Suite 290 Provo, UT 84604 <u>Landscape Architect</u> **EPG Design** 6949 South High Tech Drive, Suite 100 Midvale, Utah 84047

ASPEN GROUP

Aspen Group USA, LLC PO Box 980022 Park City, Utah 84098

Reserved for permit stamp

300 ISA

159 Sol Seattle 1 206 6:

Kundig

Olson

E E E ⊢ < asc **∏**

0.0 0.0 Proj

REMOVE SOUND LINING FROM FCU AND PROVIDE PRICE RSP 3'-0" SOUND ATTENUATOR WITH A MINIMUM INSERTION LOSS OF:

OWNER OPTION: PROVIDE 208(16A)/1 CONNECTION FOR APRILAIRE 800 HUMIDIFIER DOWNSTREAM OF FAN COIL UNIT. REFER TO ELECTRICAL DRAWINGS FOR DETAIL. REFER TO PLUMBING DRAWINGS FOR 1/2" CW CONNECTION. ROUTE 3/4" CD TO NEAREST SINK TAILPIECE. REFER TO DETAILS M5.04/8 & M5.04/12 FOR INSTALLATION CONNECTION.

ELECTRICAL RADIANT FLOOR TO BE PROVIDED IN MASTER BATHROOM. SEE ELECTRICAL DRAWINGS.