


SHEET NOTES:



- A. CONFIRM EXACT LOCATION OF ALL WALL DEVICES WITH ARCHITECTURAL ELEVATIONS.
B. CONFIRM ALL CEILING AND WALL ACCESS DOORS WITH ARCHITECTURAL RCP'S AND WALL ELEVATIONS.
C. REFER TO M3-2A-01 THROUGH M3-2C-R FOR RADIANT FLOOR HWHR PIPING ROUTING AND SIZING.
D. PROVIDE 1-INCH ACOUSTIC LINING FOR ENTIRETY OF MAIN DUCT RUN OFF FAN COL.
E. ROUTE 3/4" CONDENSATE DRAINS FROM FCUS TO NEAREST TAILPIECE.

NUMBERED NOTES:

1. RANGE HOOD EXHAUST FAN TO BE INTEGRAL WITH RANGE SPECIFIED BY THE ARCHITECT.
INTERLOCK CONTROL WITH MUA-A
2. 4" DUCT UP TO DRYER EXHAUST
3. 2" RETURN AIR SLOT

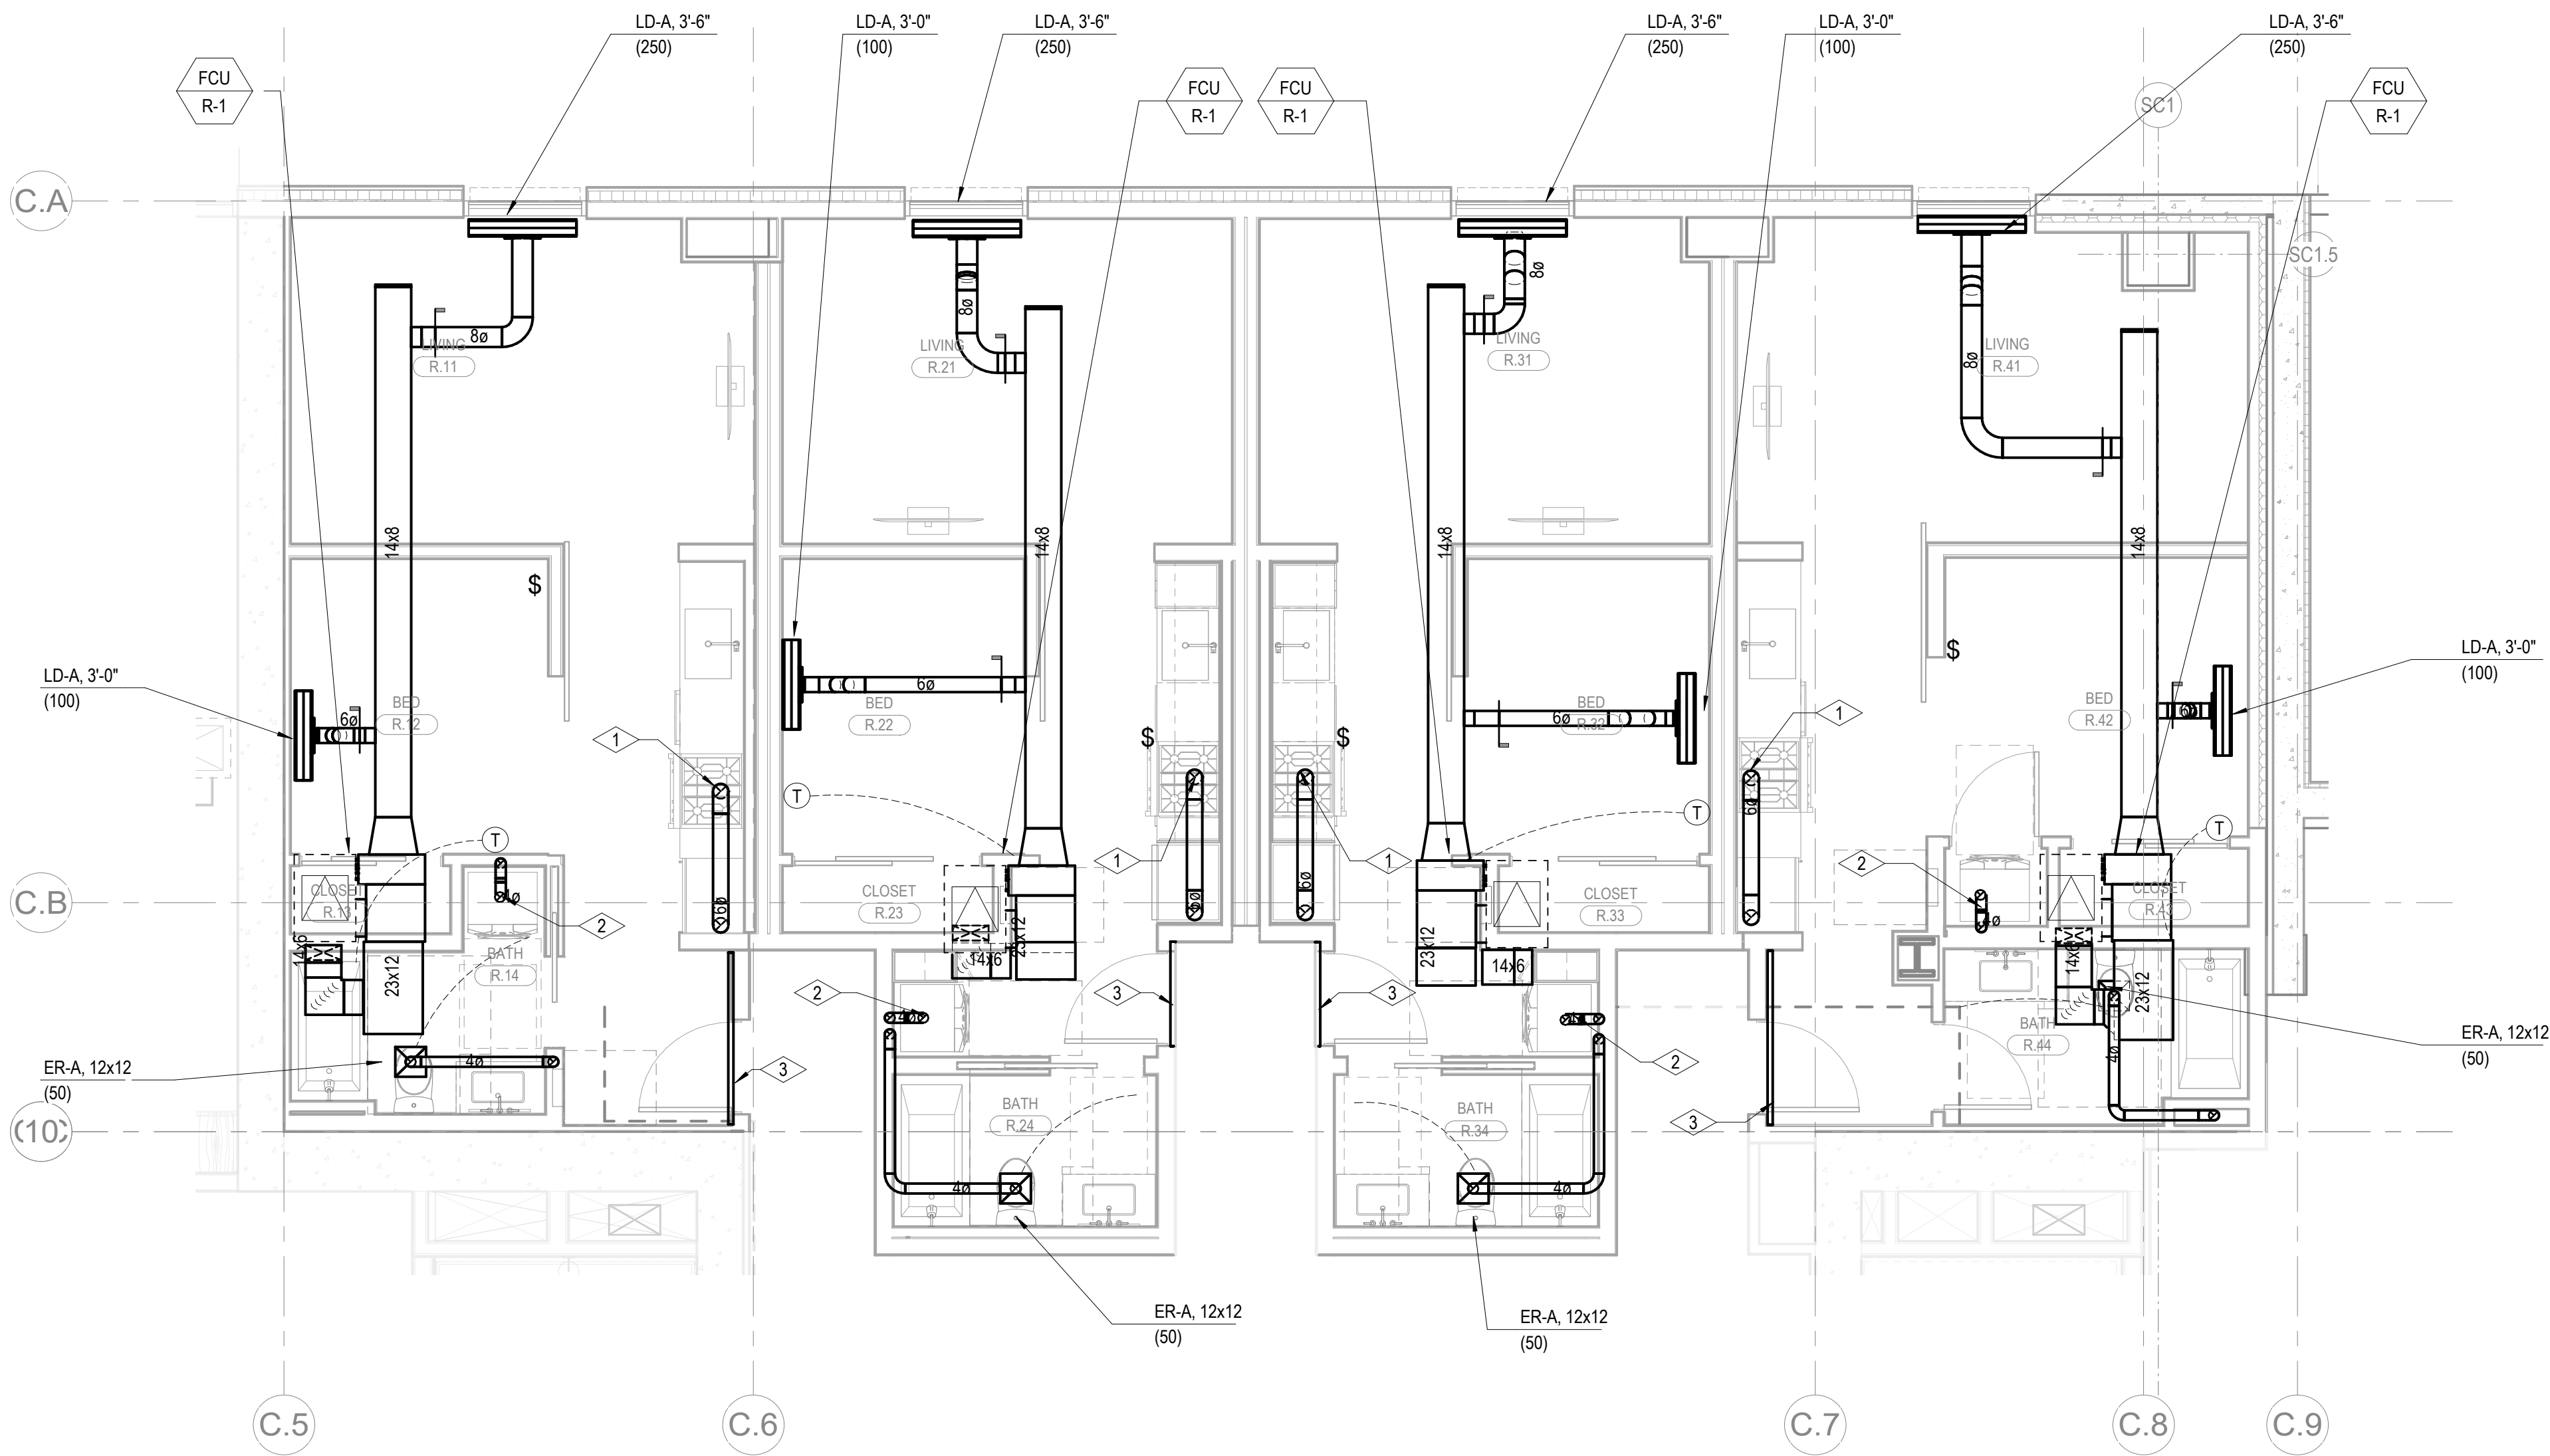

1 BLDG C - MECHANICAL UNIT PLAN - R
SCALE: 1/4" = 1'-0"

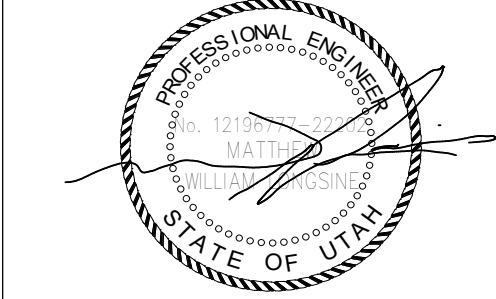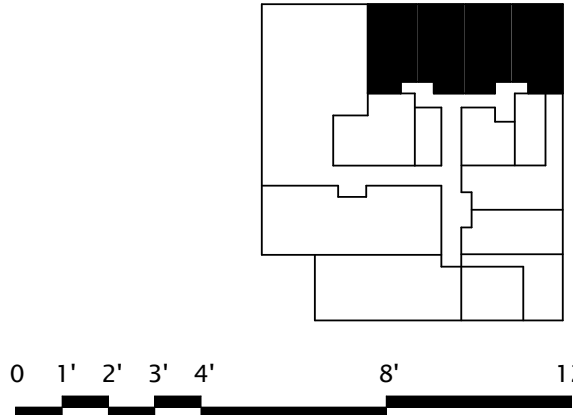

Reserved for permit stamp

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principal architect _____
project manager _____
drawn by _____
checked by _____
job no. _____
date 05/31/2024

revisions:

no. date by

IFC Set 3 of 3
05/31/2024

ENLARGED
MECHANICAL PLAN -
UNIT R

M2.4.R