

## **NUMBERED NOTES:**

- 1 PROVIDE 3/4" G, LOW PRESSURE REGULATOR, AND SHUT-OFF VALVE FOR BBQ.
- 2 PROVIDE 3/4" G, LOW PRESSURE REGULATOR, AND SHUT-OFF VALVE FOR FIRE PIT.
- 3 PROVIDE ½" G, LOW PRESSURE REGULATOR, AND SHUT-OFF VALVE FOR FIREPLACE. 4 STEAM SHOWER GENERATOR UNIT: PROVIDE ½" CW WITH SHUT-OFF VALVE AND ROUTE DRAIN TO LAV TAILPIECE.
- 5 PROVIDE HOT & COLD WALL HYDRANT FOR FILL FOR HOT TUB.
- 6 PROVIDE WATER AND DRAIN CONNECTIONS FOR SECOND DISHWASHER.
- 7 PROVIDE 3/4" G, LOW PRESSURE REGULATOR, AND SHUT-OFF VALVE FOR FIREPLACE.
- 8 OWNER OPTION: PROVIDE 1/2" CW TO DUCT HUMIDIFIERS. SEE MECHANICAL PLANS FOR LOCATIONS. CONFIRM WITH OWNER PRIOR TO PROVIDING.
- 9 ROUTE 1/2" DRAIN TUBING FROM WINE COOLER UNIT EVAPORATOR TO ADJACENT SINK TAILPIECE.

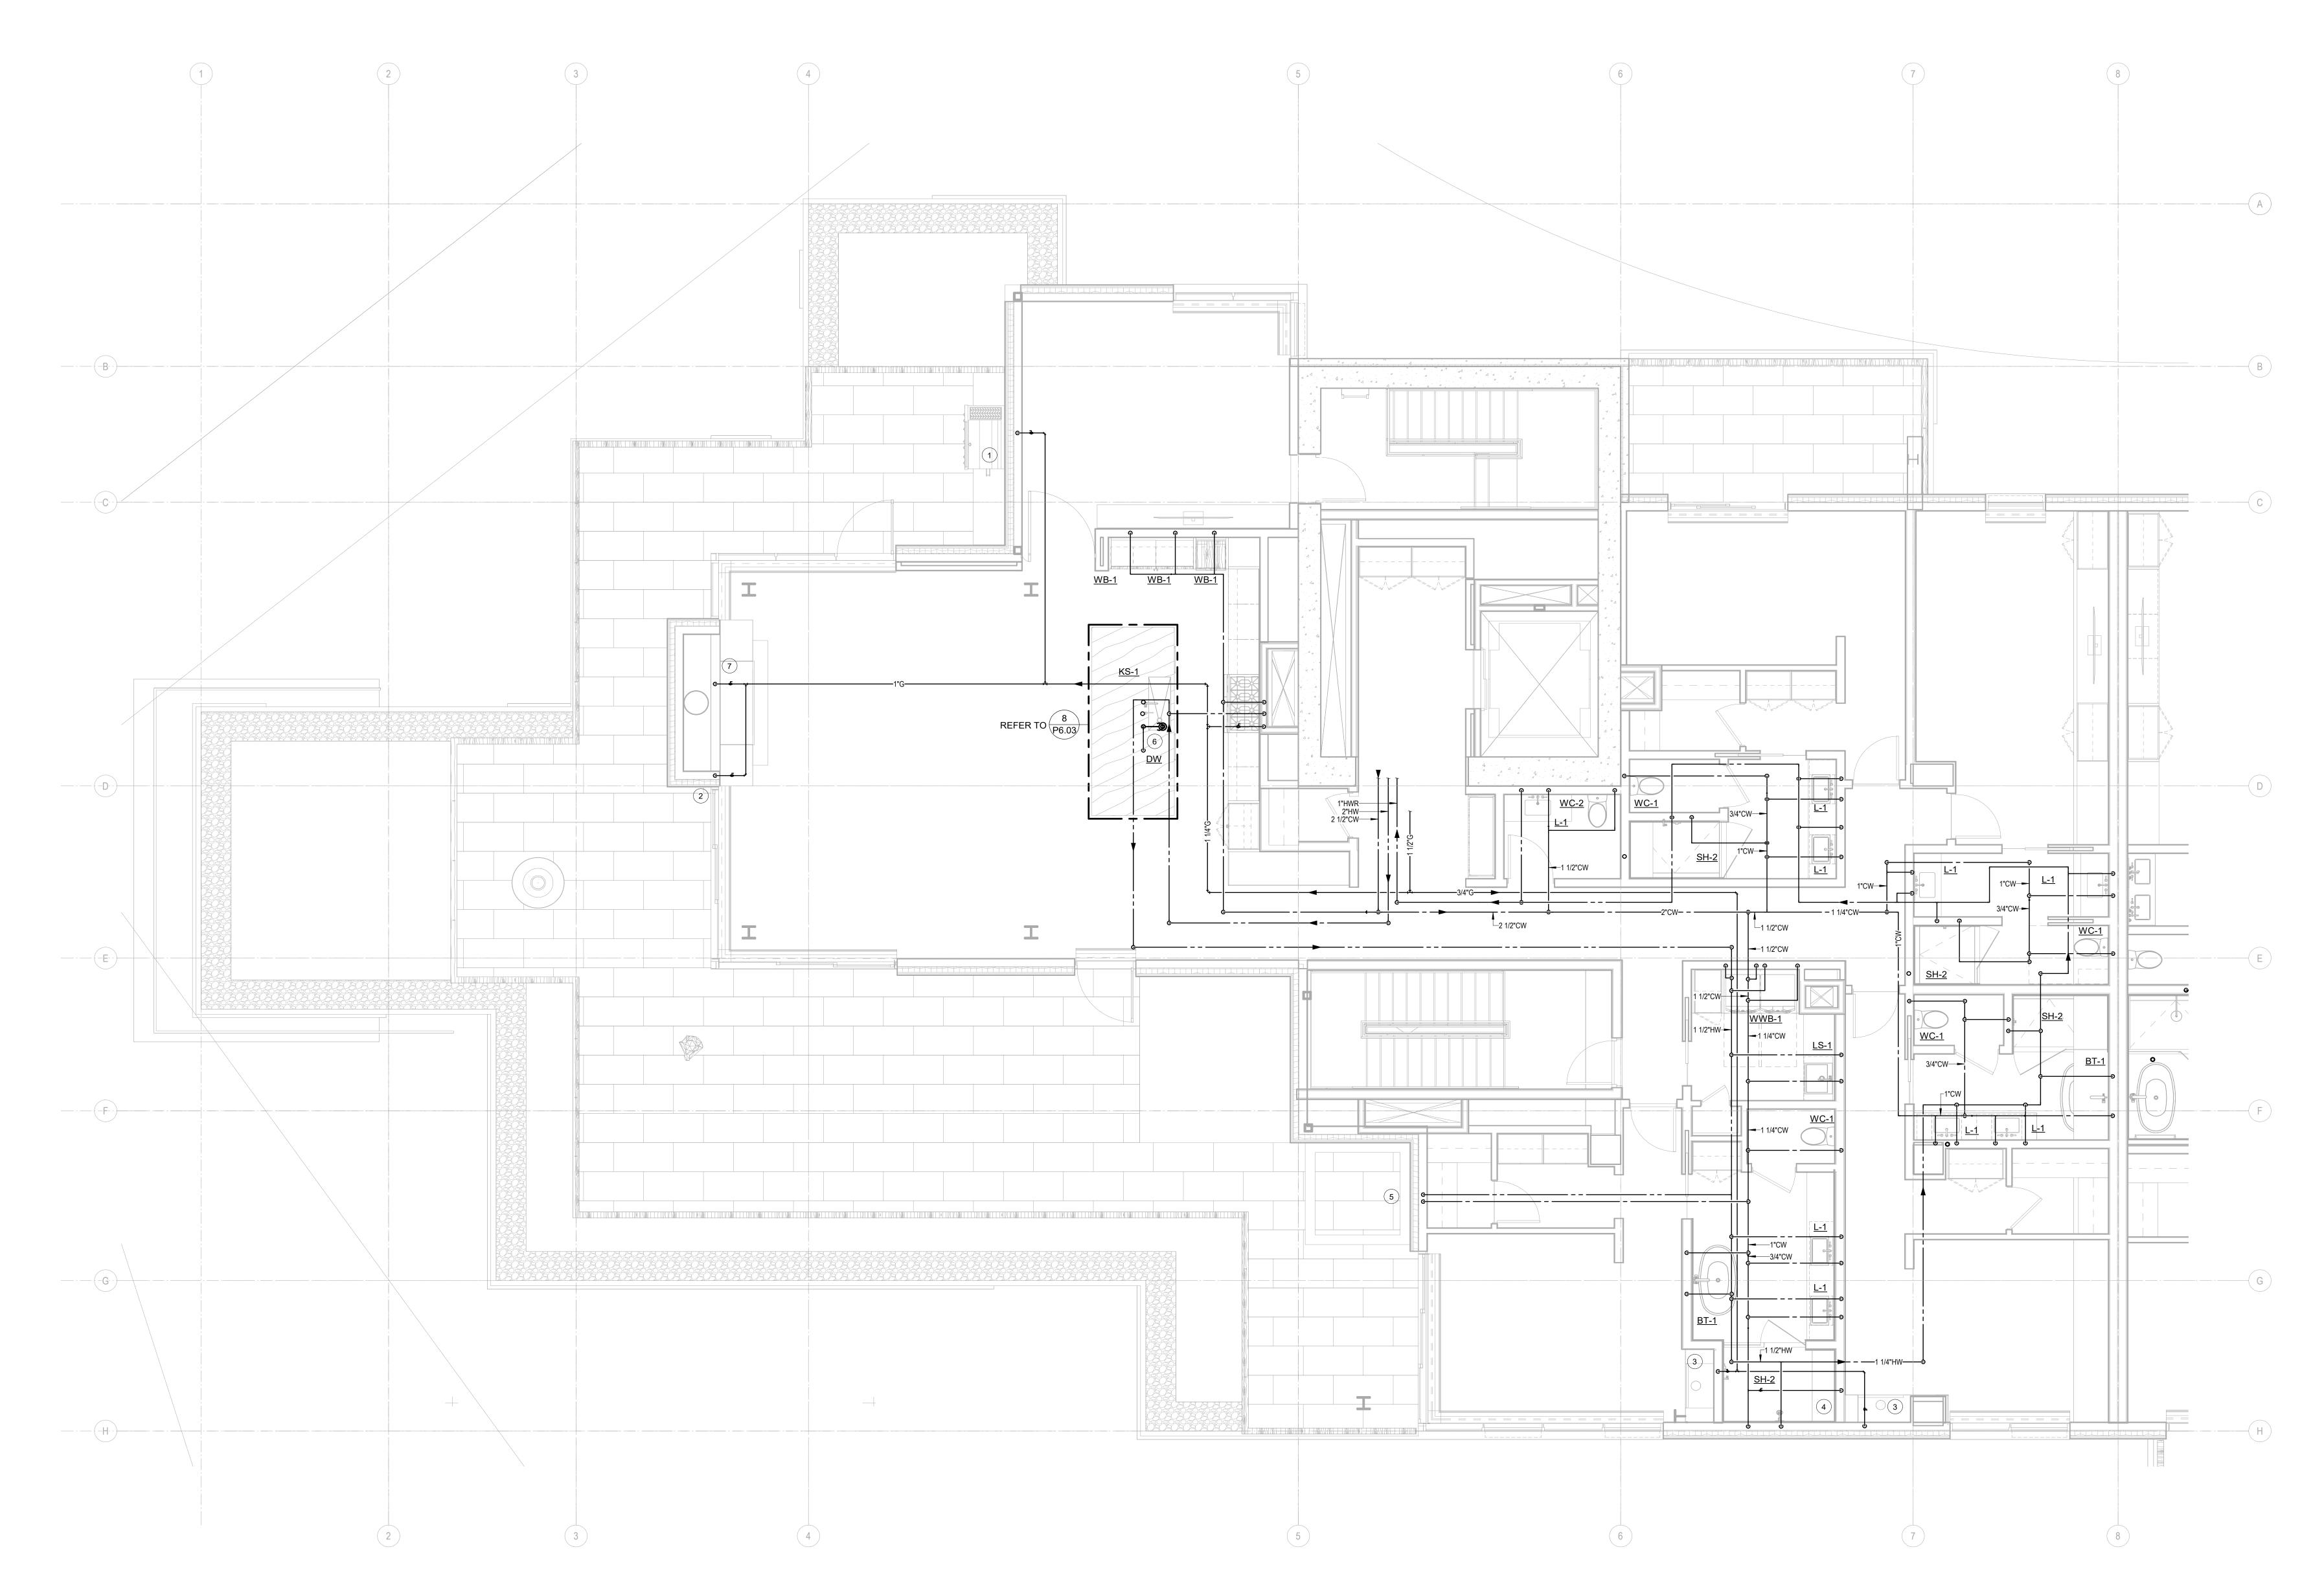

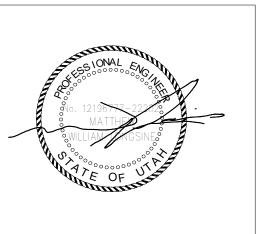

Reserved for permit stamp

**ASPEN** GROUP **Aspen Group USA, LLC**PO Box 980022
Park City, Utah 84098

Pool Consultant
Cloward H20
2696 N University Ave, Suite 290
Provo, UT 84604 <u>Landscape Architect</u> **EPG Design**6949 South High Tech Drive, Suite 100
Midvale, Utah 84047

Specifications Writer Friday Group 88 Mainelli Road Middlebury, VT Code Consultant
Holmes
600 1st Avenue, Suite 200A
Seattle, WA 98104

Fire Protection Engineer

Jensen Hughes

One Research Drive, Suite 305C

Westborough, MA 01581

Vertical Transportation Consulatant Lerch Bates 19515 North Creek Parkway, Suite 304 Bothell, WA 98011

Structural Engineer

Magnusson Klemencic Associates
1301 5th Ave, Suite 3200
Seattle, WA 98101 <u>Lighting Designer</u> **O-**

1319 SE MLK Blvd, Suite 210 Portland, Oregon 97219 Building Envelope Consultant RDH 2101 N 34th St Seattle, WA 98103

Accessibility Consultant
Studio Pacifica
2144 Westlake Ave N, Suite F
Seattle, WA 98109 MEP Engineer
WSP USA
1001 Fourth Ave., Suite 3100
Seattle, WA 98154

principal architect \_\_\_\_\_ project manager\_\_\_\_ drawn by\_\_\_\_\_

checked by <u>GM</u> job no. 2021-0595

1 10/05/2022 PERMIT RESUBMITTAL no. date

> IFC Set 2 of 3 5/17/2024

UNIT PLAN - TOWER A/B-UNIT H P2.4.H

1 ENLARGED PLAN - A/B-UNIT H
SCALE: 1/4" = 1'-0"