CONCRETE PLAN GENERAL NOTES

1. WHERE WALLS ALIGN TO GRID, LOCATE FACE OF STUD OR FACE OF CONCRETE AT GRID, U.N.O. 2. FINISH FLOOR ELEVATION TYPICAL ACROSS LEVEL, U.N.O. 3. REFER TO A0.10 AND A0.11 FOR ASSEMBLIES. 4. ALL DIMENSIONS ARE TO FACE OF CONCRETE AND CENTERLINE OF CONCRETE COLUMN, U.N.O. 5. T.O. CURBS 4" A.F.F. ,MAXIMUM 6" A.F.F. , WHERE SLAB IS SLOPED, U.N.O. 6. MIN. 1% SLOPE TO DRAINS 7. TOP OF CONCRETE SLAB ELEVATIONS PROVIDED FOR REFERENCE. CONTRACTOR SHALL COORDINATE WITH FINISH FLOOR ELEVATIONS PROVIDED ON ARCHITECTURAL PLANS AND ADJUST CONCRETE AS NECESSARY 8. CEILING HEIGHTS MEASURED FROM TOP OF CONCRETE - SEE SECTIONS. 9. COORDINATE WITH ALL ENLARGED PLANS FOR ADDITIONAL INFORMATION AND DETAILS. 10. COORDINATE WITH STRUCTURAL FRAMING PLANS AND SHEAR WALL PLANS FOR SIZE, DETAILS, AND REINFORCING FOR COLUMNS, BEAMS, SHEAR WALLS, ETC. 11. COORDINATE WITH ELECTRICAL DRAWINGS FOR ALL LIGHTING, POWER, AND DATA REQUIREMENTS.

12. COORDINATE WITH MECHANICAL DRAWINGS FOR ALL PLUMBING AND MECHANICAL PENETRATIONS.

CONCRETE PLAN LEGEND

SLAB PENETRATION




SLAB SLOPE SYMBOL



AREA OF RECESSED SLAB - STRUCTURAL / ARCHITECTURAL

AREA OF OVERBUILT SLAB - ARCHITECTURAL

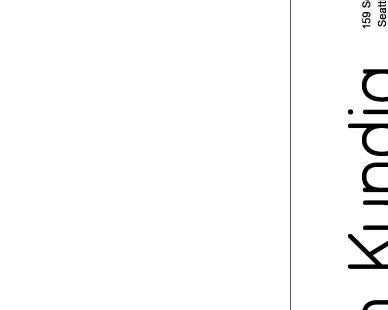

THOMAS WALTER

ASPEN GROUP

Aspen Group USA, LLCPO Box 980022
Park City, Utah 84098

Pool Consultant
Cloward H20
2696 N University Ave, Suite 290
Provo, UT 84604

Landscape Architect
EPG Design
6949 South High Tech Drive, Suite 100
Midvale, Utah 84047

Specifications Writer Friday Group 88 Mainelli Road Middlebury, VT

Code Consultant Holmes

600 1st Avenue, Suite 200A Seattle, WA 98104

Fire Protection Engineer
Jensen Hughes
One Research Drive, Suite 305C
Westborough, MA 01581

Vertical Transportation Consulatant Lerch Bates 19515 North Creek Parkway, Suite 304 Bothell, WA 98011

Structural Engineer

Magnusson Klemencic Associates
1301 5th Ave, Suite 3200

1319 SE MLK Blvd, Suite 210 Portland, Oregon 97219

Building Envelope Consultant RDH

Seattle, WA 98101

<u>Lighting Designer</u>

2101 N 34th St Seattle, WA 98103

Seattle, WA 98109

Accessibility Consultant
Studio Pacifica 2144 Westlake Ave N, Suite F


MEP Engineer
WSP USA
1001 Fourth Ave., Suite 3100
Seattle, WA 98154

principal architect TK, KM

project manager__TM, JB, SL, MD


drawn by SK, SS, JR, CP, EA, JF, BD

checked by JB job no. 20052

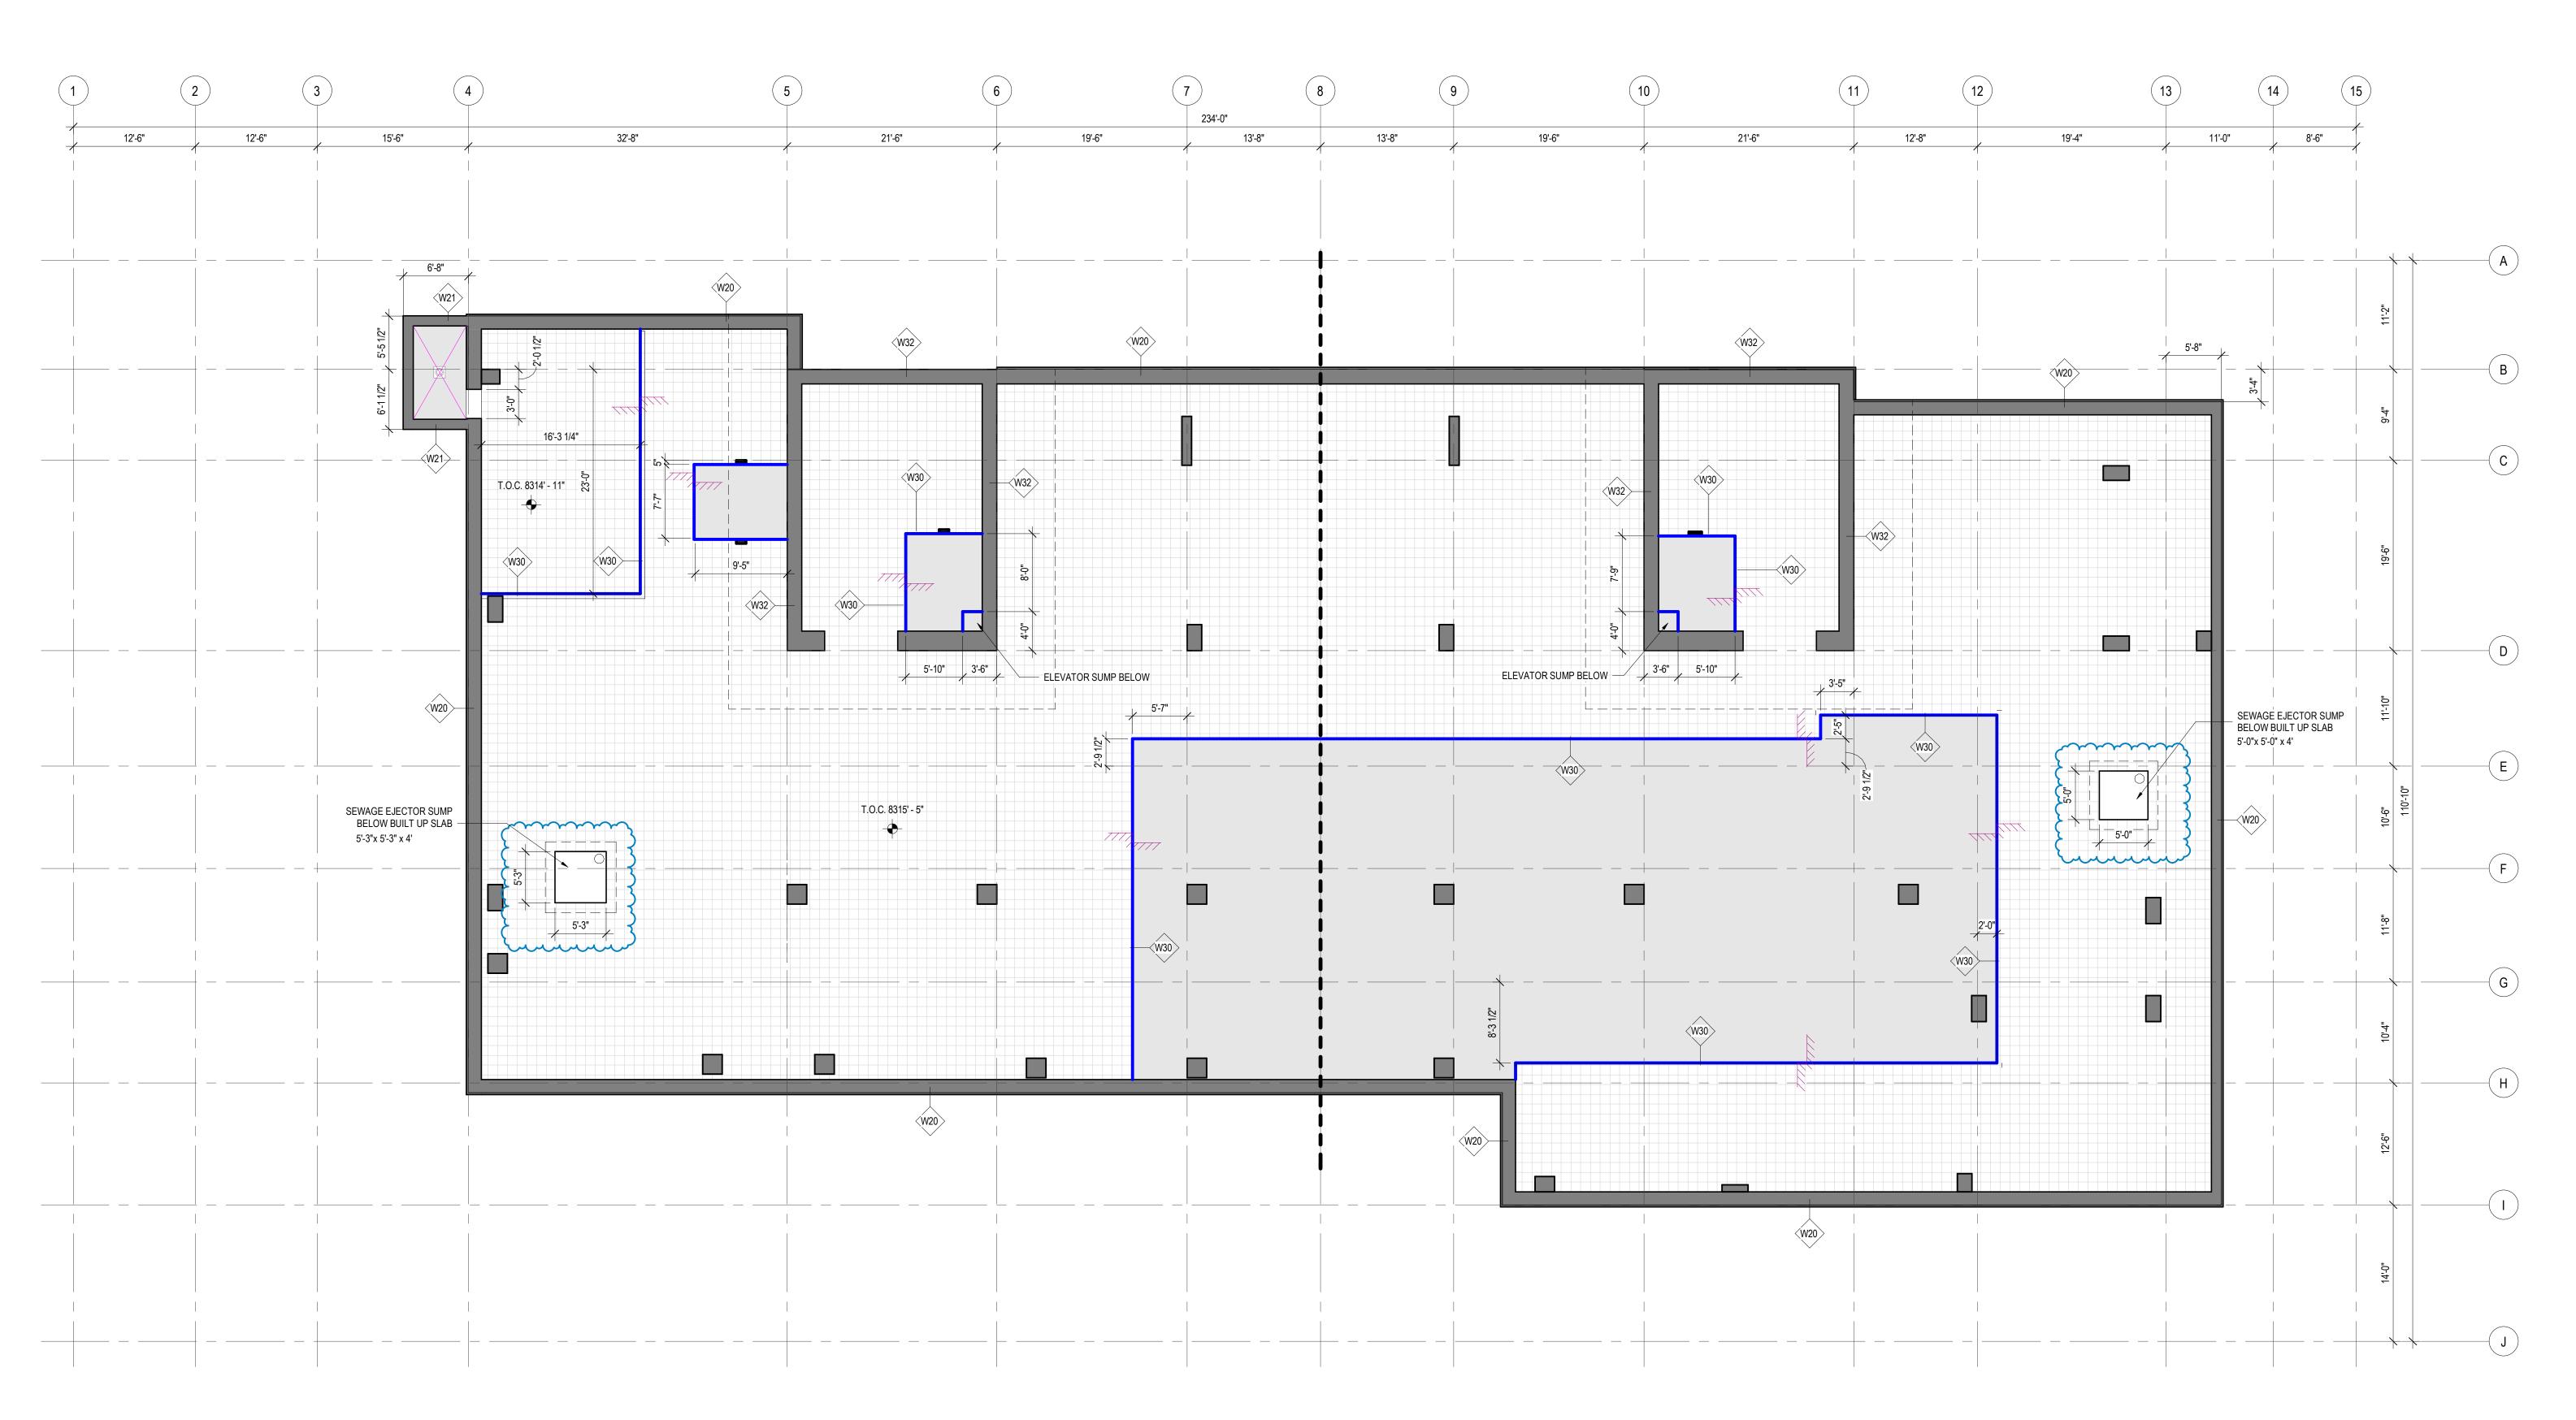

CONCRETE PLAN - TOWER A - LEVEL B

SCALE: 1/8" = 1'-0"

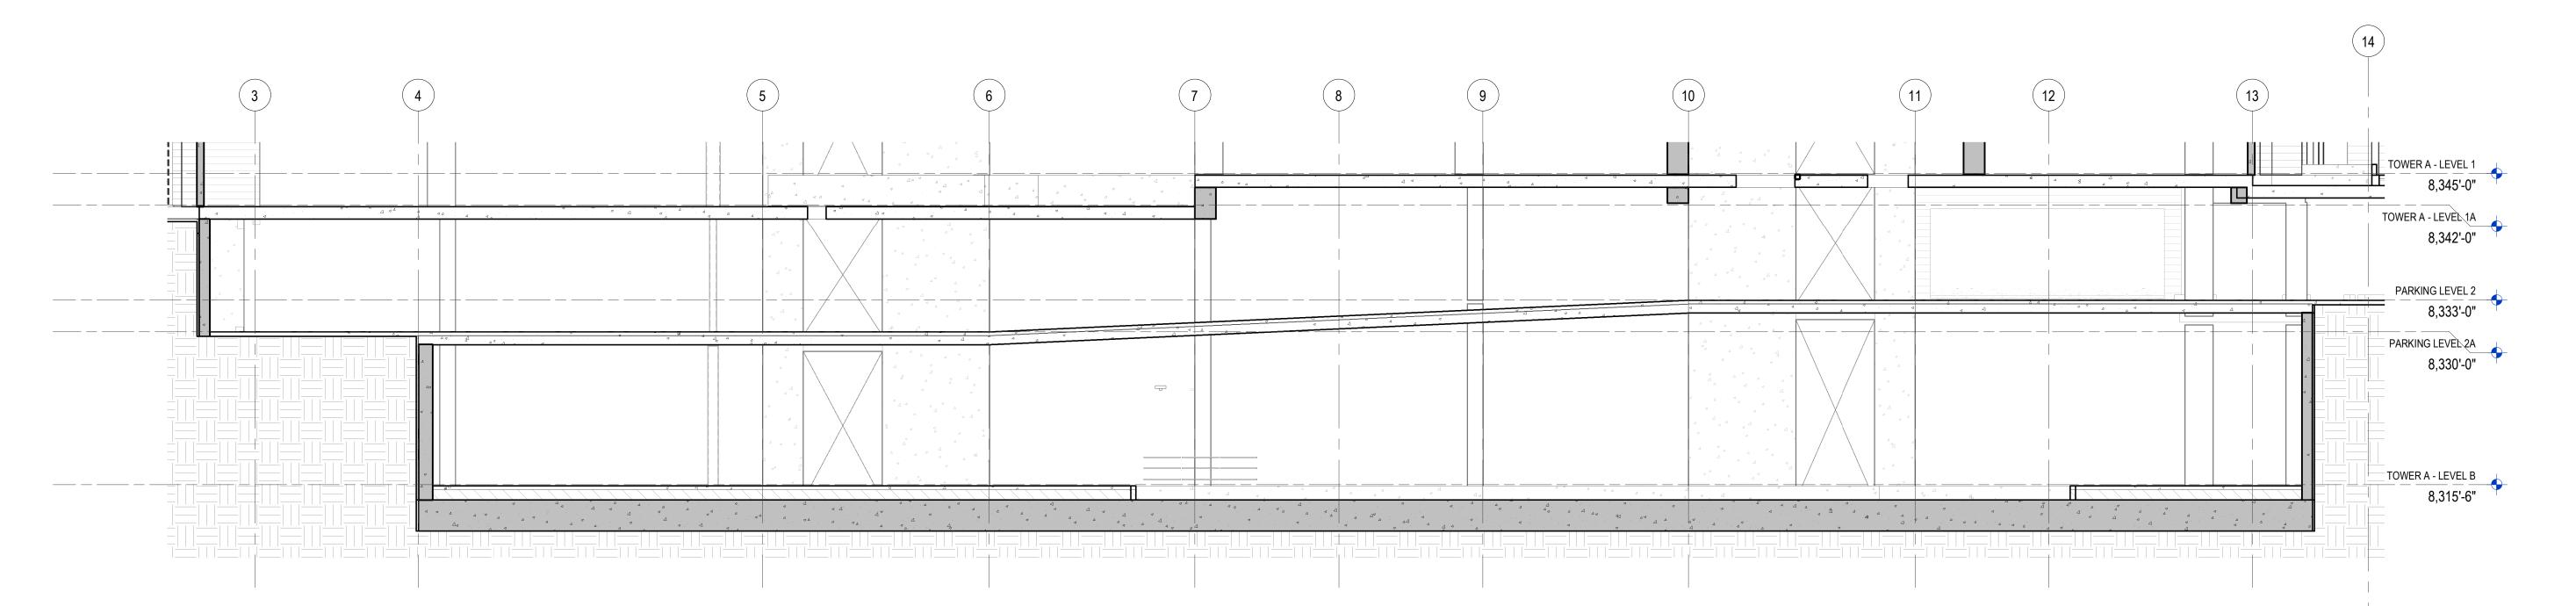

CONCRETE PLAN -TOWER A - LVL B A2.1A.01

C 07/26/24 ASI 002

IFC SET 3 OF 3

05/31/2024

2 CONCRETE SECTION - TOWER A - LEVEL B LID

SCALE: 1/8" = 1'-0"