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principal architect _____
project manager _____
drawn by _____
checked by _____
job no. _____
date 05/31/2024

revisions:

J 1/10/2024 ASI 6

no. date by

IFC Set 3 of 3
05/31/2024

TOWER C - LVL 3
MECHANICAL PIPING
PLAN


M3.2C.13

SHEET NOTES:

- A. ALL BRANCH PIPING SIZE OF CHILLED WATER AND HOT WATER TO FAN COIL UNIT IS 1" UNLESS OTHERWISE NOTED.
- B. ALL BRANCH PIPING SIZE OF HOT WATER TO FAN POWERED TERMINAL UNIT IS 1" UNLESS OTHERWISE NOTED.
- C. ROUTE 3/4" CONDENSATE FROM FPTs AND FCUS TO NEAREST SINK TAILPIECE PER DETAIL M5.06/8.

NUMBERED NOTES:

- 1 FUTURE SNOWMELT HEADER LOCATION, RADIANT HYDRONIC SNOWMELT SYSTEM TO BE DESIGN-BUILD BY OTHERS
- 2 FUTURE SNOWMELT AREA, RADIANT HYDRONIC SNOWMELT SYSTEM TO BE DESIGN-BUILD BY OTHERS

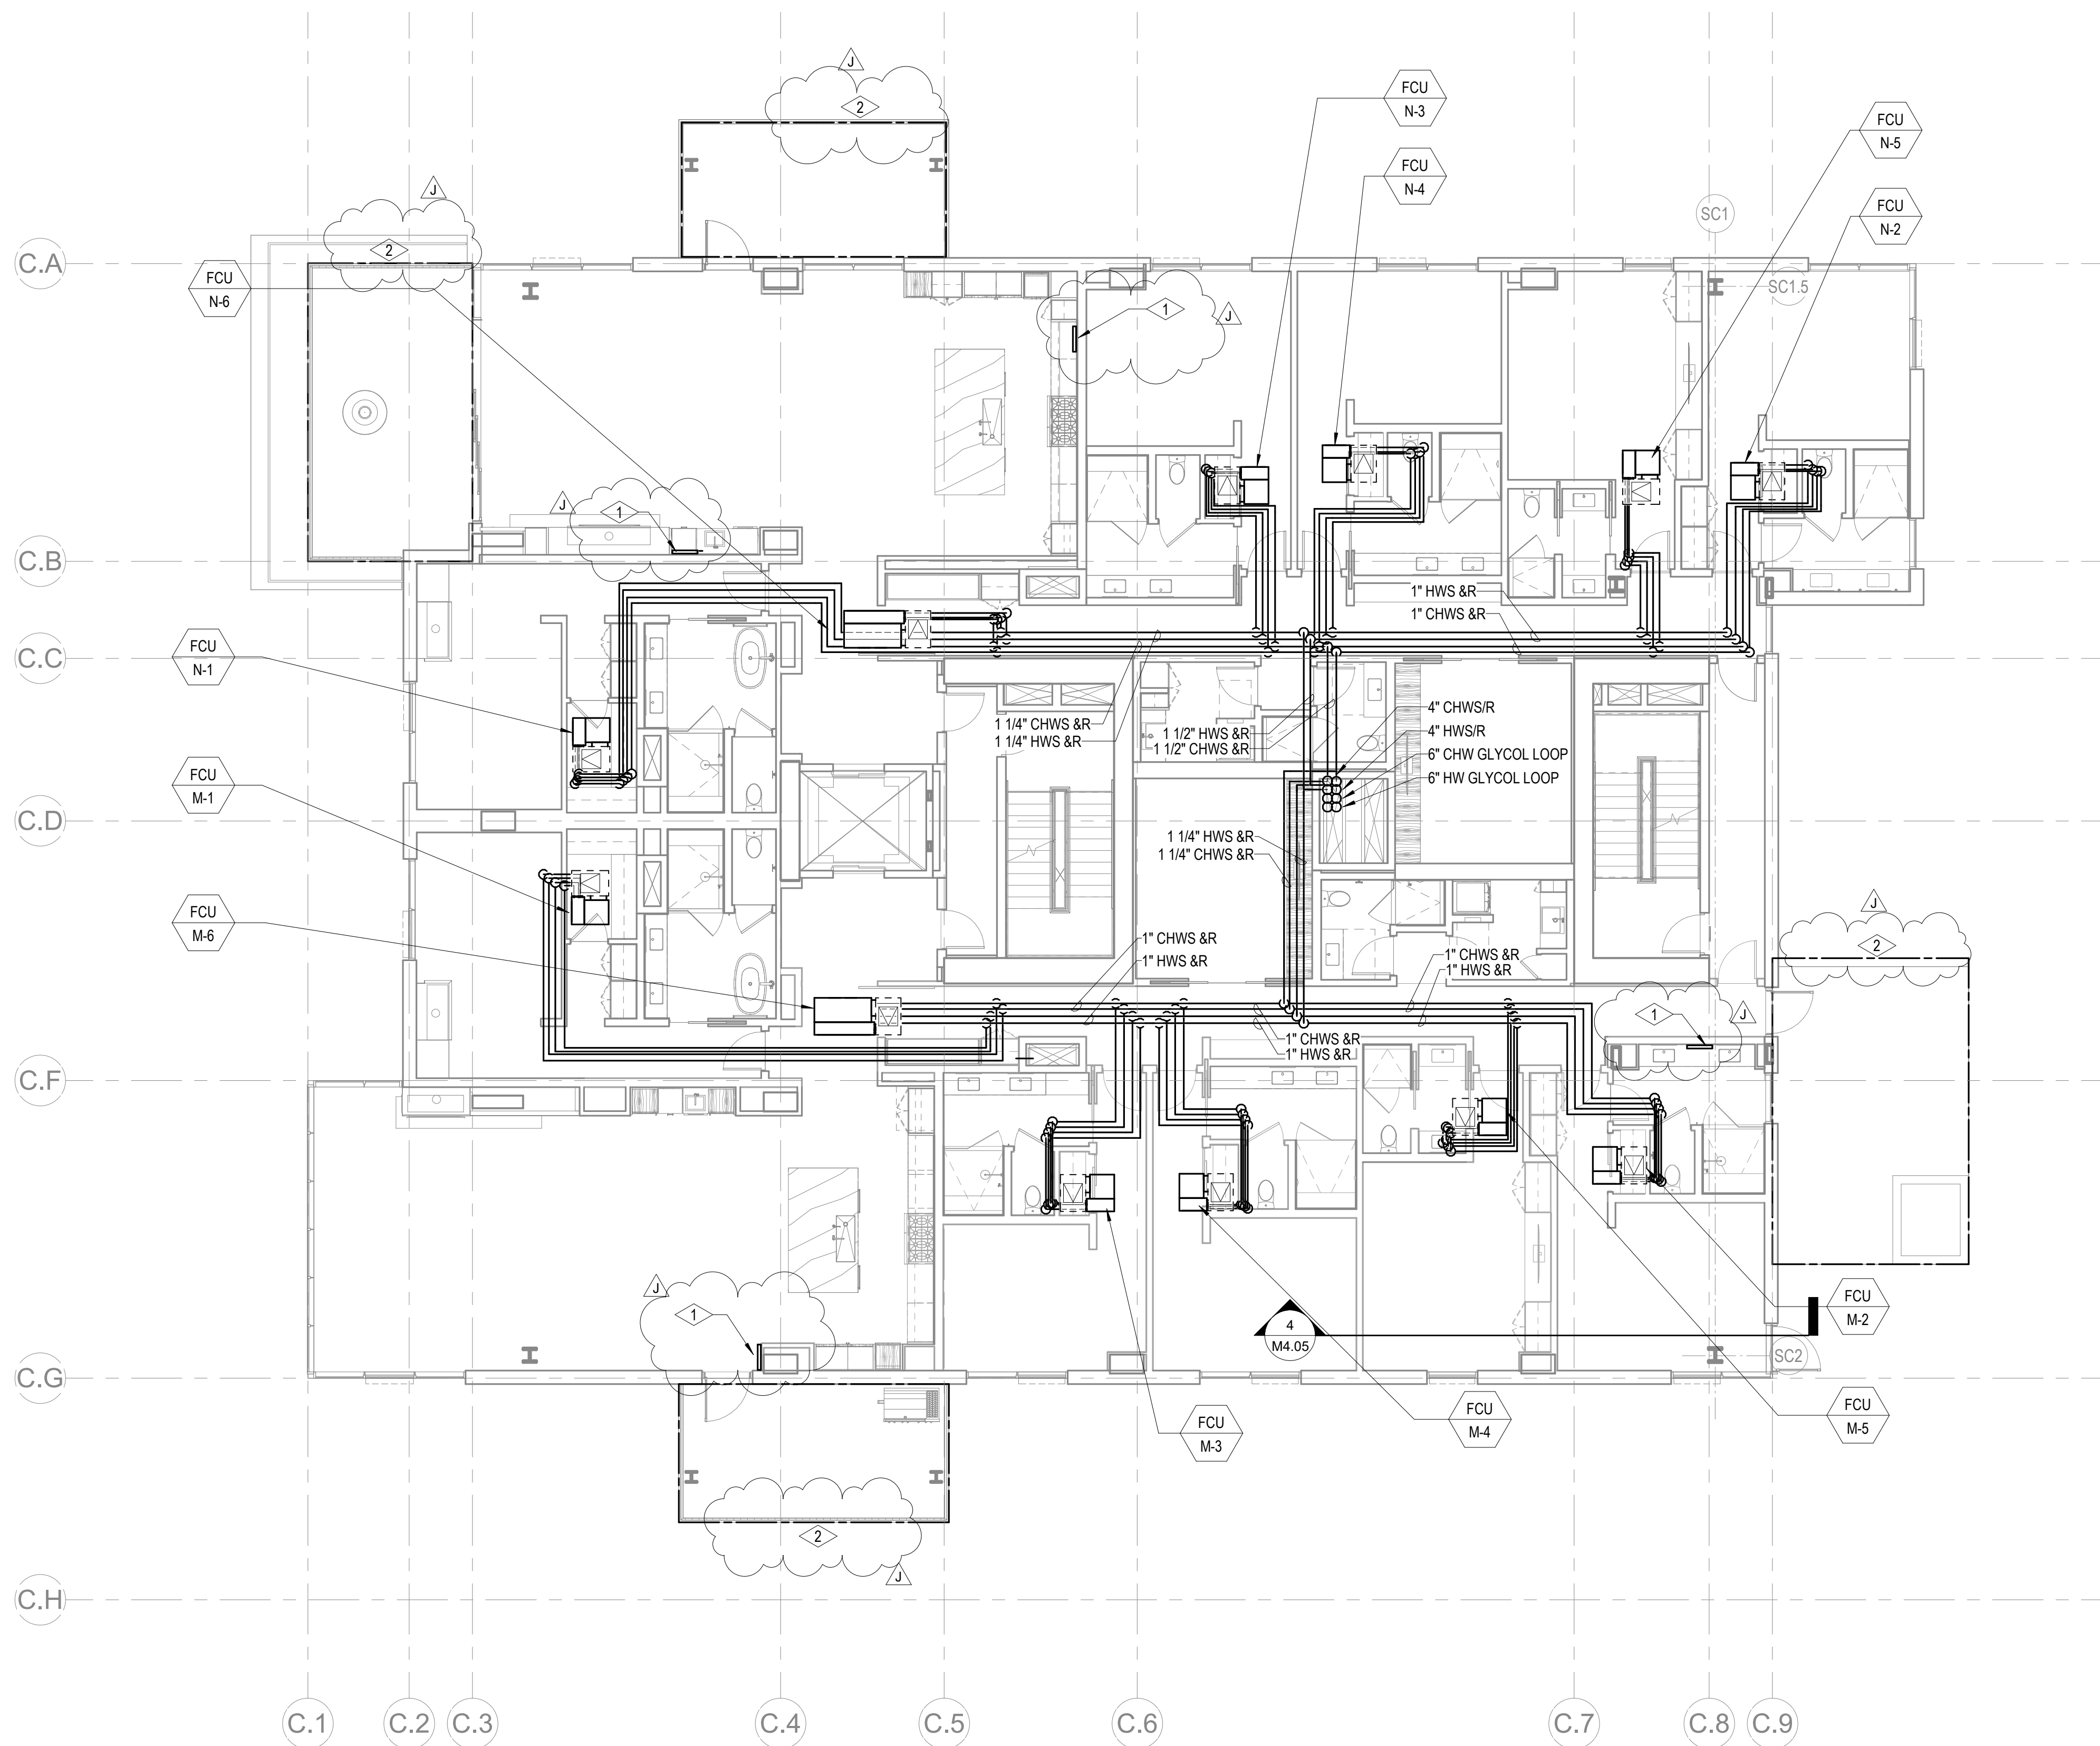

1 TOWER C - LEVEL 3 MECHANICAL PIPING PLAN
SCALE: 1/8" = 1'-0"

