## **CONCRETE PLAN GENERAL NOTES**

WHERE WALLS ALIGN TO GRID, LOCATE FACE OF STUD OR FACE OF CONCRETE AT GRID, U.N.O.
 FINISH FLOOR ELEVATION TYPICAL ACROSS LEVEL, U.N.O.
 REFER TO A0.10 AND A0.11 FOR ASSEMBLIES.
 ALL DIMENSIONS ARE TO FACE OF CONCRETE AND CENTERLINE OF CONCRETE COLUMN, U.N.O.
 T.O. CURBS 4" A.F.F., MAXIMUM 6" A.F.F., WHERE SLAB IS SLOPED, U.N.O.
 MIN. 1% SLOPE TO DRAINS
 TOP OF CONCRETE SLAB ELEVATIONS PROVIDED FOR REFERENCE. CONTRACTOR SHALL COORDINATE WITH FINISH FLOOR ELEVATIONS PROVIDED ON ARCHITECTURAL PLANS AND ADJUST CONCRETE AS NECESSARY
 CEILING HEIGHTS MEASURED FROM TOP OF CONCRETE - SEE SECTIONS.
 COORDINATE WITH ALL ENLARGED PLANS FOR ADDITIONAL INFORMATION AND DETAILS.
 COORDINATE WITH STRUCTURAL FRAMING PLANS AND SHEAR WALL PLANS FOR SIZE, DETAILS, AND REINFORCING FOR COLUMNS, BEAMS, SHEAR WALLS, ETC.

11. COORDINATE WITH ELECTRICAL DRAWINGS FOR ALL LIGHTING, POWER, AND DATA REQUIREMENTS.

12. COORDINATE WITH MECHANICAL DRAWINGS FOR ALL PLUMBING AND MECHANICAL PENETRATIONS.

## TES CONCRETE PLAN LEGEND


SLAB PENETRATION












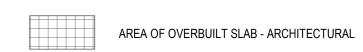


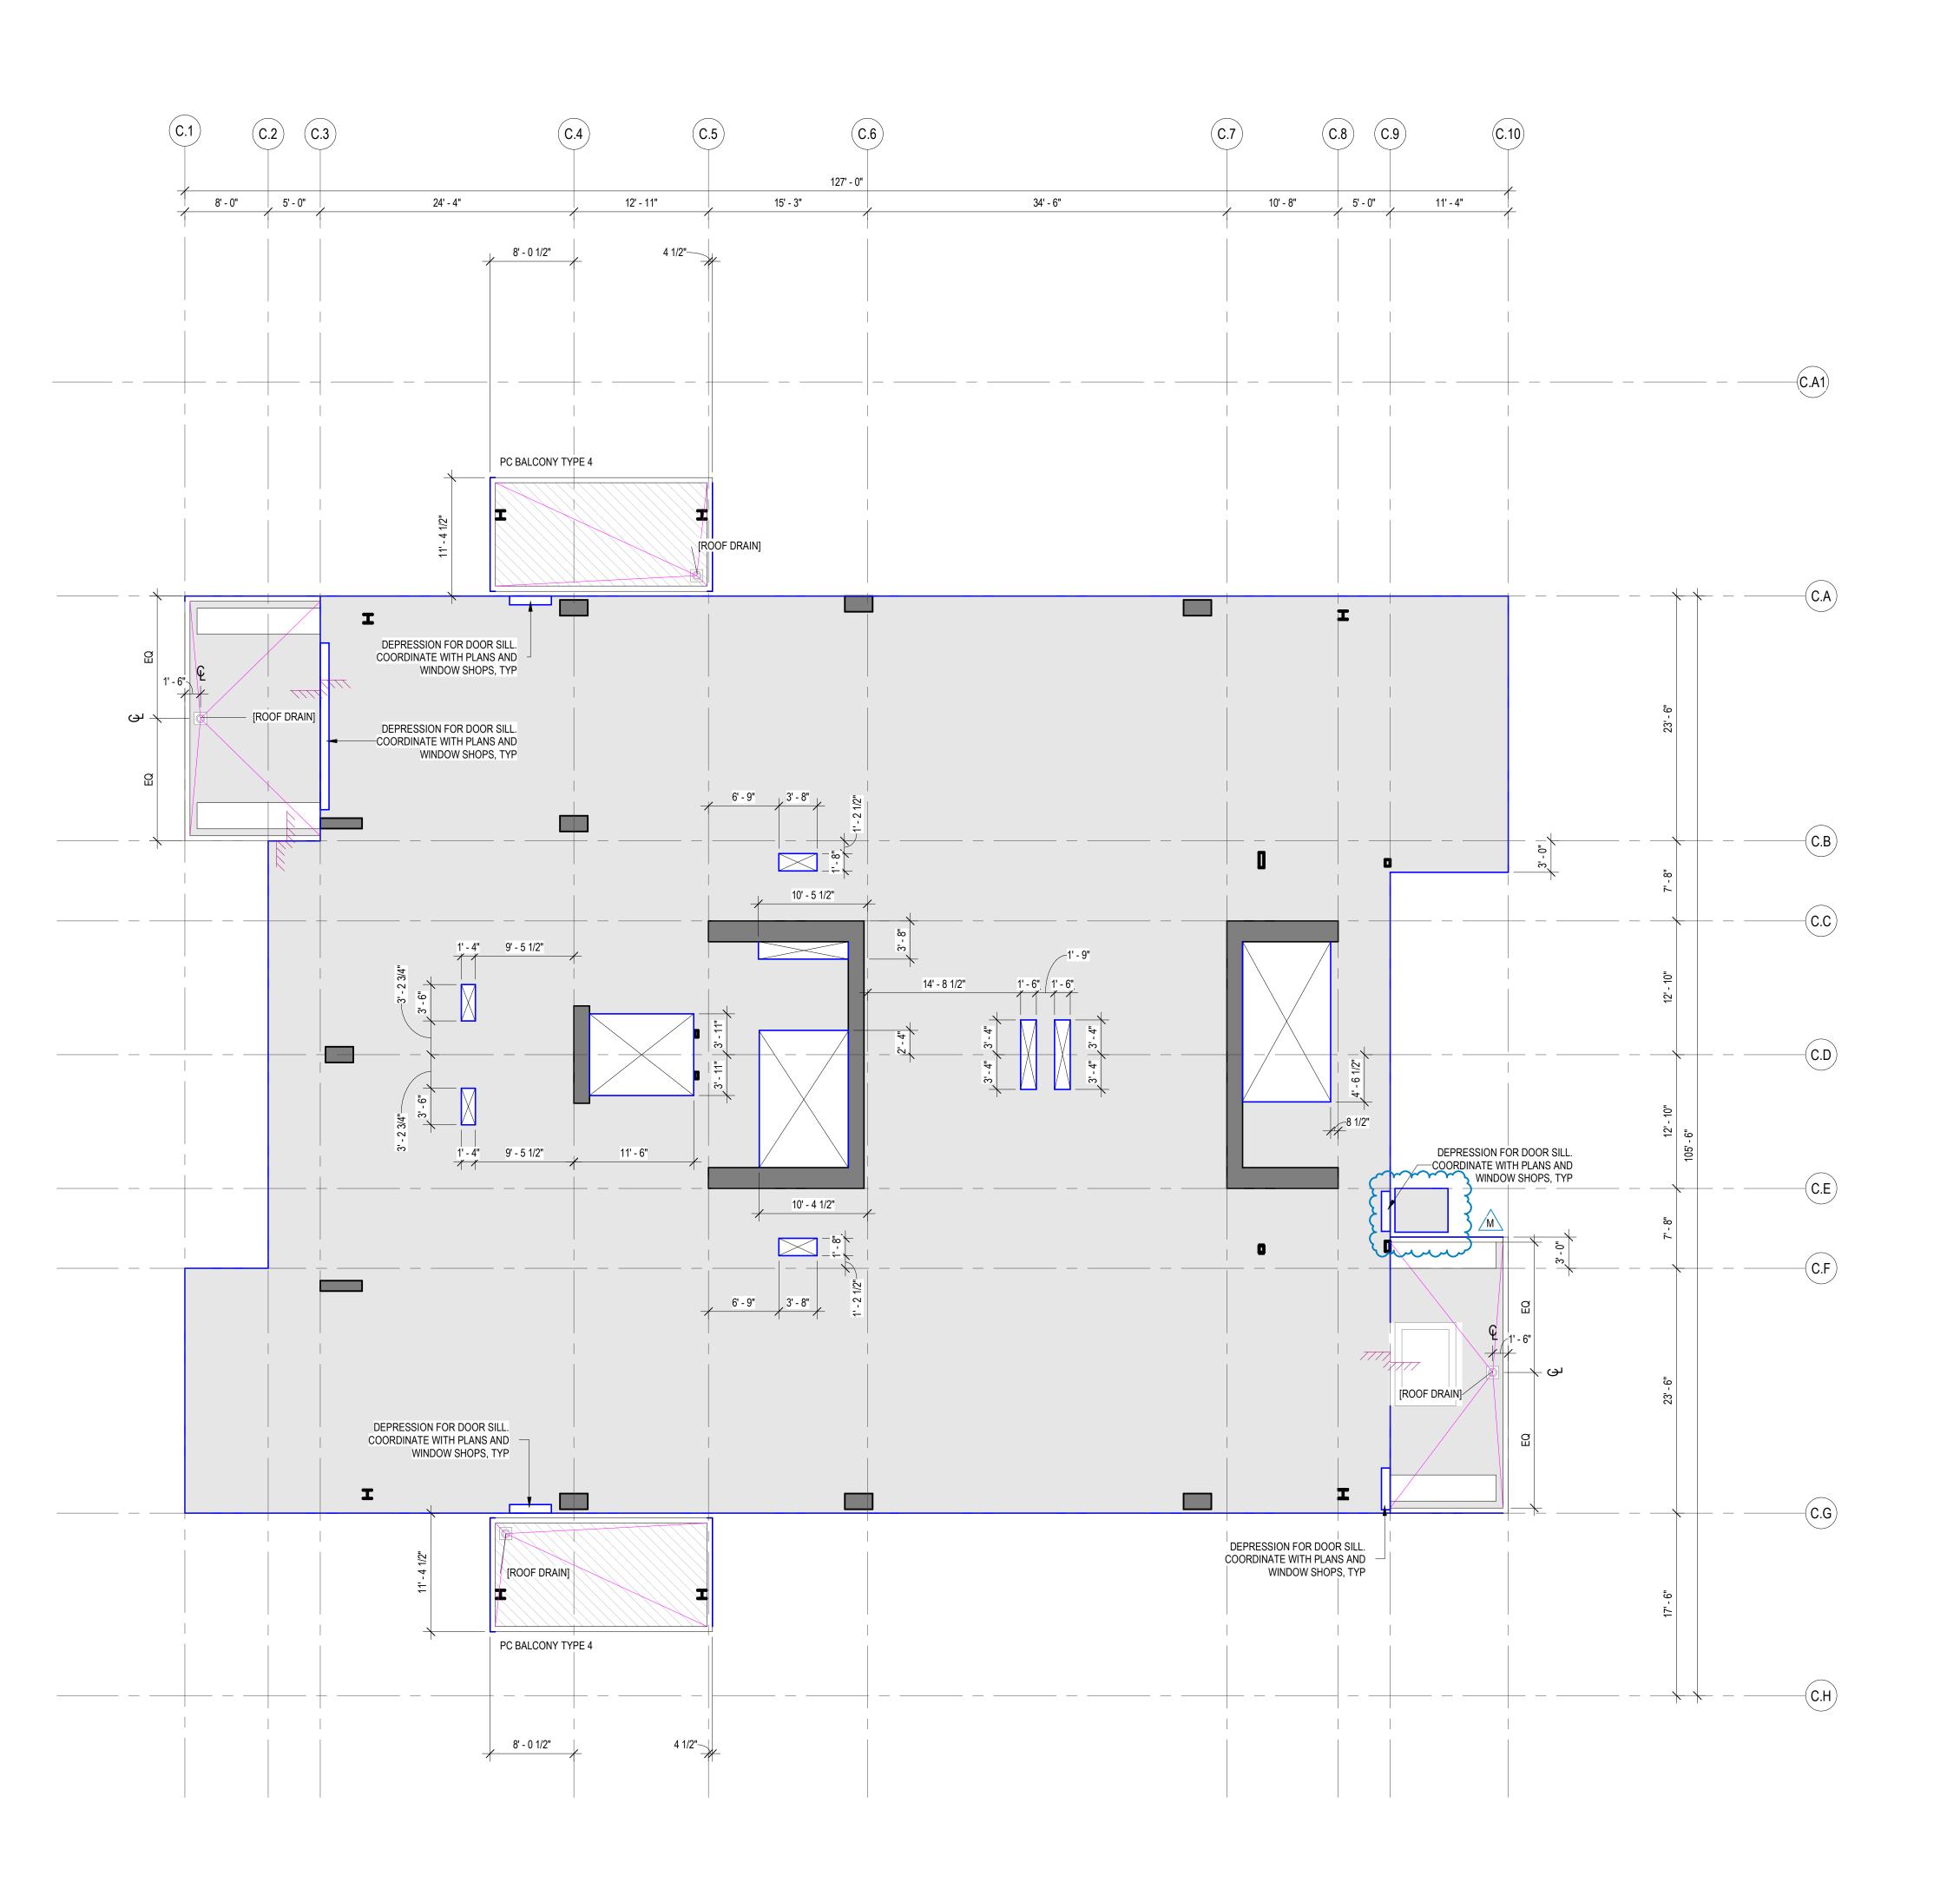



1 CONCRETE PLAN - TOWER C - LVL 7
SCALE: 1/8" = 1'-0"

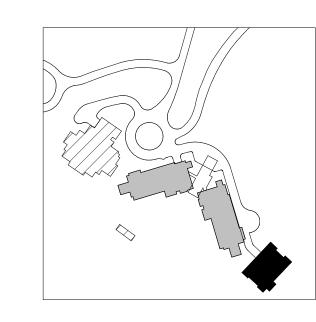

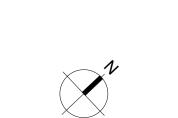

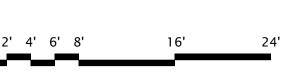

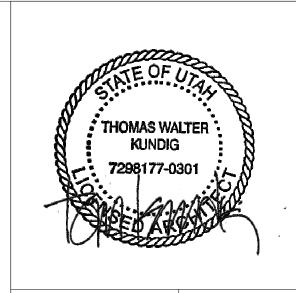

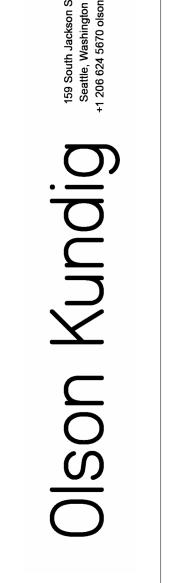







Seattle, WA 98104

19515 North Creek Parkway, Suite 30 Bothell, WA 98011
Structural Engineer Magnusson Klemencic Associates 1301 5th Ave. Suite 3200

Lighting Designer O- 1319 SE MLK Blvd, Suite 210 Portland, Oregon 97219
Building Envelope Consultant RDH

Seattle, WA 98101



Seattle, WA 98109



principal architect_	TK, KM
project manager_	
drawn by _	SK, SS, JR, CP, EA JF, BD
checked by_	JB
job no.	20052
date	11/25/24
revisions:	

M 01/28/25	ASI 007.1	

no. date

IFC SET 3 OF 3 11/25/24

CONCRETE PLAN - TOWER C - LVL 7

A2.1C.17