## **CONCRETE PLAN GENERAL NOTES**

1. WHERE WALLS ALIGN TO GRID, LOCATE FACE OF STUD OR FACE OF CONCRETE AT GRID, U.N.O. 2. FINISH FLOOR ELEVATION TYPICAL ACROSS LEVEL, U.N.O. 3. REFER TO A0.10 AND A0.11 FOR ASSEMBLIES. 4. ALL DIMENSIONS ARE TO FACE OF CONCRETE AND CENTERLINE OF CONCRETE COLUMN, U.N.O. 5. T.O. CURBS 4" A.F.F. ,MAXIMUM 6" A.F.F., WHERE SLAB IS SLOPED, U.N.O. 6. MIN. 1% SLOPE TO DRAINS 7. TOP OF CONCRETE SLAB ELEVATIONS PROVIDED FOR REFERENCE. CONTRACTOR SHALL COORDINATE WITH FINISH FLOOR ELEVATIONS PROVIDED ON ARCHITECTURAL PLANS AND ADJUST CONCRETE AS NECESSARY 8. CEILING HEIGHTS MEASURED FROM TOP OF CONCRETE - SEE SECTIONS. 9. COORDINATE WITH ALL ENLARGED PLANS FOR ADDITIONAL INFORMATION AND DETAILS. 10. COORDINATE WITH STRUCTURAL FRAMING PLANS AND SHEAR WALL PLANS FOR SIZE, DETAILS, AND REINFORCING FOR COLUMNS, BEAMS, SHEAR WALLS, ETC.

11. COORDINATE WITH ELECTRICAL DRAWINGS FOR ALL LIGHTING, POWER, AND DATA REQUIREMENTS.


12. COORDINATE WITH MECHANICAL DRAWINGS FOR ALL PLUMBING AND MECHANICAL PENETRATIONS.


## **CONCRETE PLAN LEGEND**


SLAB PENETRATION






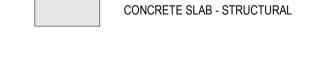

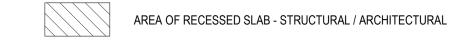


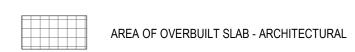


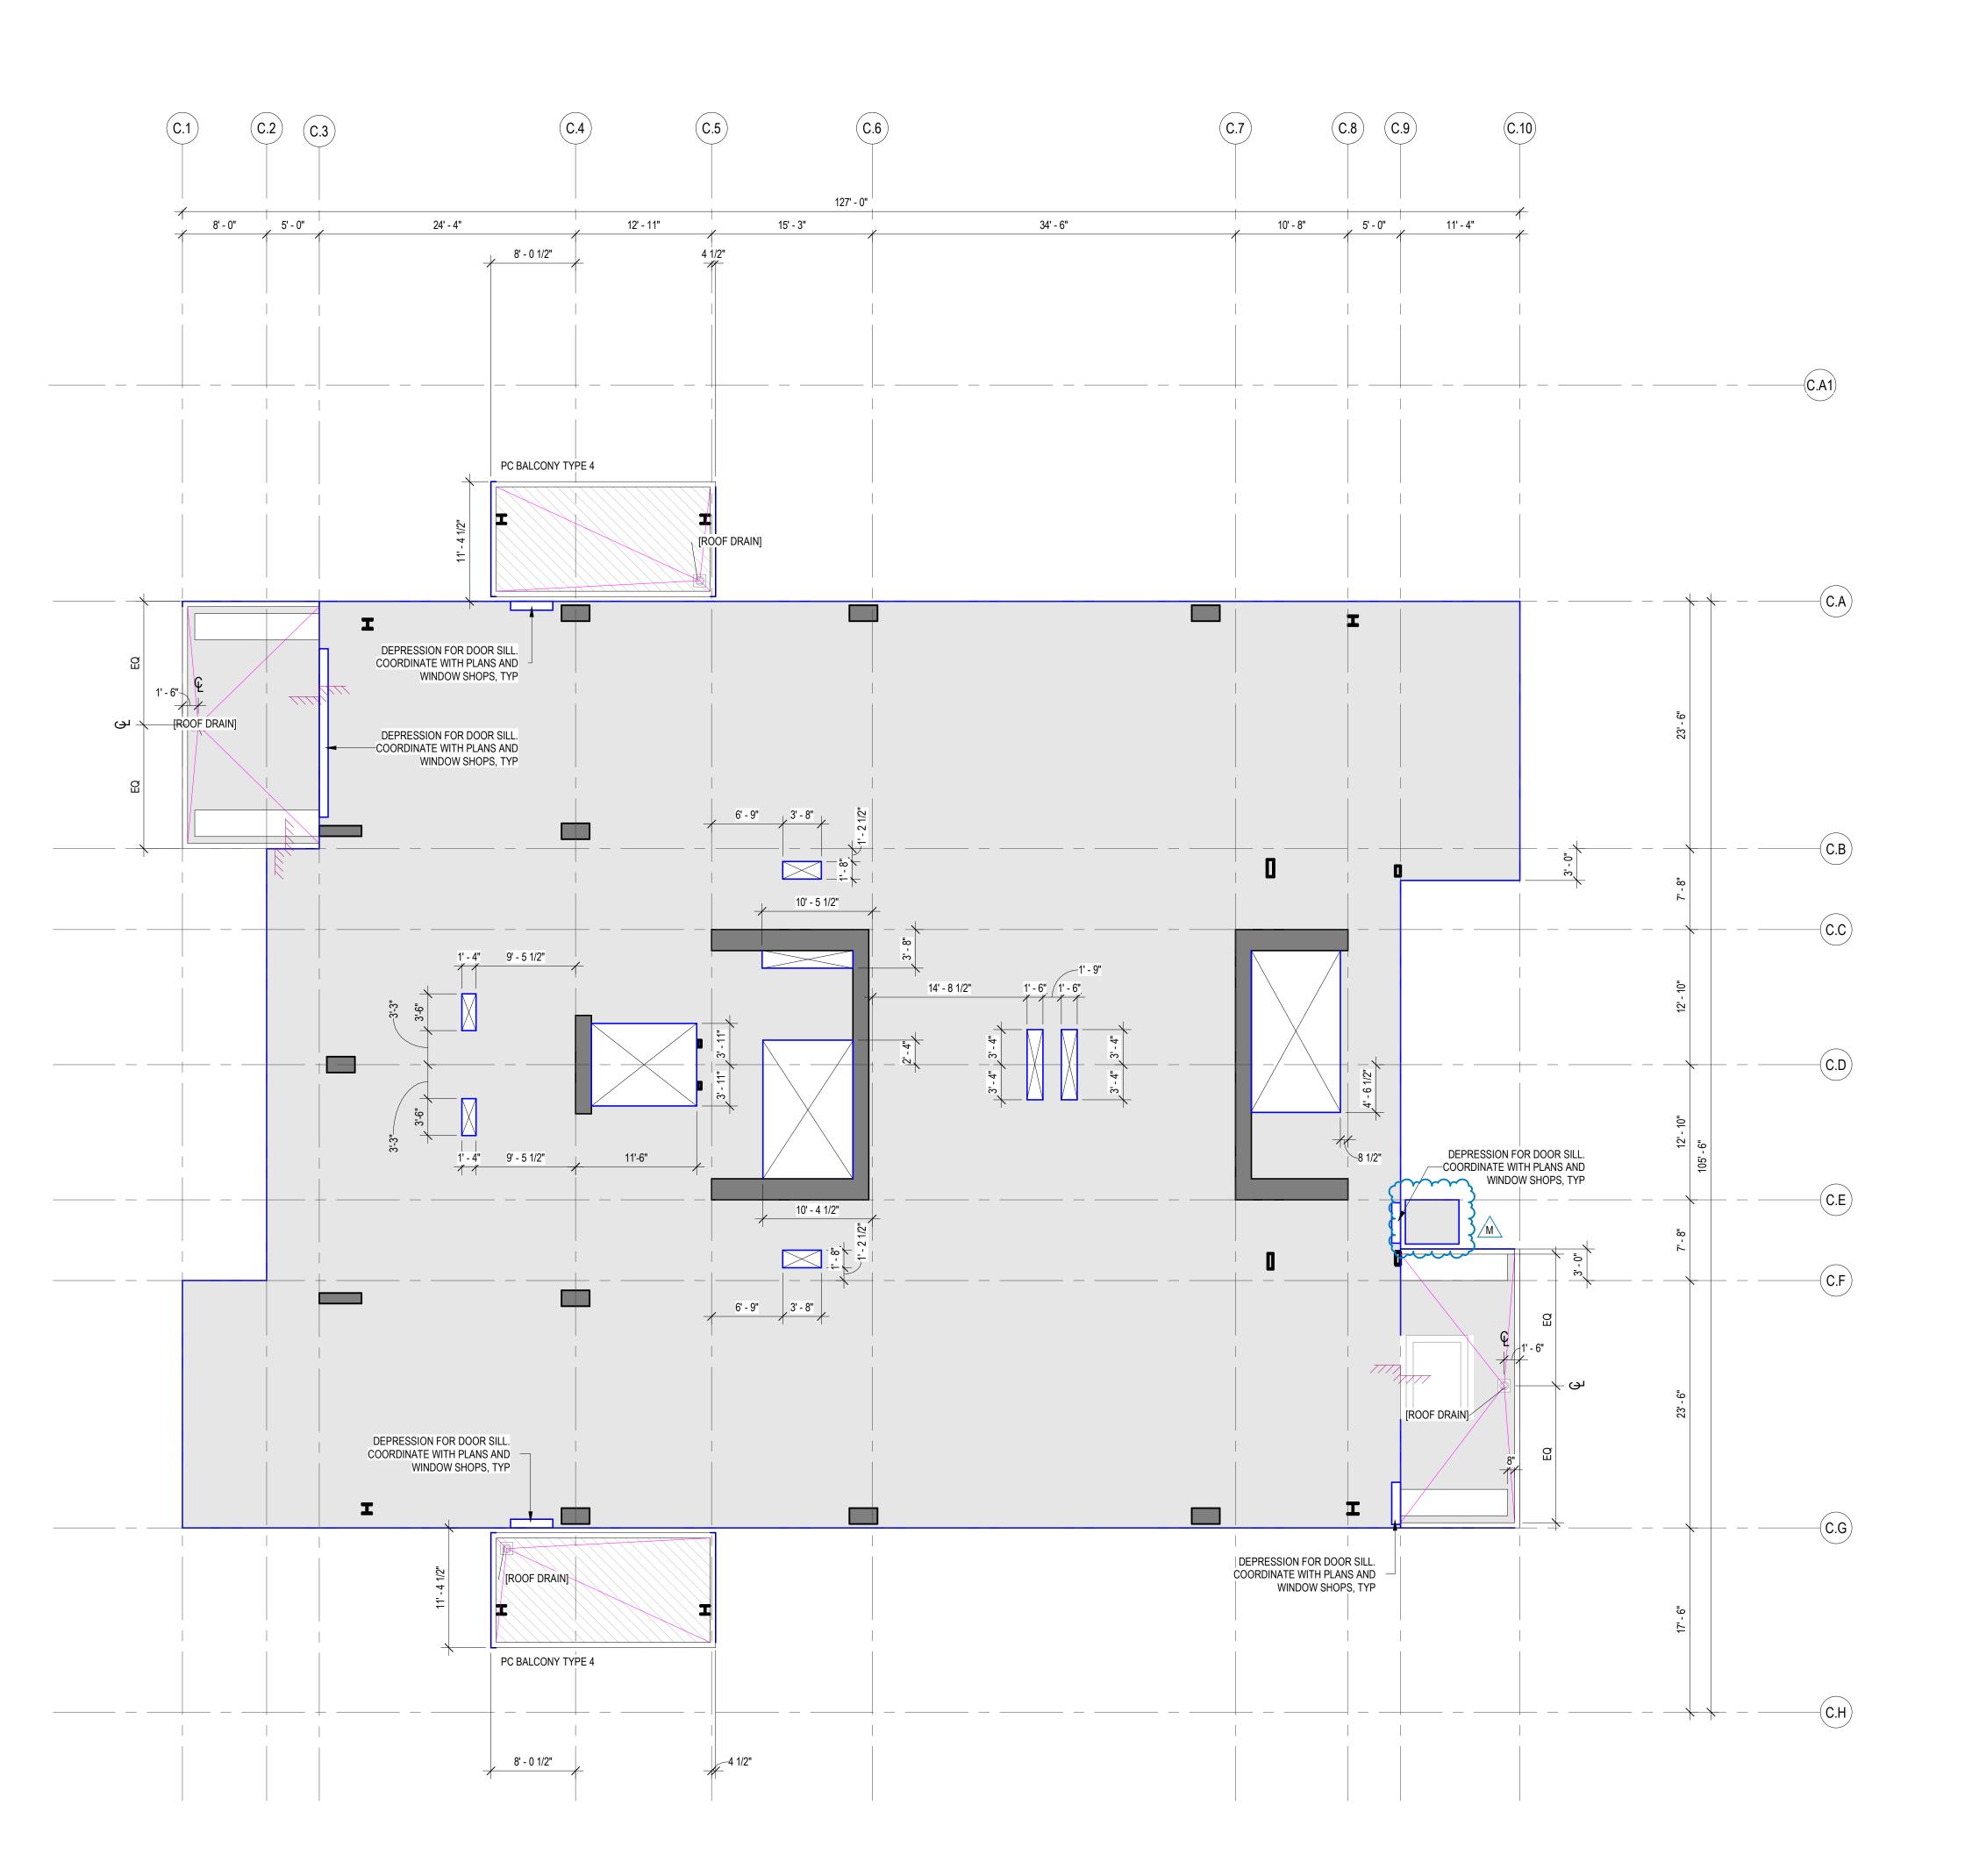



1 CONCRETE PLAN - TOWER C - LVL 5

SCALE: 1/8" = 1'-0"

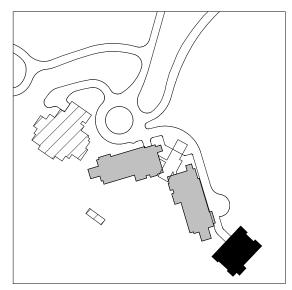

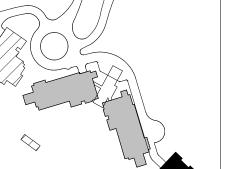

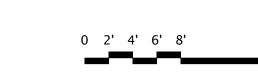

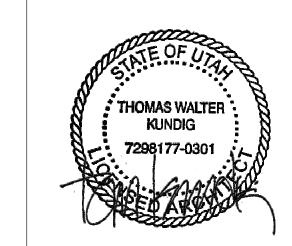

• —

**ASPEN** GROUP Aspen Group USA, LLC PO Box 980022

Park City, Utah 84098



Specifications Writer Friday Group 88 Mainelli Road Middlebury, VT Code Consultant Holmes

Midvale, Utah 84047

Seattle, WA 98104 Fire Protection Engineer

Jensen Hughes

One Research Drive, Suite 305C

Westborough, MA 01581

600 1st Avenue, Suite 200A

Vertical Transportation Consulatant Lerch Bates 19515 North Creek Parkway, Suite 304 Bothell, WA 98011

Structural Engineer
Magnusson Klemencic Associates 1301 5th Ave, Suite 3200 Seattle, WA 98101

1319 SE MLK Blvd, Suite 210 Portland, Oregon 97219 Building Envelope Consultant
RDH

<u>Lighting Designer</u>

2101 N 34th St Seattle, WA 98103

Accessibility Consultant
Studio Pacifica 2144 Westlake Ave N, Suite F Seattle, WA 98109

MEP Engineer
WSP USA
1001 Fourth Ave., Suite 3100
Seattle, WA 98154

principal architect <u>TK, KM</u> project manager TM, JB, SL, MD

drawn by SK, SS, JR, CP, EA,

JF, BD \_\_\_\_

checked by JB job no. 20052 date 11/25/24

M 01/28/25 ASI 007.1 A 05/17/24 IFC - REV 1 no. date

> IFC SET 3 OF 3 11/25/24

CONCRETE PLAN -TOWER C - LVL 5 A2.1C.15