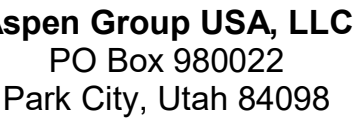


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principal architect _____
project manager _____
drawn by _____
checked by Checker
job no. _____
date 5/31/2024

ions:

date	time	location	weather	temp	humidity	wind	precip	clouds	visibility	pressure	uv	air quality
2023-10-27	08:00	San Francisco	Clear	65	65	10	0.0	10	10	30.0	4	Good
2023-10-27	12:00	San Francisco	Clear	75	60	15	0.0	10	10	30.0	4	Good
2023-10-27	16:00	San Francisco	Clear	70	60	15	0.0	10	10	30.0	4	Good
2023-10-27	20:00	San Francisco	Clear	60	65	10	0.0	10	10	30.0	4	Good
2023-10-28	08:00	San Francisco	Clear	65	65	10	0.0	10	10	30.0	4	Good
2023-10-28	12:00	San Francisco	Clear	75	60	15	0.0	10	10	30.0	4	Good
2023-10-28	16:00	San Francisco	Clear	70	60	15	0.0	10	10	30.0	4	Good
2023-10-28	20:00	San Francisco	Clear	60	65	10	0.0	10	10	30.0	4	Good
2023-10-29	08:00	San Francisco	Clear	65	65	10	0.0	10	10	30.0	4	Good
2023-10-29	12:00	San Francisco	Clear	75	60	15	0.0	10	10	30.0	4	Good
2023-10-29	16:00	San Francisco	Clear	70	60	15	0.0	10	10	30.0	4	Good
2023-10-29	20:00	San Francisco	Clear	60	65	10	0.0	10	10	30.0	4	Good
2023-10-30	08:00	San Francisco	Clear	65	65	10	0.0	10	10	30.0	4	Good
2023-10-30	12:00	San Francisco	Clear	75	60	15	0.0	10	10	30.0	4	Good
2023-10-30	16:00	San Francisco	Clear	70	60	15	0.0	10	10	30.0	4	Good
2023-10-30	20:00	San Francisco	Clear	60	65	10	0.0	10	10	30.0	4	Good

C Set 3 of 3
5/31/2024

POWER A/B ELECTRICAL
LIGHTING PLAN - UNIT E

E3.4.E

A. DRAWINGS ARE INTENDED TO SHOW GENERAL ARRANGEMENT, DESIGN AND EXTENT OF WORK AND ARE DIAGNOSTIC. DRAWINGS ARE NOT INTENDED TO SHOW EXACT LOCATION OF WORK OR TO BE USED AS A BASIS FOR CONSTRUCTION. WORK SHALL BE IN ACCORDANCE WITH STANDARD INDUSTRY SYMBOLS BEFORE ORDERING MATERIALS OR COMMENCEMENT WITH WORK. VERY MEASUREMENTS PERTAINING THERETO AND ANY INCONSISTENCY THEREIN SHALL BE THE RESPONSIBILITY OF THE OWNER.

B. ALL WORK SHALL BE IN ACCORDANCE WITH THE SPECIFICATIONS SET FORTH IN THE DRAWINGS AND CONDITIONS IN THE FIELD SHALL BE SUBMITTED TO THE CONSTRUCTION MANAGER FOR CONSIDERATION BEFORE PROCEEDING WITH WORK.

C. WORK PERFORMANCE INCLUDES LABOR, MATERIALS, AND EQUIPMENT REQUIRED TO INSTALL AND MAINTAIN ELECTRICAL, MECHANICAL, AND PLUMBING AND REPAIRS AND REPAIRS TO EXISTING SYSTEMS AND CONNECTIONS.

D. PROVIDE TEST SIGNS AND CONNECT EXT TEST SIGNS AND LUMINAIRES NOTED AS EMERGENCY TO EMERGENCY POWER SOURCES AS INDICATED ON PLANS.

E. REFER TO THE SPECIFICATIONS FOR THE LOCATION OF THE EMERGENCY POWER SOURCES.

F. FIXTURE CATALOG NUMBERS ARE SUBJECT TO CHANGE BY MANUFACTURER. VERIFY CATALOG NUMBERS FOR ACCURACY.


G. VERIFY EQUIPMENT TYPES AND POWER REQUIREMENTS FOR EQUIPMENT PROVIDED BY OTHERS.

H. ELECTRICAL CONDITIONS IN FINISHED SPACES SHALL BE CONCEALED. COORDINATE WITH OTHER TRADES AND USE CABS AND CEILING SPACES. LOCATIONS OF ELECTRICAL UNITS AND IN FINISHED SPACES SHALL BE APPROVED BY ARCHITECT PRIOR TO ROUGH-IN.

I. COORDINATE REMOTE DRIVER MOUNTING LOCATIONS WITH ARCHITECT PRIOR TO ROUGH-IN.

J. COORDINATE LUMINAIRE VOLTAGE WITH ARCHITECT AND OWNER PRIOR TO PURCHASE AND INSTALLATION PLANTY FOR ALL UNITS LIGHTING.

- 1 LUTRON WIRELESS PICO CONTROL SWITCH IS TO BE SUPPLIED AND INSTALLED FOR SHADE CONTROL.
- 2 SUPPLY AND INSTALL LUTRON RADIO RA2 SYSTEM TO PROVIDE PARTIAL LIGHTING CONTROL IN THE RESIDENTIAL UNITS. MASTER
- 3 BEDROOM (NOTED AS BED1) AND ALL ROOMS WITH MORE THAN THREE (3) LIGHTING CONTROL ZONES ARE TO BE
- 4 CONTROLLED BY THE LUTRON RADIO RA2 SYSTEM. ALL ROOMS WITH THREE (3) LIGHTING CONTROL ZONES OR LESS ARE TO
- 5 BE CONTROLLED BY LOCATED DIMMERS.
- 6 SUPPLY AND INSTALL CEILING MOUNTED JUNCTION BOX COMPLETE WITH CAPPED LIGHTING CIRCUIT WIRING FOR INSTALLATION
- 7 OF THE LUTRON LIGHT FIXTURES.
- 8 LIGHT FIXTURE LOCATED IN CLOSETS ARE TO BE CONTROLLED BY CLOSET DOOR JAM SWITCH.
- 9 REFER TO ARCHITECTURAL DRAWINGS AND ELEVATIONS FOR EXACT DIMENSION AND MOUNTING LOCATION OF LIGHT FIXTURE
- 10 TYPE L04. COORDINATE WITH MILLWORK CONTRACTOR PRIOR TO INSTALLATION.

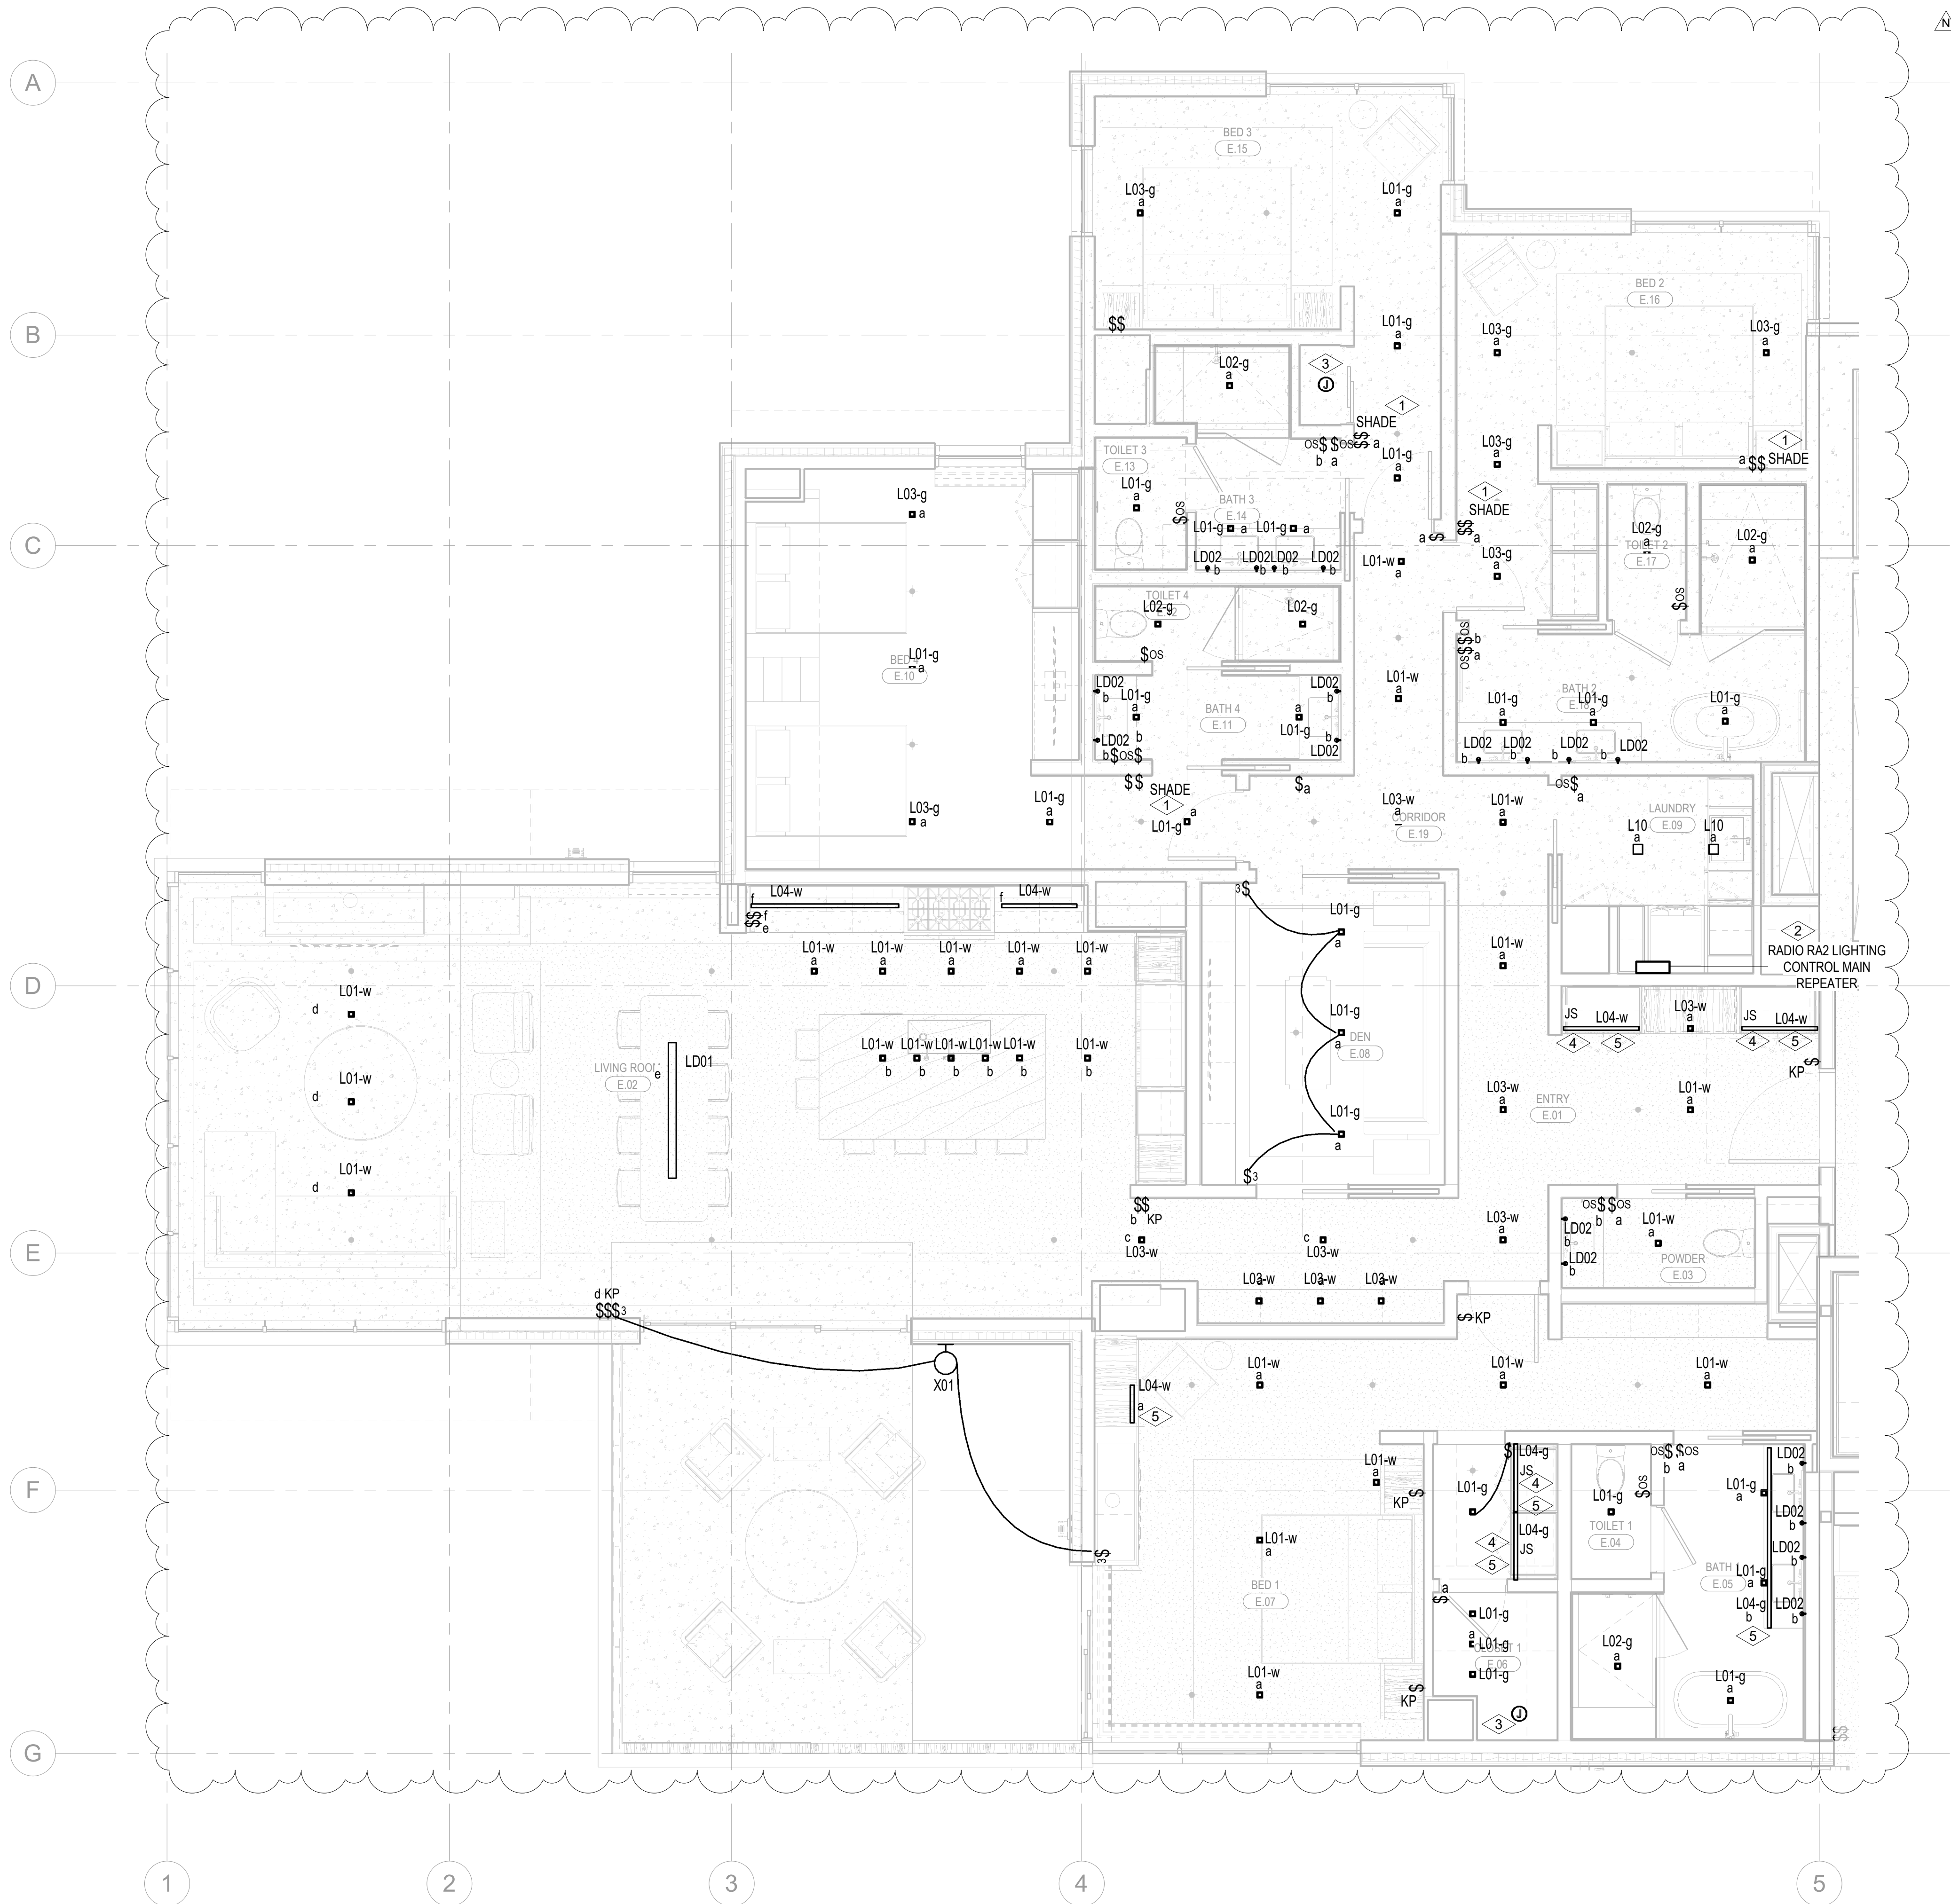

1 TOWER A/B - ELECTRICAL LIGHTING PLAN - UNIT E
SCALE: 1/4" = 1'-0"

