159 South Jackson St, Suite 600 Seattle, Washington 98104 USA

159 South Seattle, v

SOMMET BLANC
9300 Marsac Ave (B2 East Parc

ASPEN GROUP

Aspen Group USA, LLC
PO Box 980022
Park City, Utah 84098

Pool Consultant
Cloward H20

2696 N University Ave, Suite 290 Provo, UT 84604

Landscape Architect  EPG Design 6949 South High Tech Drive, Suite 100 Midvale, Utah 84047
Specifications Writer Friday Group 88 Mainelli Road Middlebury, VT
Code Consultant Holmes 600 1st Avenue, Suite 200A Seattle, WA 98104
Fire Protection Engineer Jensen Hughes One Research Drive, Suite 305C Westborough, MA 01581
Vertical Transportation Consulatant Lerch Bates 19515 North Creek Parkway, Suite 304 Bothell, WA 98011
Structural Engineer  Magnusson Klemencic Associates 1301 5th Ave, Suite 3200 Seattle, WA 98101
<u>Lighting Designer</u> <b>O-</b> 1319 SE MLK Blvd, Suite 210 Portland, Oregon 97219
Building Envelope Consultant  RDH  2101 N 34th St Seattle, WA 98103

р	rincipal architect	
	project manager	
	drawn by	
	checked by <u>Check</u> e	er
	job no.	
	date 5/31/20	124
	05/21/2025 ASI 011 5/31/2024 IFC 3	

Accessibility Consultant
Studio Pacifica

Seattle, WA 98109

MEP Engineer
WSP USA

2144 Westlake Ave N, Suite F

IFC Set 3 of 3 5/31/2024

TOWER A/B ELECTRICAL LIGHTING PLAN - UNIT Q

E3.4.Q


## **SHEET NOTES:**


- A. DRAWINGS ARE INTENDED TO SHOW GENERAL ARRANGEMENT, DESIGN, AND EXTENT OF WORK AND ARE DIAGRAMMATIC. DRAWINGS ARE NOT INTENDED TO SHOW EXACT LOCATIONS EXCEPT WHERE DIMENSIONS ARE SHOWN. ELECTRICAL WORK IS SHOWN ON PLANS USING STANDARD INDUSTRY SYMBOLS. BEFORE ORDERING MATERIALS OR COMMENCEMENT WITH WORK, VERIFY MEASUREMENTS PERTAINING THERETO AND ASSUME RESPONSIBILITY THEREFOR. ANY SUBSTANTIAL DIFFERENCES BETWEEN DRAWINGS AND CONDITIONS IN THE FIELD SHALL BE SUBMITTED TO THE CONSTRUCTION MANAGER FOR CONSIDERATION BEFORE PROCEEDING WITH WORK.
- BEFORE PROCEEDING WITH WORK.

  B. WORK PERFORMED INCLUDES LABOR, MATERIALS, AND EQUIPMENT REQUIRED TO INSTALL A COMPLETE ELECTRICAL SYSTEM AS INDICATED ON DRAWINGS AND SPECIFICATIONS.

  C. PROVIDE EXIT SIGNS AND CONNECT EXIT SIGNS AND LUMINAIRES NOTED AS EMERGENCY TO EMERGENCY POWER SOURCE AS INDICATED ON PLANS.
- D. REFER TO LUMINAIRE SCHEDULE FOR INFORMATION.
   E. FIXTURE CATALOG NUMBERS ARE SUBJECT TO CHANGE BY MANUFACTURER. VERIFY FIXTURE CATALOG NUMBERS FOR ACCURACY.
- F. VERIFY EQUIPMENT SIZES AND POWER REQUIREMENTS FOR EQUIPMENT PROVIDED BY OTHERS.
   G. ELECTRICAL CONDUITS IN FINISHED SPACES SHALL BE CONCEALED. COORDINATE WITH
- ELECTRICAL CONDUITS IN FINISHED SPACES SHALL BE CONCEALED. COORDINATE WITH OTHER TRADES AND USE CHASES AND CEILING SPACES. LOCATIONS OF ELECTRICAL JUNCTION BOXES IN FINISHED SPACES SHALL BE APPROVED BY ARCHITECT PRIOR TO ROUGH-IN.
- H. COORDINATE REMOTE DRIVER MOUNTING LOCATIONS WITH ARCHITECT PRIOR TO ROUGH-IN.
  I. COORDINATE LUMINAIRE VOLTAGE WITH ARCHITECT AND OWNER PRIOR TO PURCHASE AND WISTALLATION TYPICAL FOR ALL UNIT LIGHTING.

  CONFIRM WITH CLIENT AND OWNER ON UNIT CEILING TYPE FINISH UPGRADES PRIOR TO PURCHASE AND INSTALLATION.

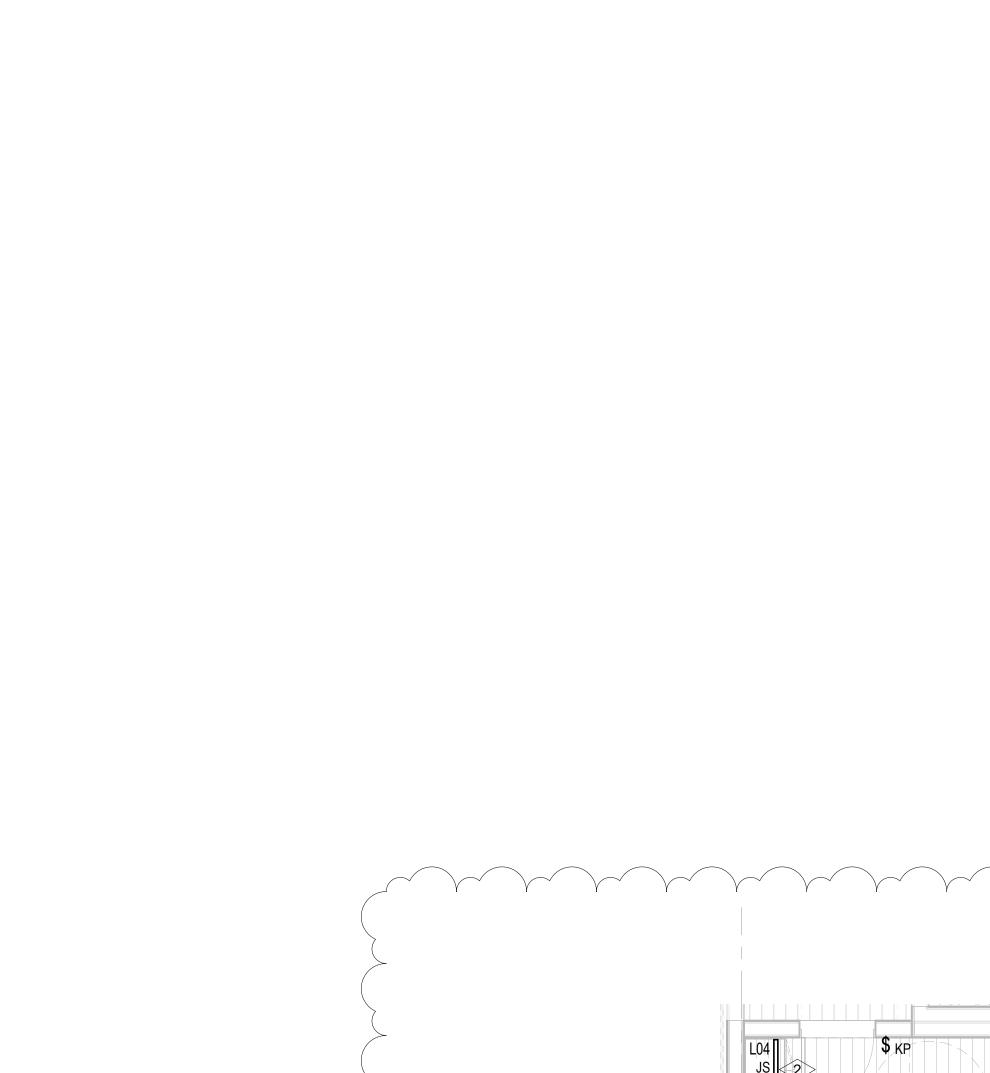

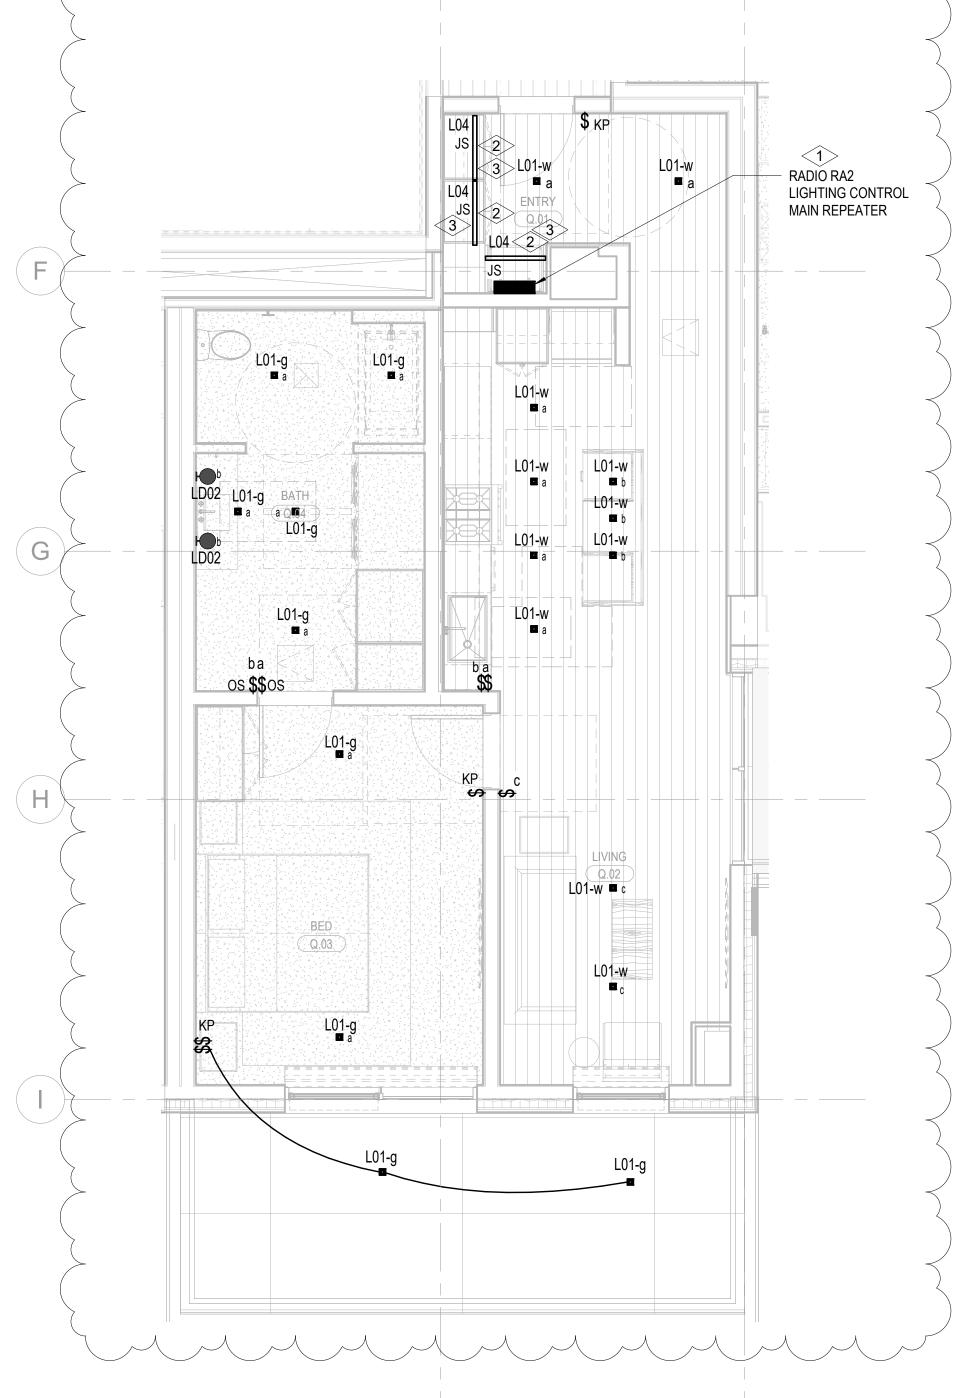

**NUMBERED NOTES:** 

CONTROLLED BY LOCAL DIMMERS.

SUPPLY AND INSTALL LUTRON RADIO RA2 SYSTEM TO PROVIDE PARTIAL LIGHTING CONTROL IN THE RESIDENTIAL UNITS. MASTER

CONTROLLED BY THE LUTRON RADIO RA2 SYSTEM. ALL ROOMS WITH THREE (3) LIGHTING CONTROL ZONES OR LESS ARE TO BE

REFER TO ARCHITECTURAL DRAWINGS AND ELEVATIONS FOR EXACT DIMENSION AND MOUNTING LOCATION OF LIGHT FIXTURE

BEDROOM (DENOTED AS 'BED 1') AND ALL ROOMS WITH MORE THAN THREE (3) LIGHTING CONTROL ZONES ARE TO BE

LIGHT FIXTURE LOCATED IN CLOSETS ARE TO BE CONTROLLED BY CLOSET DOOR JAM SWITCH.

TYPE L04. COORDINATE WITH MILLWORK CONTRACTOR PRIOR TO INSTALLATION.

1 TOWER A/B - ELECTRICAL LIGHTING PLAN - UNIT Q
SCALE: 1/4" = 1'-0"