


3 TOWER C - LEVEL P1 - ELECTRICAL ROOM C010

SCALE: 1/4" = 1'-0"

C.8

(C.7)

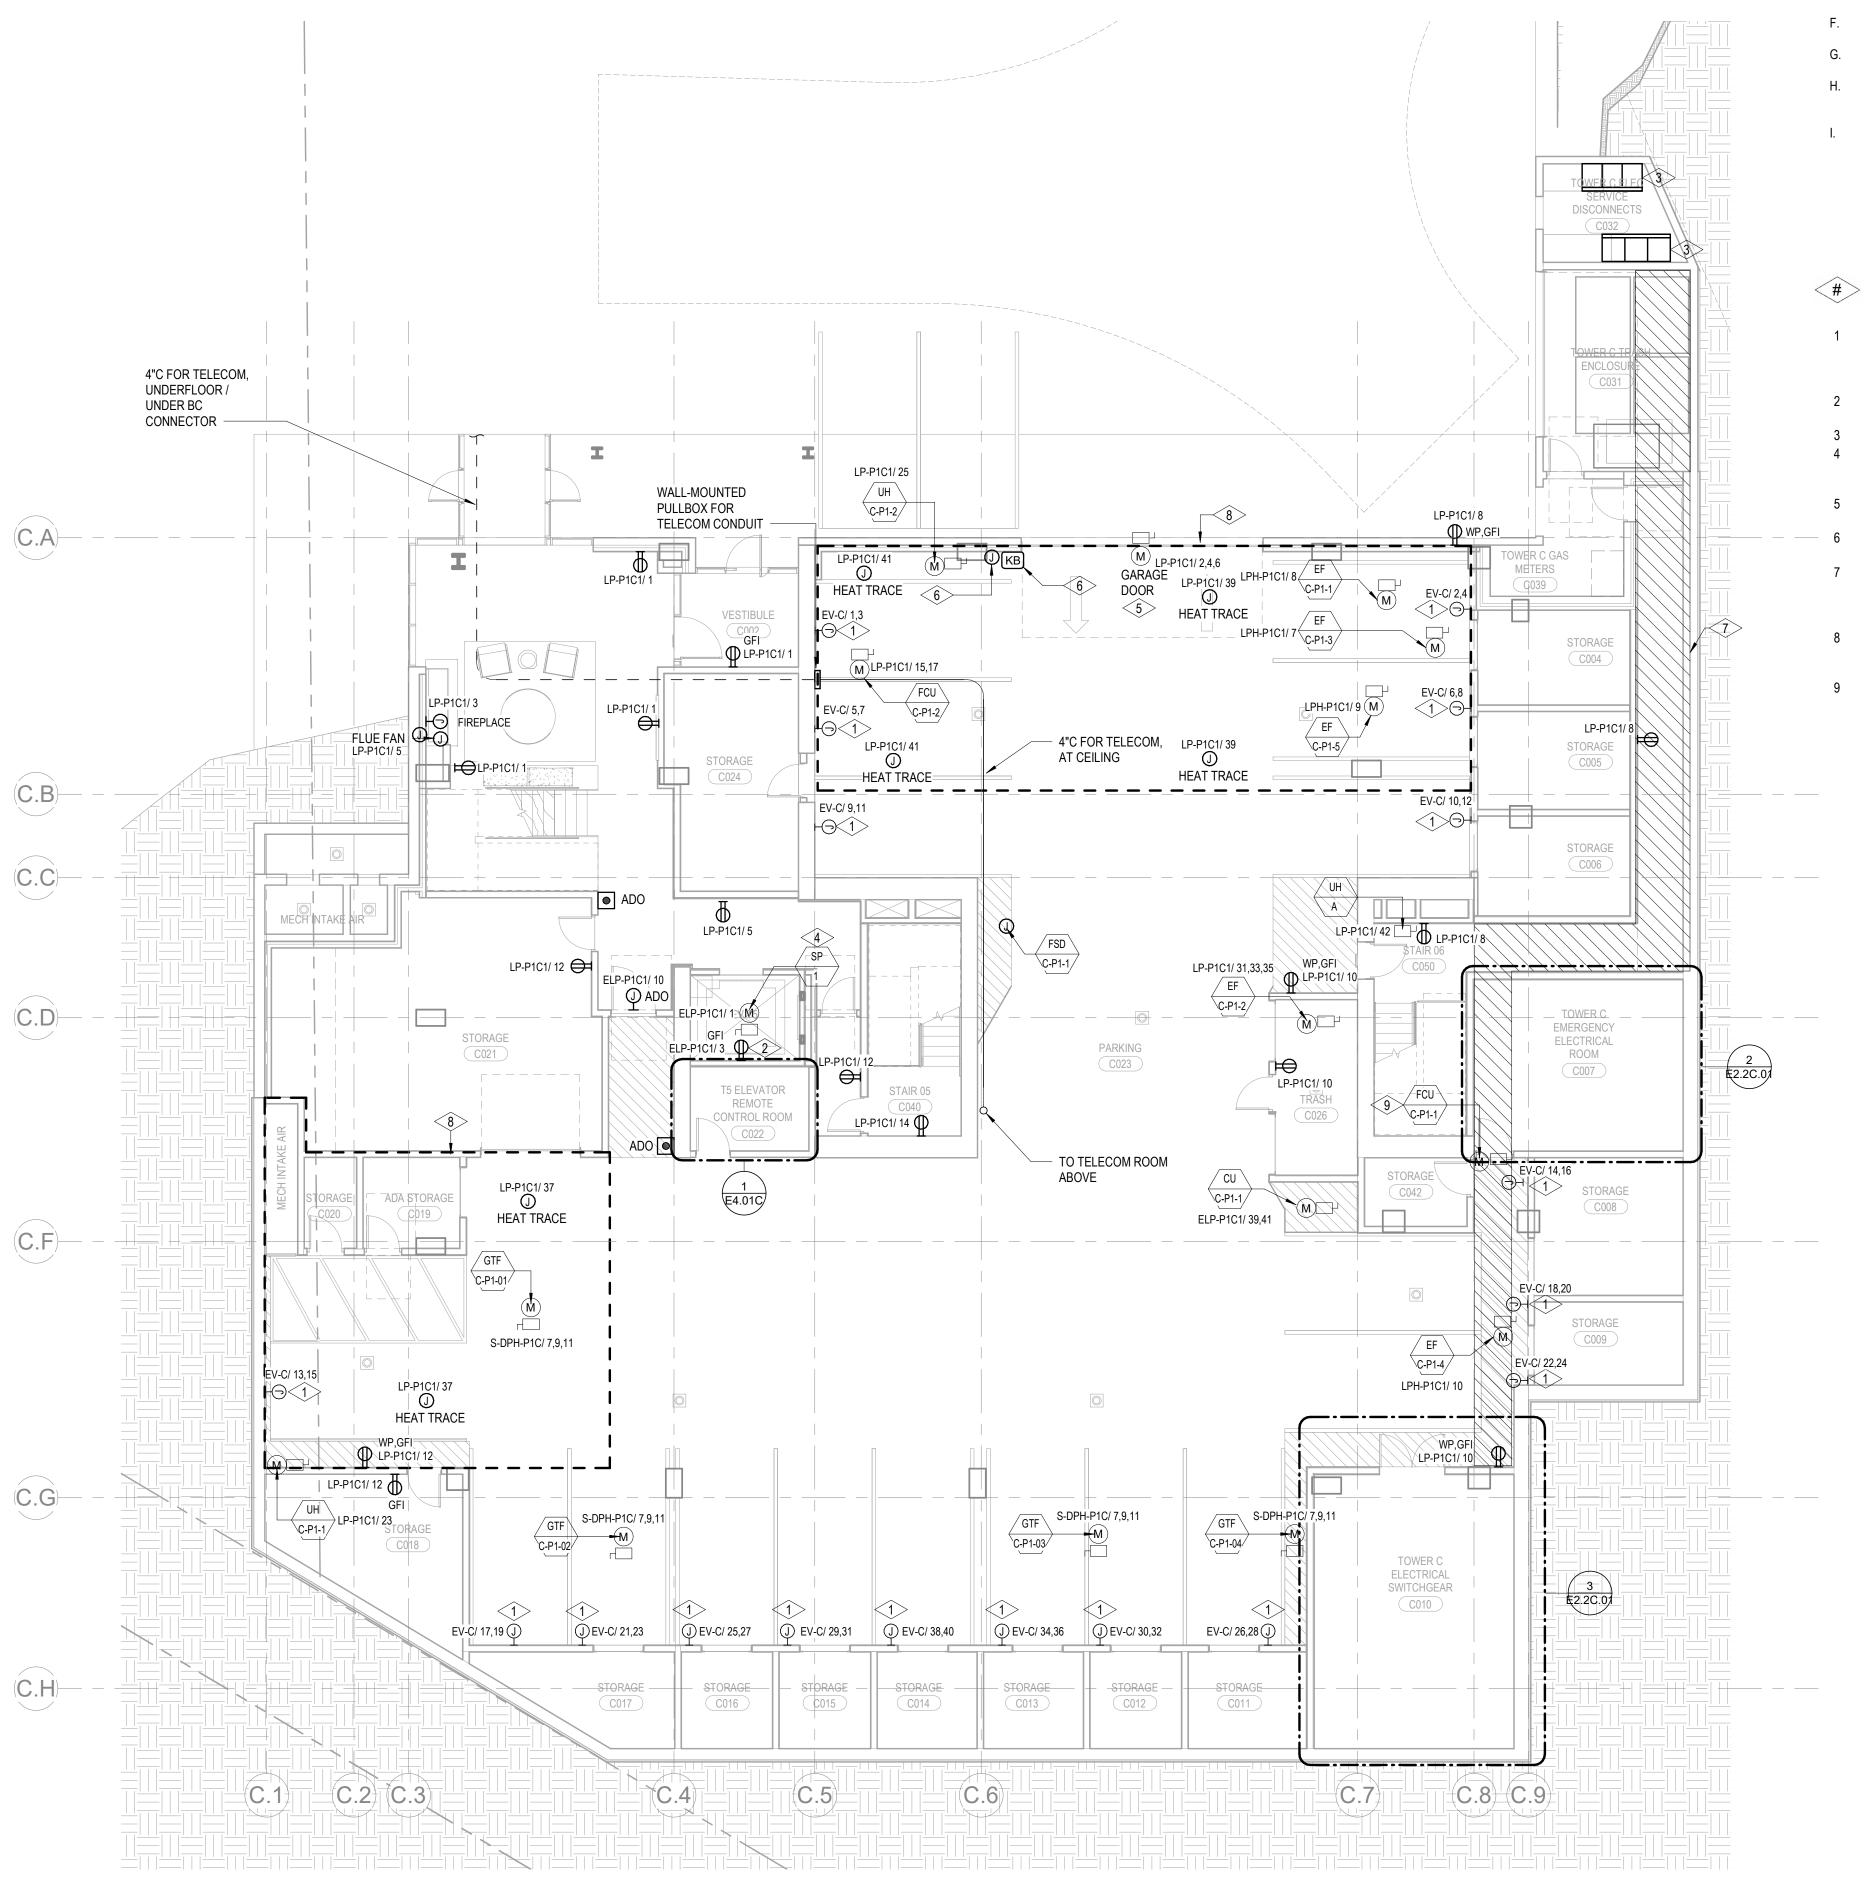

1 TOWER C - PARKING LEVEL ELECTRICAL POWER PLAN

SCALE: 1/8" = 1'-0"



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 C. REFER TO ELECTRICAL CONNECTION SCHEDULE FOR CONDUIT, WIRING, COPD,

DISCONNECT REQUIREMENTS.

D. VERIFY EQUIPMENT SIZES AND POWER REQUIREMENTS FOR EQUIPMENT PROVIDED BY OTHERS.

E. ELECTRICAL CONDUITS IN FINISHED SPACES SHALL BE CONCEALED. COORDINATE WITH OTHER TRADES AND USE CHASES AND CEILING SPACES.LOCATIONS OF ELECTRICAL JUNCTION BOXES IN FINISHED SPACES SHALL BE APPROVED BY ARCHITECT PRIOR TO

F. REFER TO MECHANICAL AND PLUMBING PLANS FOR EXACT LOCATION OF HVAC/PLUMBING EQUIPMENT.
G. PROVIDE CONDUIT, WIRE AND J-BOXES FOR CIRCUITING SHOWN. QUANTITY AND SIZES OF J-BOXES TO BE DETERMINED BY CONTRACTOR.
H. CONTRACTOR SHALL BE RESPONSIBLE FOR REPAIR OF ANY ELECTRICAL CIRCUITS AFFECTED BY CONSTRUCTION. SUCH CIRCUITS WILL BE REPAIRED IMMEDIATELY. THERE WILL BE NO DISRUPTION OF SERVICE OUTSIDE OF CONSTRUCTION ZONE/ AREA.
I. PROVIDE TAMPER PROOF RECEPTACLES IN RESIDENTIAL UNITS AND ALL COMMON AREAS AS PER NEC 406.12.

NUMBERED NOTES:

SUPPLY AND INSTALL SURFACE MOUNTED JUNCTION BOX COMPLETE WITH 2#8 + 1#10G WIRING IN 3/4"C SURFACE MOUNTED CONDUIT FOR EV CAR CHARGER. EXACT LOCATION AND MOUNTING HEIGHT ARE TO BE COORDINATED WITH EV CAR CHARGER SUPPLIER PRIOR TO CONSTRUCTION.

DUPLEX RECEPTACLE TO BE INSTALLED IN THE ELEVATOR PIT. COORDINATE EXACT

LOCATION WITH ELEVATOR CONTRACTOR.

OUTDOOR MAIN SERVICE DISCONNECTS TO BE INSTALLED ON EQUIPMENT PAD.

PROVIDE GFI PROTECTION IN SUMP PUMP CIRCUIT PER NEC. PROTECTION MAY BE INTEGRAL TO CIRCUIT BREAKER, OR MAY BE MODULE MOUNTED ADJACENT TO PIT RECEPTACLE.


PROVIDE CONDUIT, BOXES, AND WIRING AS REQUIRED BY MANUFACTURER FOR DOOR CONTROLS.

ACCESS CARDS WILL BE INCLUDED FOR THE GARAGE DOOR AND KEYS WILL BE INCLUDED FOR THE METERING ROOM DOOR

SERVICE CONDUITS ENCASED IN CONCRETE AT STRUCTURAL CEILING. DYE ENCASEMENT RED THROUGH-AND-THROUGH AND APPLY PAINTED LABELS PER ROCKY MOUNTAIN POWER REQUIREMENTS. REFER TO STRUCTURAL DRAWINGS FOR INTEGRATION OF ENCASEMENT WITH STRUCTURE. REFER TO ONELINE FOR CONDUIT SIZES AND QUANTITIES.

HEAT TRACE IS TO BE SUPPLIED AND INSTALLED FOR ALL HYDRONIC PIPING IN THE AREA NOTED. REFER TO MECHANICAL DRAWINGS FOR QUANTITY AND EXACT LOCATION OF HYDRONIC PIPING. HEAT TRACE CIRCUITS SHALL BE FED FROM A GFEP-TYPE BREAKER.

FAN COIL INDOOR UNIT DENOTED IS PART OF A SPLIT SYSTEM AND IS TO BE POWERED BY THE OUTDOOR UNIT. ELECTRICAL CONTRACTOR IS TO SUPPLY AND INSTALL THE WIRING AND CONDUITS BETWEEN THE OUTDOOR UNIT AND THE INDOOR UNIT AS PART OF THIS SCOPE OF WORK. REFER TO THE EQUIPMENT CONNECTION SCHEDULE FOR ADDITIONAL

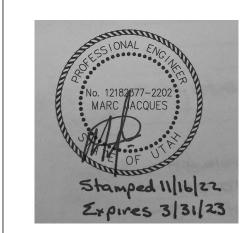

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OMMET BLANC

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Accessibility Consultant
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MEP Engineer
WSP USA
1001 Fourth Ave., Suite 3100
Seattle, WA 98154

principal architect ______

project manager ______

drawn by ______

checked by <u>Checker</u>


date 11/18/2022
revisions:

no. date

ISSUE FOR CONSTRUCTION 11/18/2022

TOWER C - LVL P1
ELECTRICAL POWER
PLAN

E2.2C.01

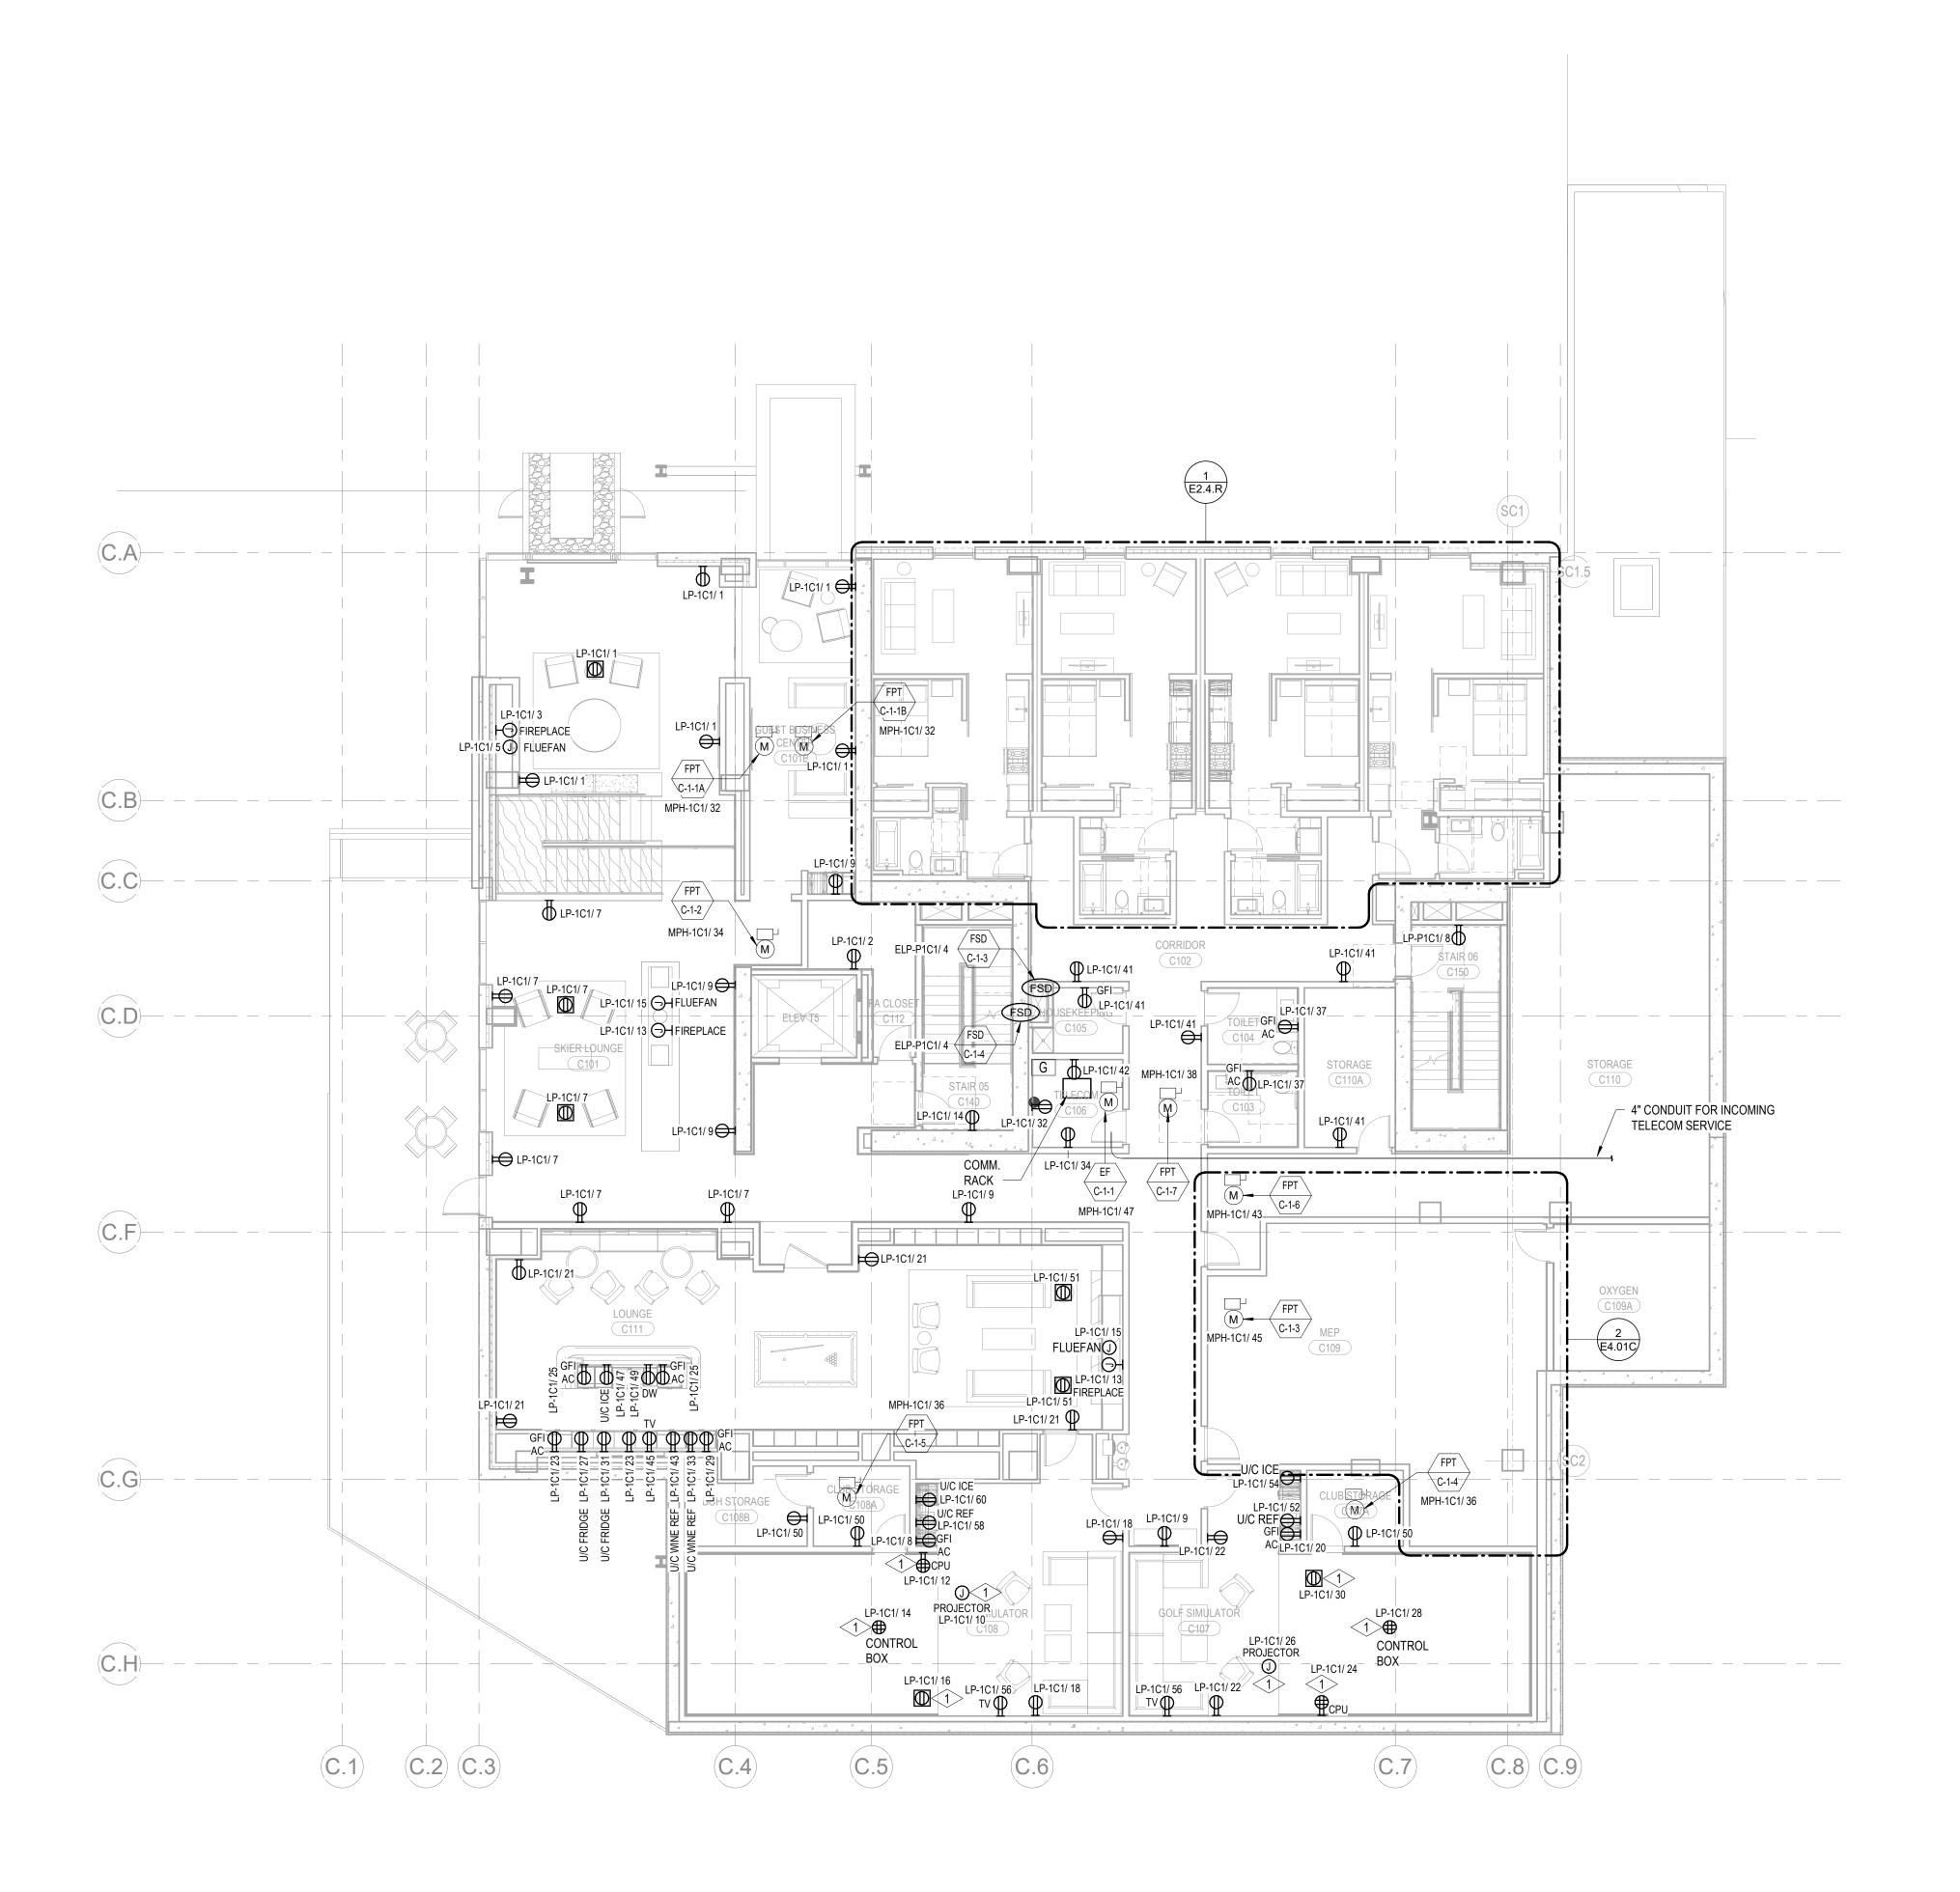

1 TOWER C - LEVEL 1 ELECTRICAL POWER PLAN

SCALE: 1/8" = 1'-0"



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NUMBERED NOTES:

1 COORDINATE EXACT LOCATION WITH GOLF SIMULATOR INSTALLER PRIOR TO CONSTRUCTION.

OISON Marsac Ave (B2 East Parcel)

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MEP Engineer WSP USA 1001 Fourth Ave., Suite 3100 Seattle, WA 98154

project manager ______

drawn by _____

checked by <u>Checker</u>


job no.

date 11/18/2022

principal architect _____

revisions:


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TOWER C - LVL 1
ELECTRICAL POWER
PLAN

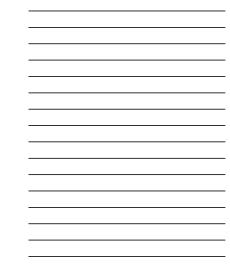
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1 TOWER C - LEVEL 2 ELECTRICAL POWER PLAN

SCALE: 1/8" = 1'-0"



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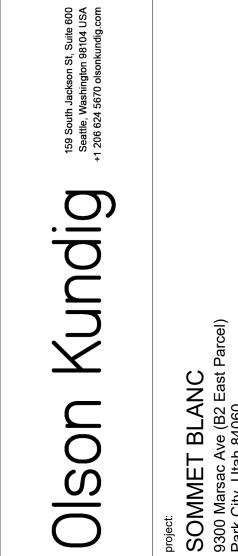
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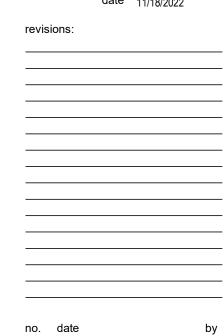
2101 N 34th St Seattle, WA 98103 Accessibility Consultant Studio Pacifica 2144 Westlake Ave N, Suite F
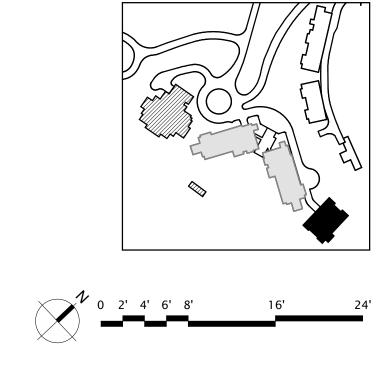
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Seattle, WA 98109 MEP Engineer
WSP USA
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Seattle, WA 98154

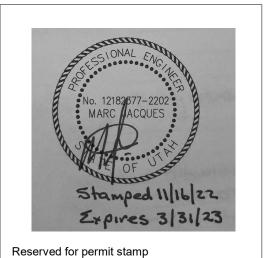principal architect _____ project manager_____


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ISSUE FOR CONSTRUCTION 11/18/2022

TOWER C - LVL 2
ELECTRICAL POWER
PLAN

E2.2C.12



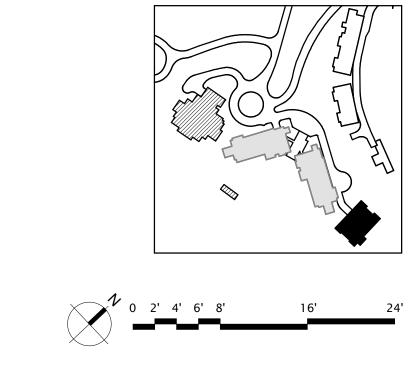

1 TOWER C - LEVEL 3 ELECTRICAL POWER PLAN

SCALE: 1/8" = 1'-0"



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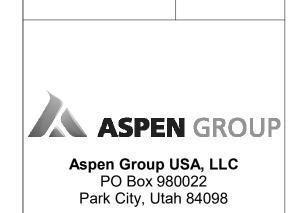
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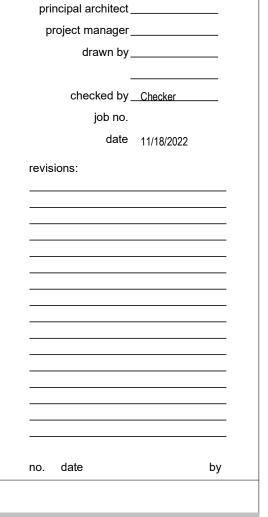
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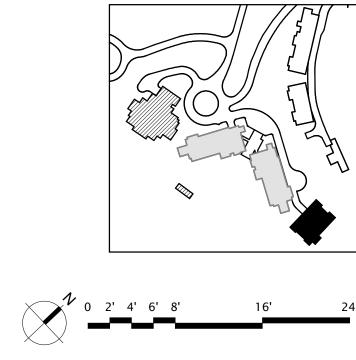
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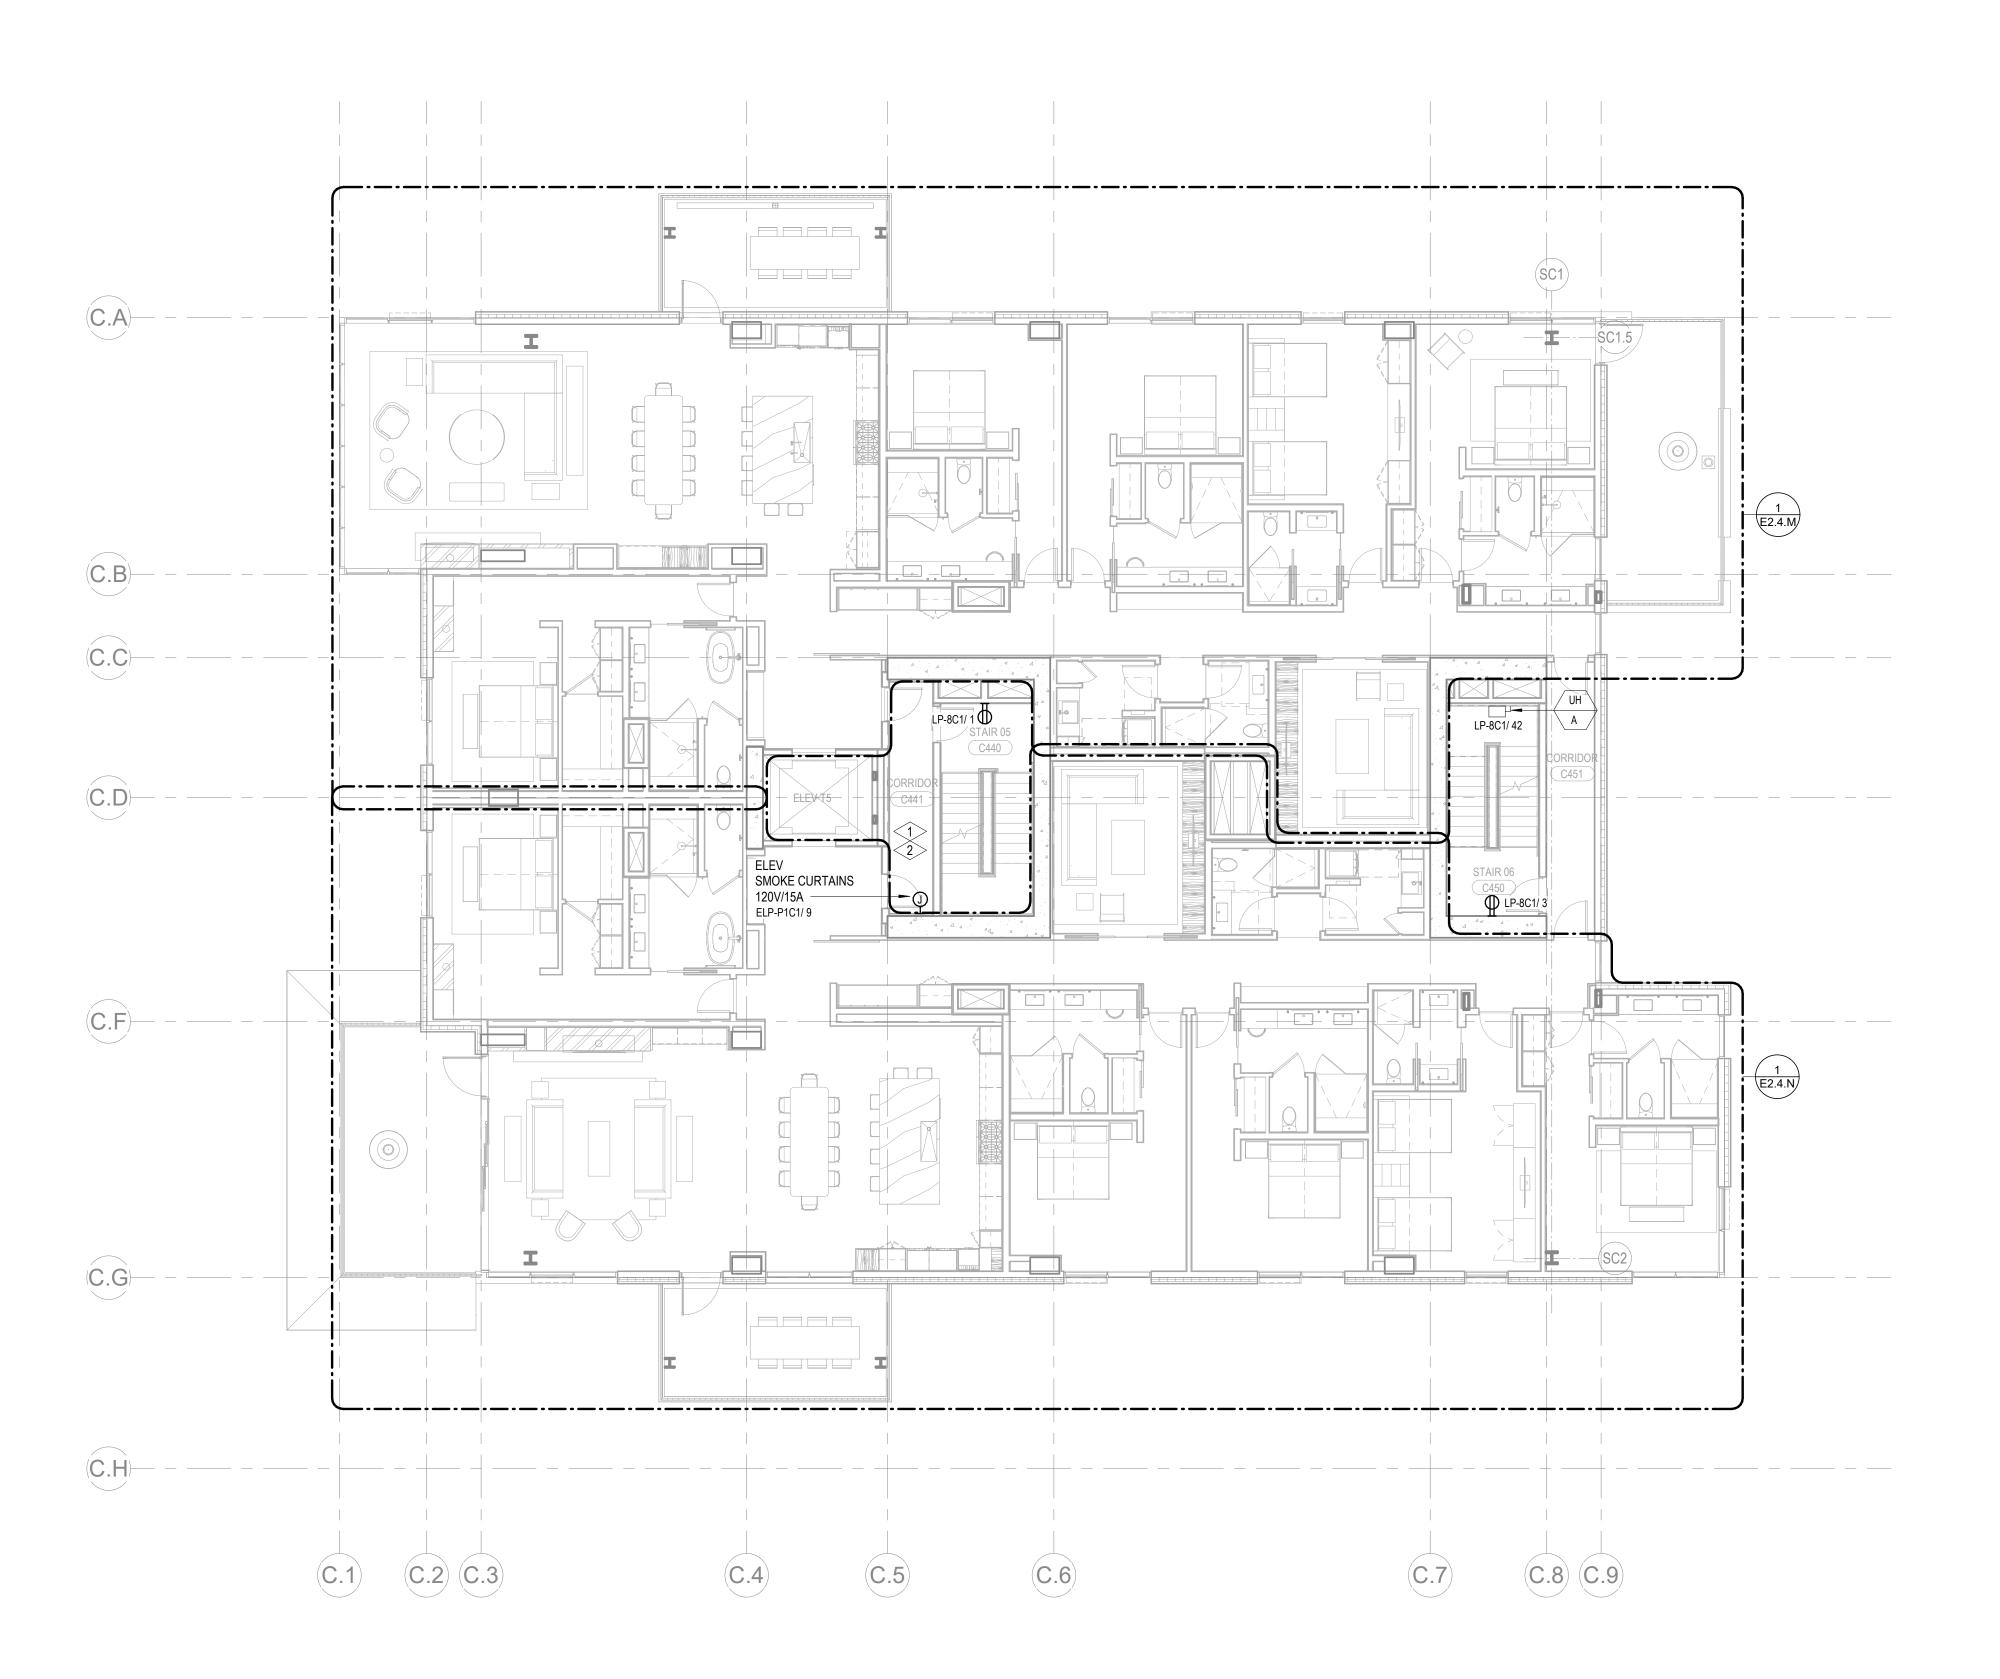


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TOWER C - LVL 3
ELECTRICAL POWER
PLAN


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1 TOWER C - LEVEL 4 ELECTRICAL POWER PLAN

SCALE: 1/8" = 1'-0"



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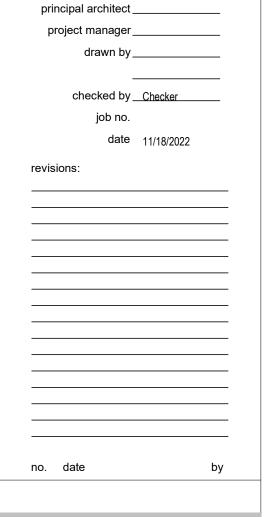
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DISON Marsac Ave (B2 East Parcel)

ASPEN GROUP
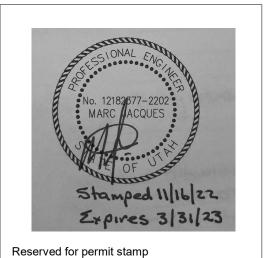
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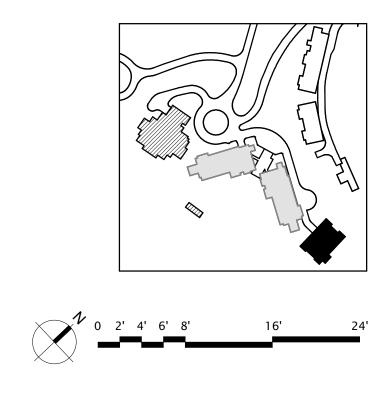
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ISSUE FOR CONSTRUCTION 11/18/2022

TOWER C - LVL 4
ELECTRICAL POWER
PLAN

E2.2C.14





1 TOWER C - LEVEL 5 ELECTRICAL POWER PLAN

SCALE: 1/8" = 1'-0"



SHEET NOTES:

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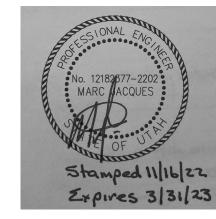
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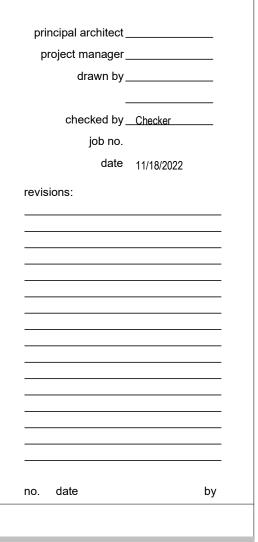
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Olson

ASPEN GROUP Aspen Group USA, LLC PO Box 980022 Park City, Utah 84098


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Studio Pacifica
2144 Westlake Ave N, Suite F Seattle, WA 98109 MEP Engineer
WSP USA 1001 Fourth Ave., Suite 3100 Seattle, WA 98154




ISSUE FOR CONSTRUCTION 11/18/2022

TOWER C - LVL 5
ELECTRICAL POWER
PLAN

E2.2C.15

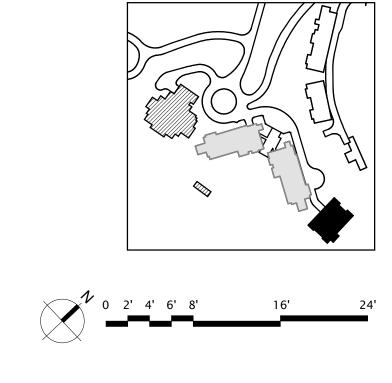

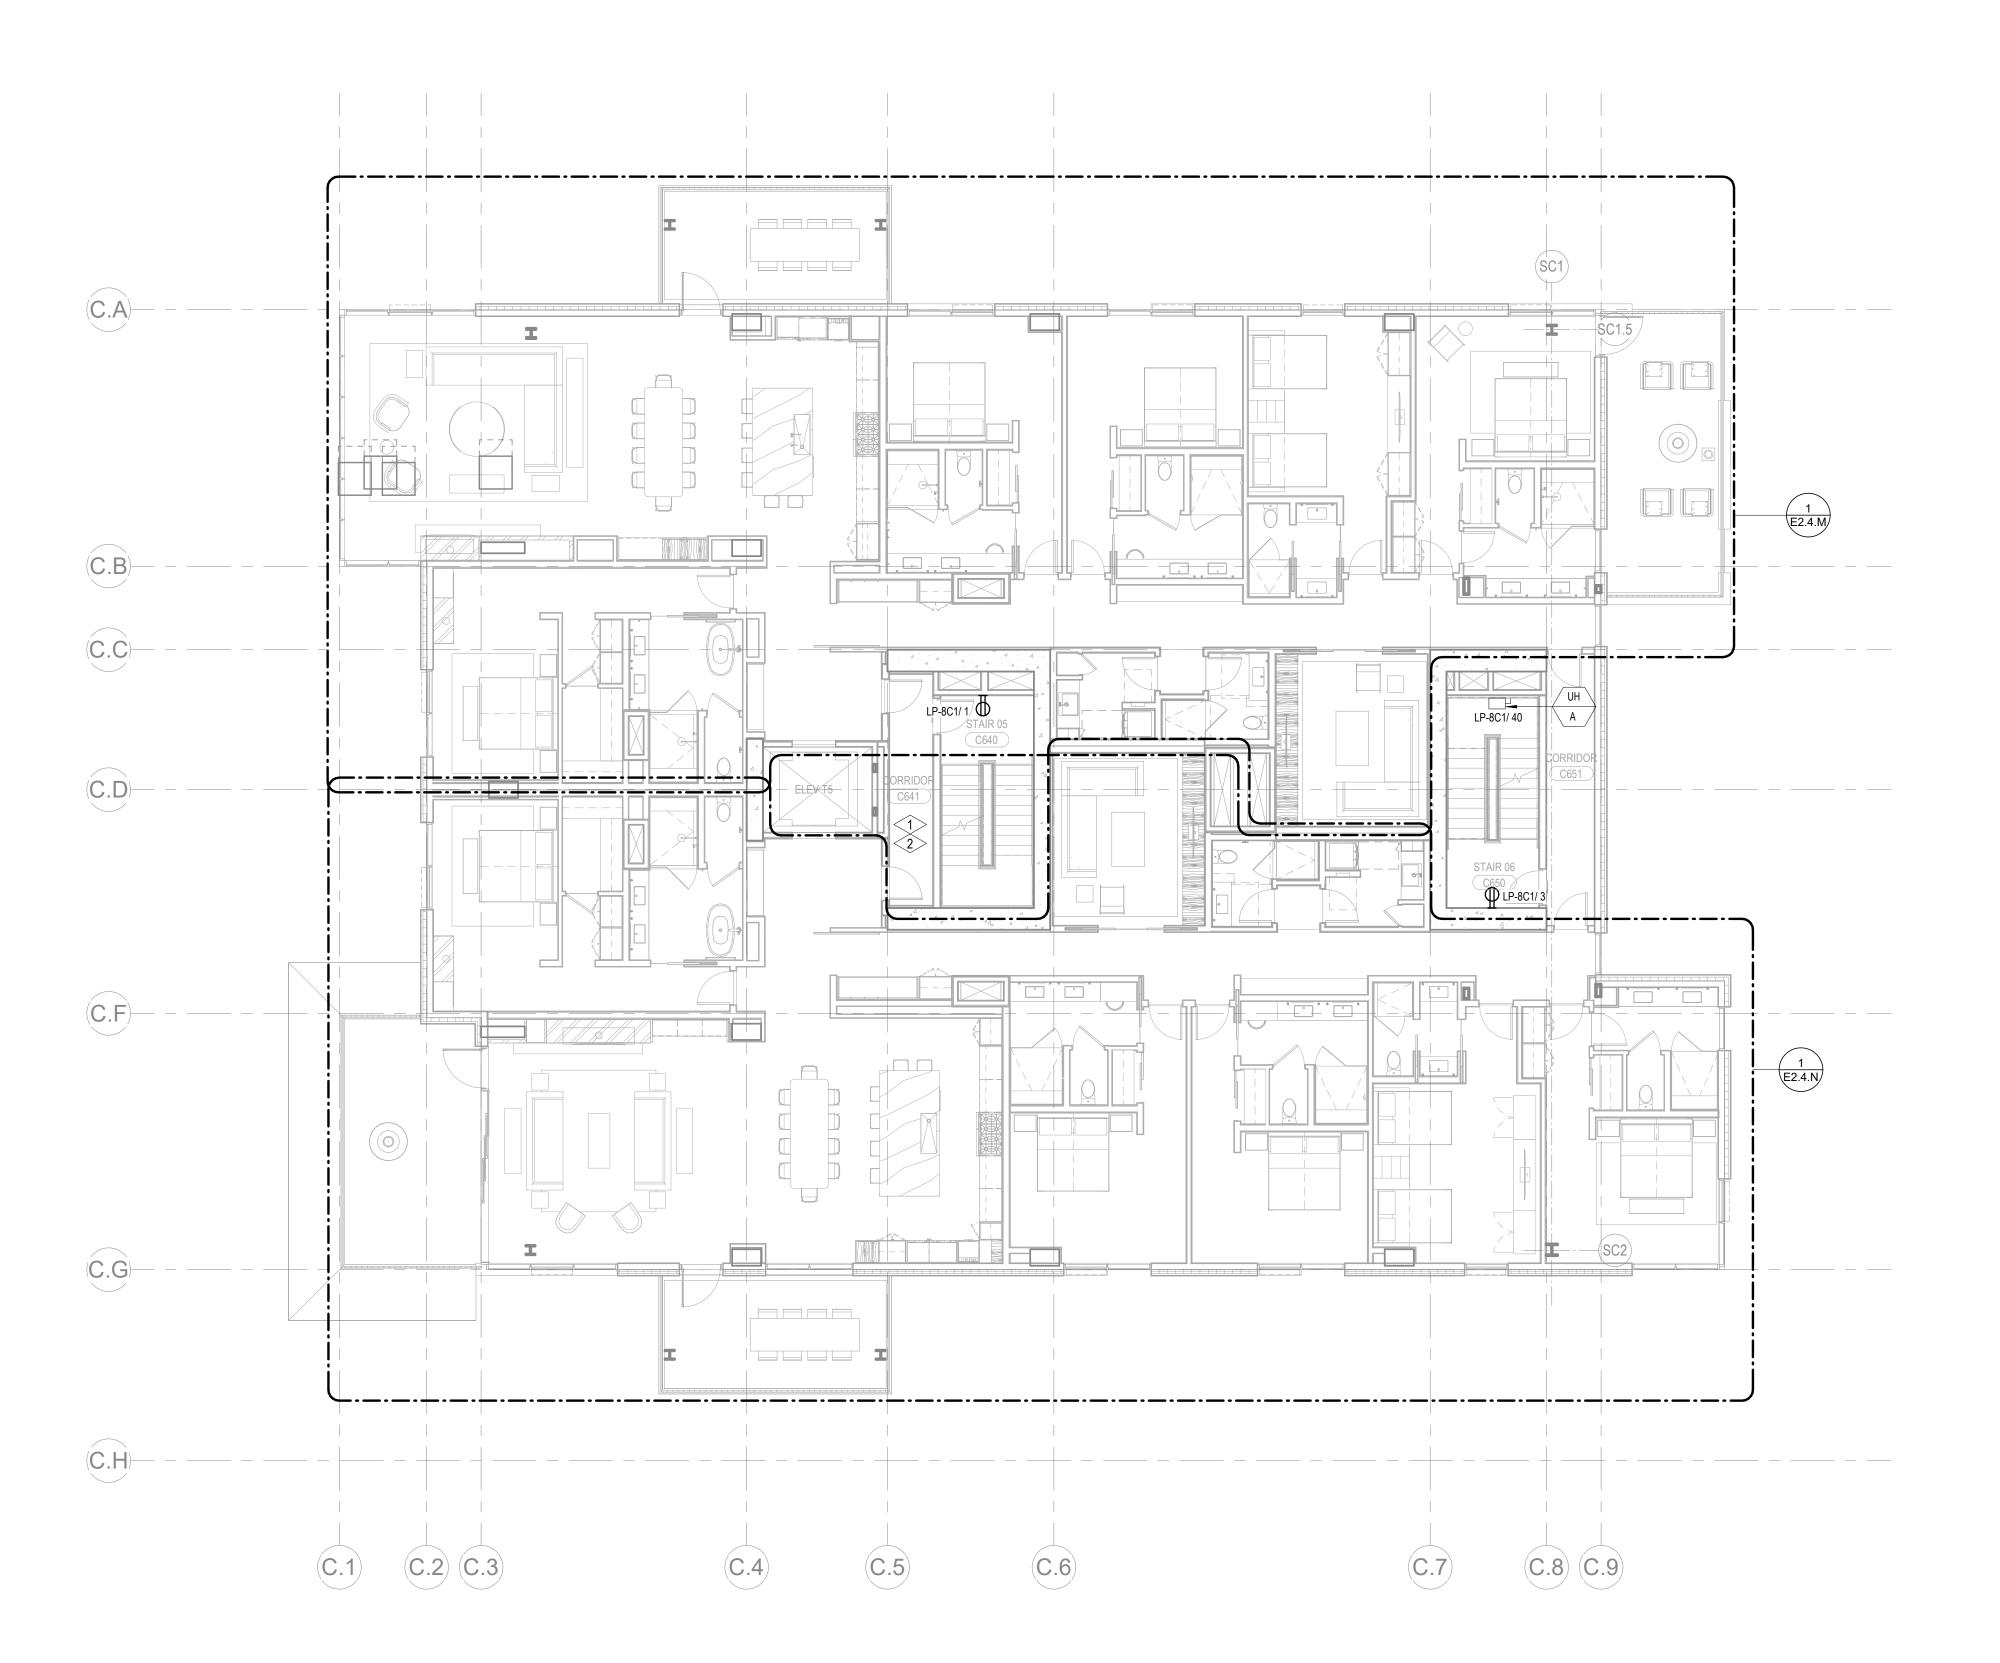

1 TOWER C - LEVEL 6 ELECTRICAL POWER PLAN

SCALE: 1/8" = 1'-0"



SHEET NOTES:

A. DRAWINGS ARE INTENDED TO SHOW GENERAL ARRANGEMENT, DESIGN, AND EXTENT OF WORK AND ARE DIAGRAMMATIC. DRAWINGS ARE NOT INTENDED TO SHOW EXACT LOCATIONS EXCEPT WHERE DIMENSIONS ARE SHOWN. ELECTRICAL WORK IS SHOWN ON PLANS USING STANDARD INDUSTRY SYMBOLS. BEFORE ORDERING MATERIALS OR DOING WORK, VERIFY MEASUREMENTS PERTAINING THERETO AND ASSUME RESPONSIBILITY THEREFOR. ANY SUBSTANTIAL DIFFERENCES BETWEEN DRAWINGS AND CONDITIONS IN THE FIELD SHALL BE SUBMITTED TO THE CONSTRUCTION MANAGER FOR CONSIDERATION BEFORE PROCEEDING WITH WORK.

B. WORK PERFORMED INCLUDES LABOR, MATERIALS, AND EQUIPMENT REQUIRED TO INSTALL

A COMPLETE ELECTRICAL SYSTEM AS INDICATED ON THESE DRAWINGS AND AS SPECIFIED.

C. REFER TO ELECTRICAL CONNECTION SCHEDULE FOR CONDUIT, WIRING, COPD,
DISCONNECT REQUIREMENTS.

D. VERIFY EQUIPMENT SIZES AND POWER REQUIREMENTS FOR EQUIPMENT PROVIDED BY

E. ELECTRICAL CONDUITS IN FINISHED SPACES SHALL BE CONCEALED. COORDINATE WITH OTHER TRADES AND USE CHASES AND CEILING SPACES.LOCATIONS OF ELECTRICAL

JUNCTION BOXES IN FINISHED SPACES SHALL BE APPROVED BY ARCHITECT PRIOR TO ROUGH-IN.

F. REFER TO MECHANICAL AND PLUMBING PLANS FOR EXACT LOCATION OF HVAC/PLUMBING EQUIPMENT.

G. PROVIDE CONDUIT, WIRE AND J-BOXES FOR CIRCUITING SHOWN. QUANTITY AND SIZES OF J-BOXES TO BE DETERMINED BY CONTRACTOR.

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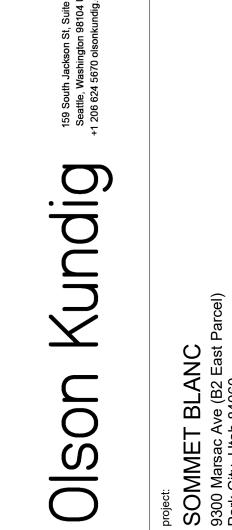
H. CONTRACTOR SHALL BE RESPONSIBLE FOR REPAIR OF ANY ELECTRICAL CIRCUITS AFFECTED BY CONSTRUCTION. SUCH CIRCUITS WILL BE REPAIRED IMMEDIATELY. THERE WILL BE NO DISRUPTION OF SERVICE OUTSIDE OF CONSTRUCTION ZONE/ AREA.

I. PROVIDE TAMPER PROOF RECEPTACLES IN RESIDENTIAL UNITS AND ALL COMMON AREAS AS PER NEC 406.12.

NUMBERED NOTES:

BRANCH CIRCUITS IN EACH DWELLING UNIT SHALL SUPPLY ONLY LOADS WITHIN THAT DWELLING UNIT OR LOADS ASSOCATED ONLY WITH THAT DWELLING UNIT.

2 FEEDERS TO A DWELLING UNIT SHALL NOT ENTER AND BE ROUTED THOUGH ANOTHER DWELLING UNIT.



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<u>Lighting Designer</u> O- 1319 SE MLK Blvd, Suite 210 Portland, Oregon 97219
Building Envelope Consultant


MEP Engineer
WSP USA
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principal architect_____
project manager____
drawn by_____

Accessibility Consultant
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2101 N 34th St Seattle, WA 98103


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date 11/18/2022
revisions:




ISSUE FOR CONSTRUCTION 11/18/2022

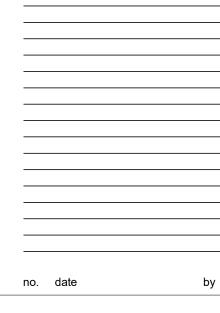TOWER C - LVL 6
ELECTRICAL POWER
PLAN

E2.2C.16

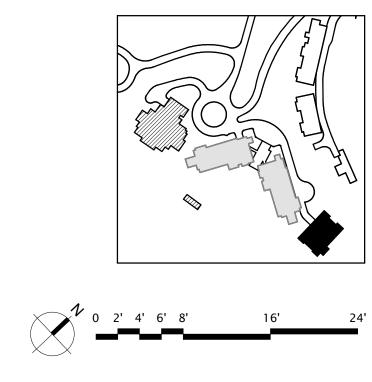

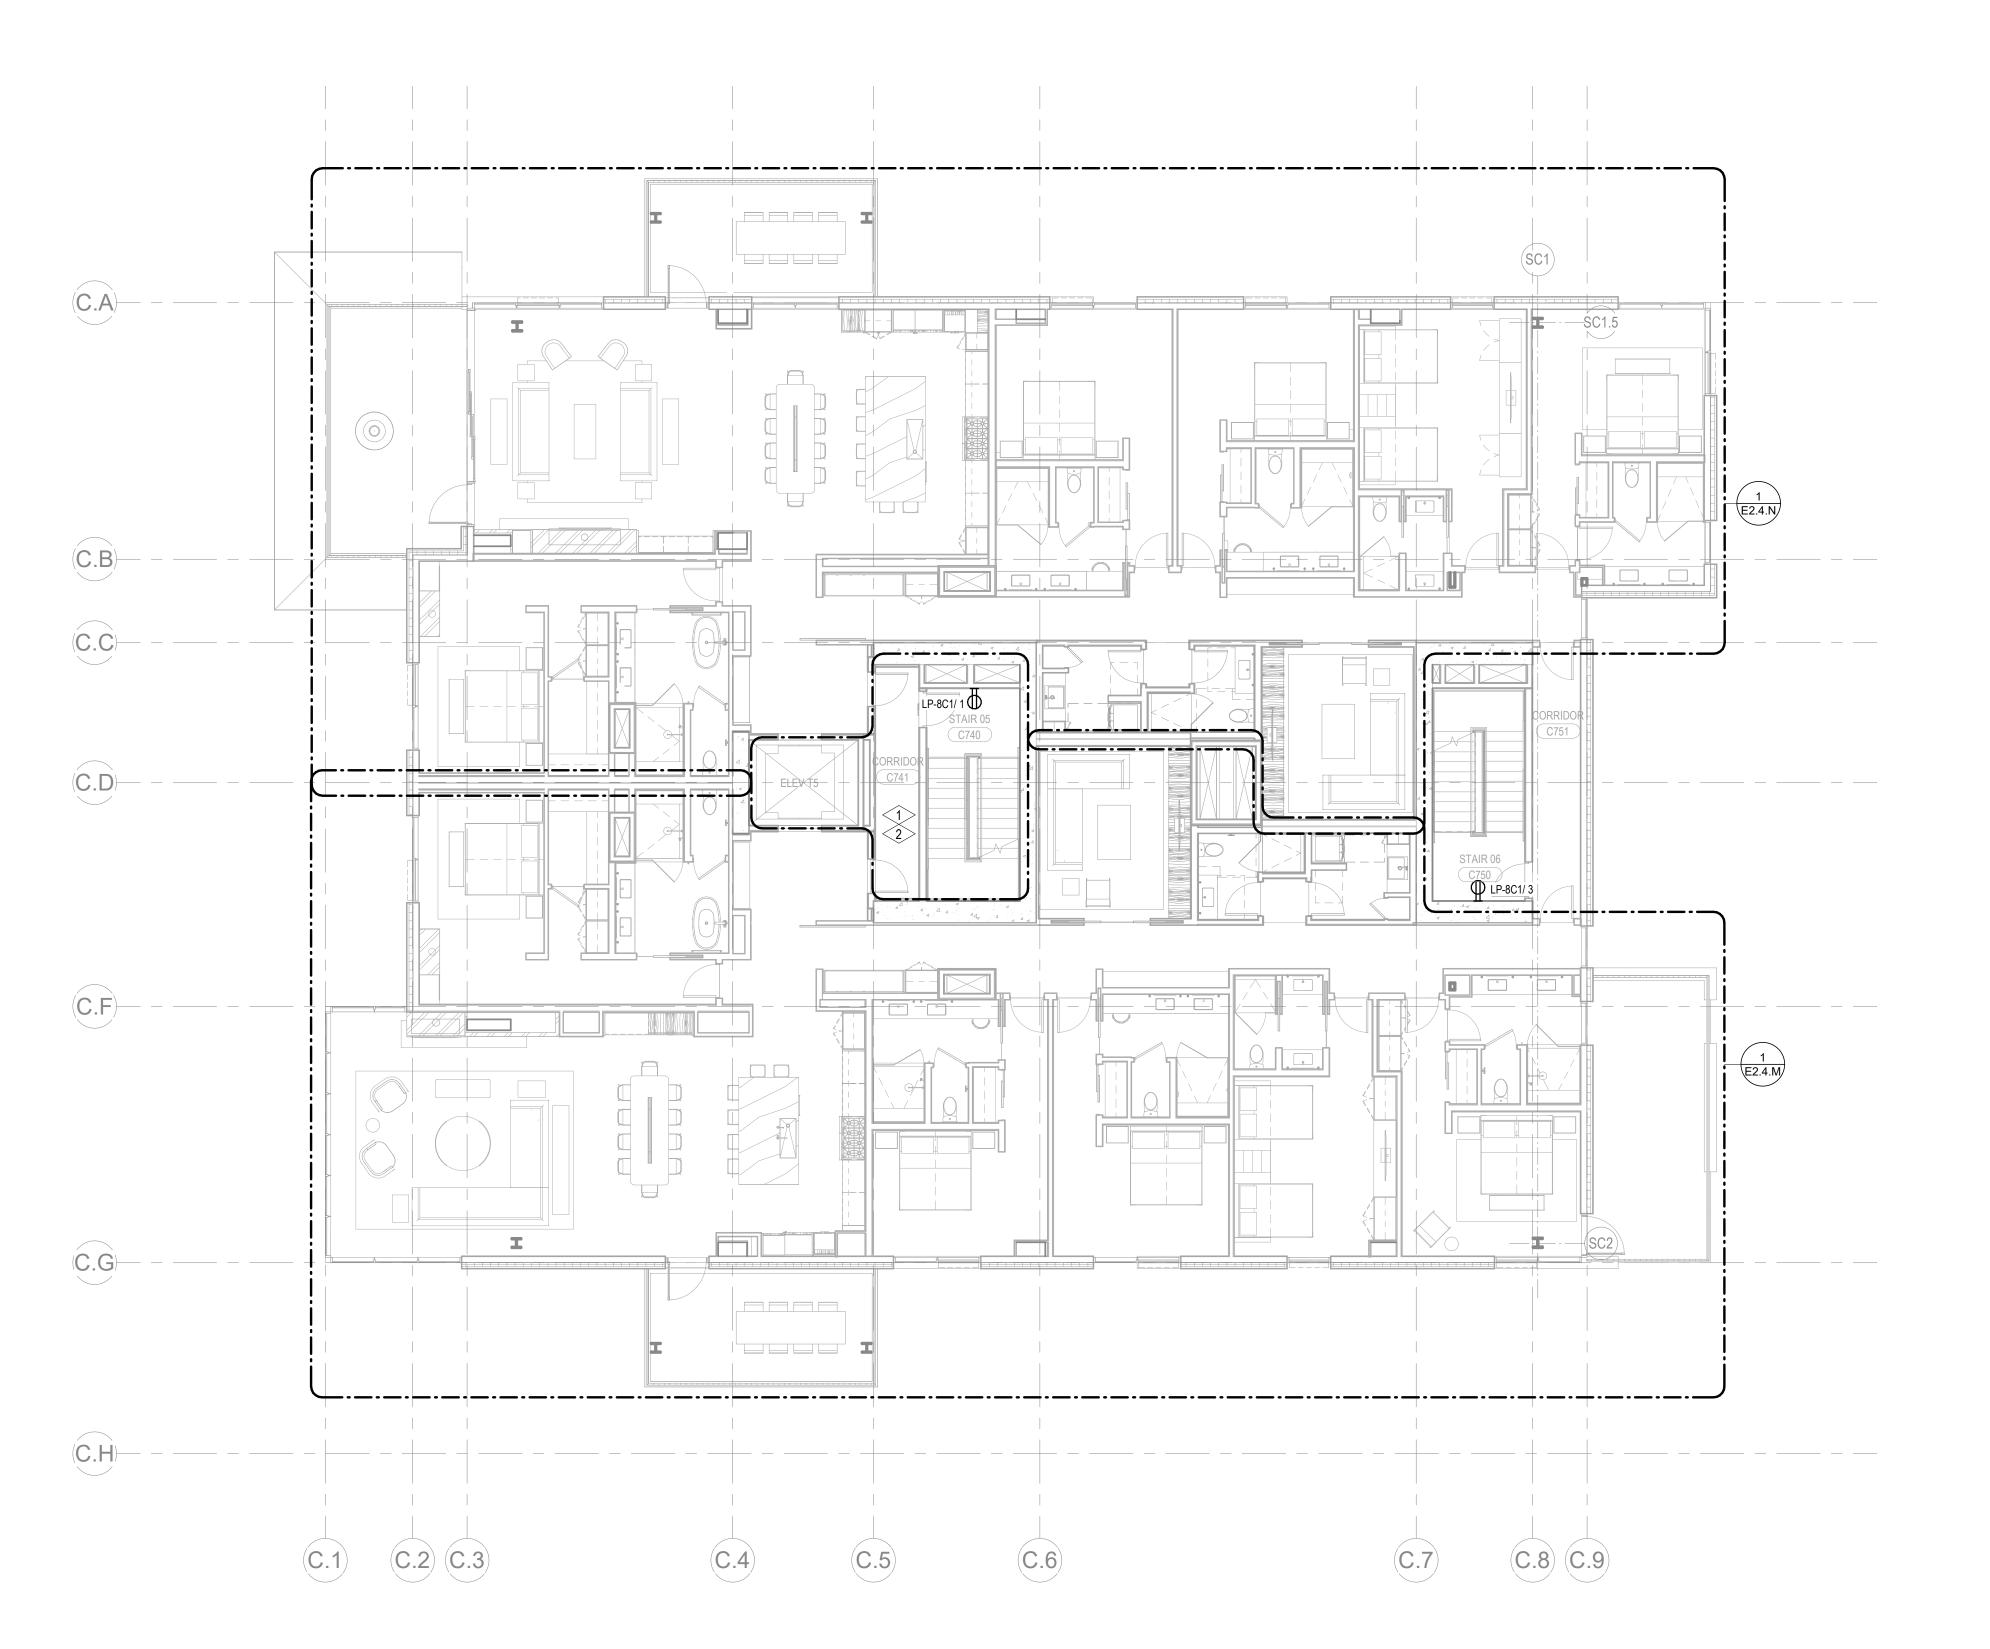

1 TOWER C - LEVEL 7 ELECTRICAL POWER PLAN

SCALE: 1/8" = 1'-0"



SHEET NOTES:

A. DRAWINGS ARE INTENDED TO SHOW GENERAL ARRANGEMENT, DESIGN, AND EXTENT OF WORK AND ARE DIAGRAMMATIC. DRAWINGS ARE NOT INTENDED TO SHOW EXACT LOCATIONS EXCEPT WHERE DIMENSIONS ARE SHOWN. ELECTRICAL WORK IS SHOWN ON PLANS USING STANDARD INDUSTRY SYMBOLS. BEFORE ORDERING MATERIALS OR DOING WORK, VERIFY MEASUREMENTS PERTAINING THERETO AND ASSUME RESPONSIBILITY THEREFOR. ANY SUBSTANTIAL DIFFERENCES BETWEEN DRAWINGS AND CONDITIONS IN THE FIELD SHALL BE SUBMITTED TO THE CONSTRUCTION MANAGER FOR CONSIDERATION BEFORE PROCEEDING WITH WORK.

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C. REFER TO ELECTRICAL CONNECTION SCHEDULE FOR CONDUIT, WIRING, COPD, DISCONNECT REQUIREMENTS.

D. VERIFY EQUIPMENT SIZES AND POWER REQUIREMENTS FOR EQUIPMENT PROVIDED BY

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F. REFER TO MECHANICAL AND PLUMBING PLANS FOR EXACT LOCATION OF HVAC/PLUMBING EQUIPMENT.

G. PROVIDE CONDUIT, WIRE AND J-BOXES FOR CIRCUITING SHOWN. QUANTITY AND SIZES OF J-BOXES TO BE DETERMINED BY CONTRACTOR.

J-BOXES TO BE DETERMINED BY CONTRACTOR. H. CONTRACTOR SHALL BE RESPONSIBLE FOR REPAIR OF ANY ELECTRICAL CIRCUITS AFFECTED BY CONSTRUCTION. SUCH CIRCUITS WILL BE REPAIRED IMMEDIATELY. THERE WILL BE NO DISRUPTION OF SERVICE OUTSIDE OF CONSTRUCTION ZONE/ AREA. J. PROVIDE TAMPER PROOF RECEPTACLES IN RESIDENTIAL UNITS AND ALL COMMON AREAS AS PER NEC 406.12.

NUMBERED NOTES:

BRANCH CIRCUITS IN EACH DWELLING UNIT SHALL SUPPLY ONLY LOADS WITHIN THAT DWELLING UNIT OR LOADS ASSOCATED ONLY WITH THAT DWELLING UNIT.
 FEEDERS TO A DWELLING UNIT SHALL NOT ENTER AND BE ROUTED THOUGH ANOTHER DWELLING UNIT.

OISON KUNC 9300 Marsac Ave (B2 East Parcel)

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Building Envelope Consultant RDH 2101 N 34th St Seattle, WA 98103
Accessibility Consultant Studio Pacifica 2144 Westlake Ave N, Suite F Seattle, WA 98109

principal architect ______
project manager ______
drawn by _____


checked by __Checker ____
job no.
date __11/18/2022

revisions: _______

no. date __by

MEP Engineer
WSP USA
1001 Fourth Ave., Suite 3100
Seattle, WA 98154

ISSUE FOR CONSTRUCTION 11/18/2022

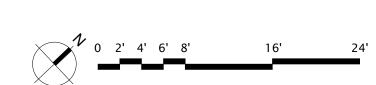


TOWER C - LVL 7
ELECTRICAL POWER
PLAN

E2.2C.17

1 TOWER C - LEVEL 8 ELECTRICAL POWER PLAN

SCALE: 1/8" = 1'-0"

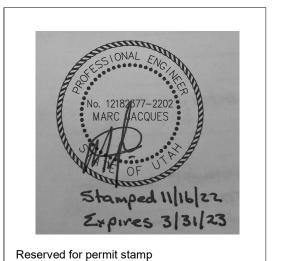

SHEET NOTES:

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WILL BE NO DISRUPTION OF SERVICE OUTSIDE OF CONSTRUCTION ZONE/ AREA.

I. PROVIDE TAMPER PROOF RECEPTACLES IN RESIDENTIAL UNITS AND ALL COMMON AREAS

NUMBERED NOTES:


AS PER NEC 406.12.

DUPLEX RECEPTACLE TO BE INSTALLED AT THE TOP OF THE ELEVATOR SHAFT. COORDINATE EXACT LOCATION WITH ELEVATOR CONTRACTOR.
 HEAT TRACE IS TO BE SUPPLIED AND INSTALLED FOR ALL HYDRONIC PIPING IN THE AREA NOTED. REFER TO MECHANICAL DRAWINGS FOR QUANTITY AND EXACT LOCATION OF HYDRONIC PIPING. HEAT TRACE CIRCUITS SHALL BE FED FROM A GFEP-TYPE BREAKER.

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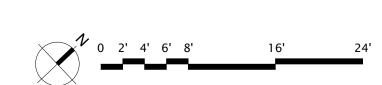
MEP Engineer
WSP USA

1001 Fourth Ave., Suite 3100 Seattle, WA 98154

principal architect ______
project manager ______
drawn by _____
checked by __Checker _____
job no.
date ______11/18/2022
revisions:

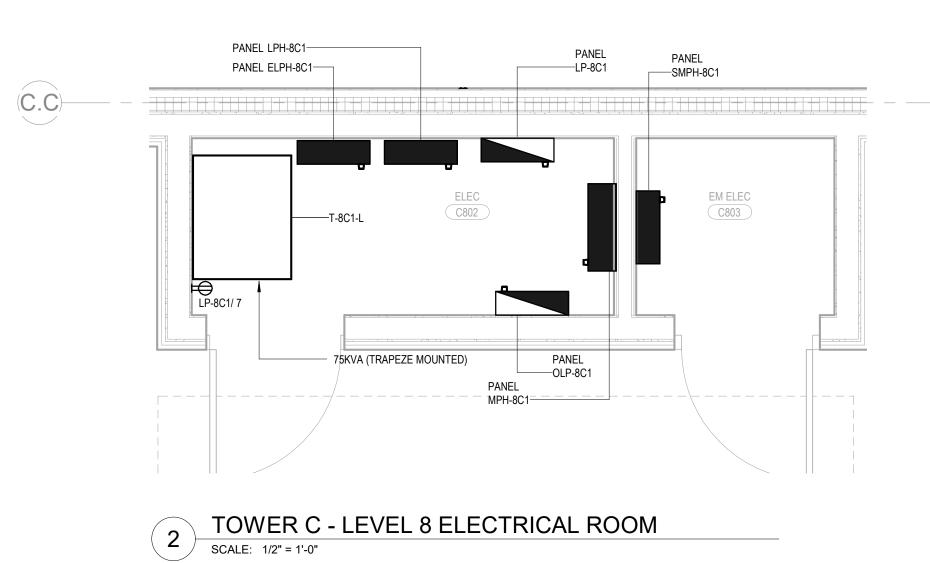
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ISSUE FOR CONSTRUCTION 11/18/2022



TOWER C - LVL 8
ELECTRICAL POWER
PLAN

E2.2C.18

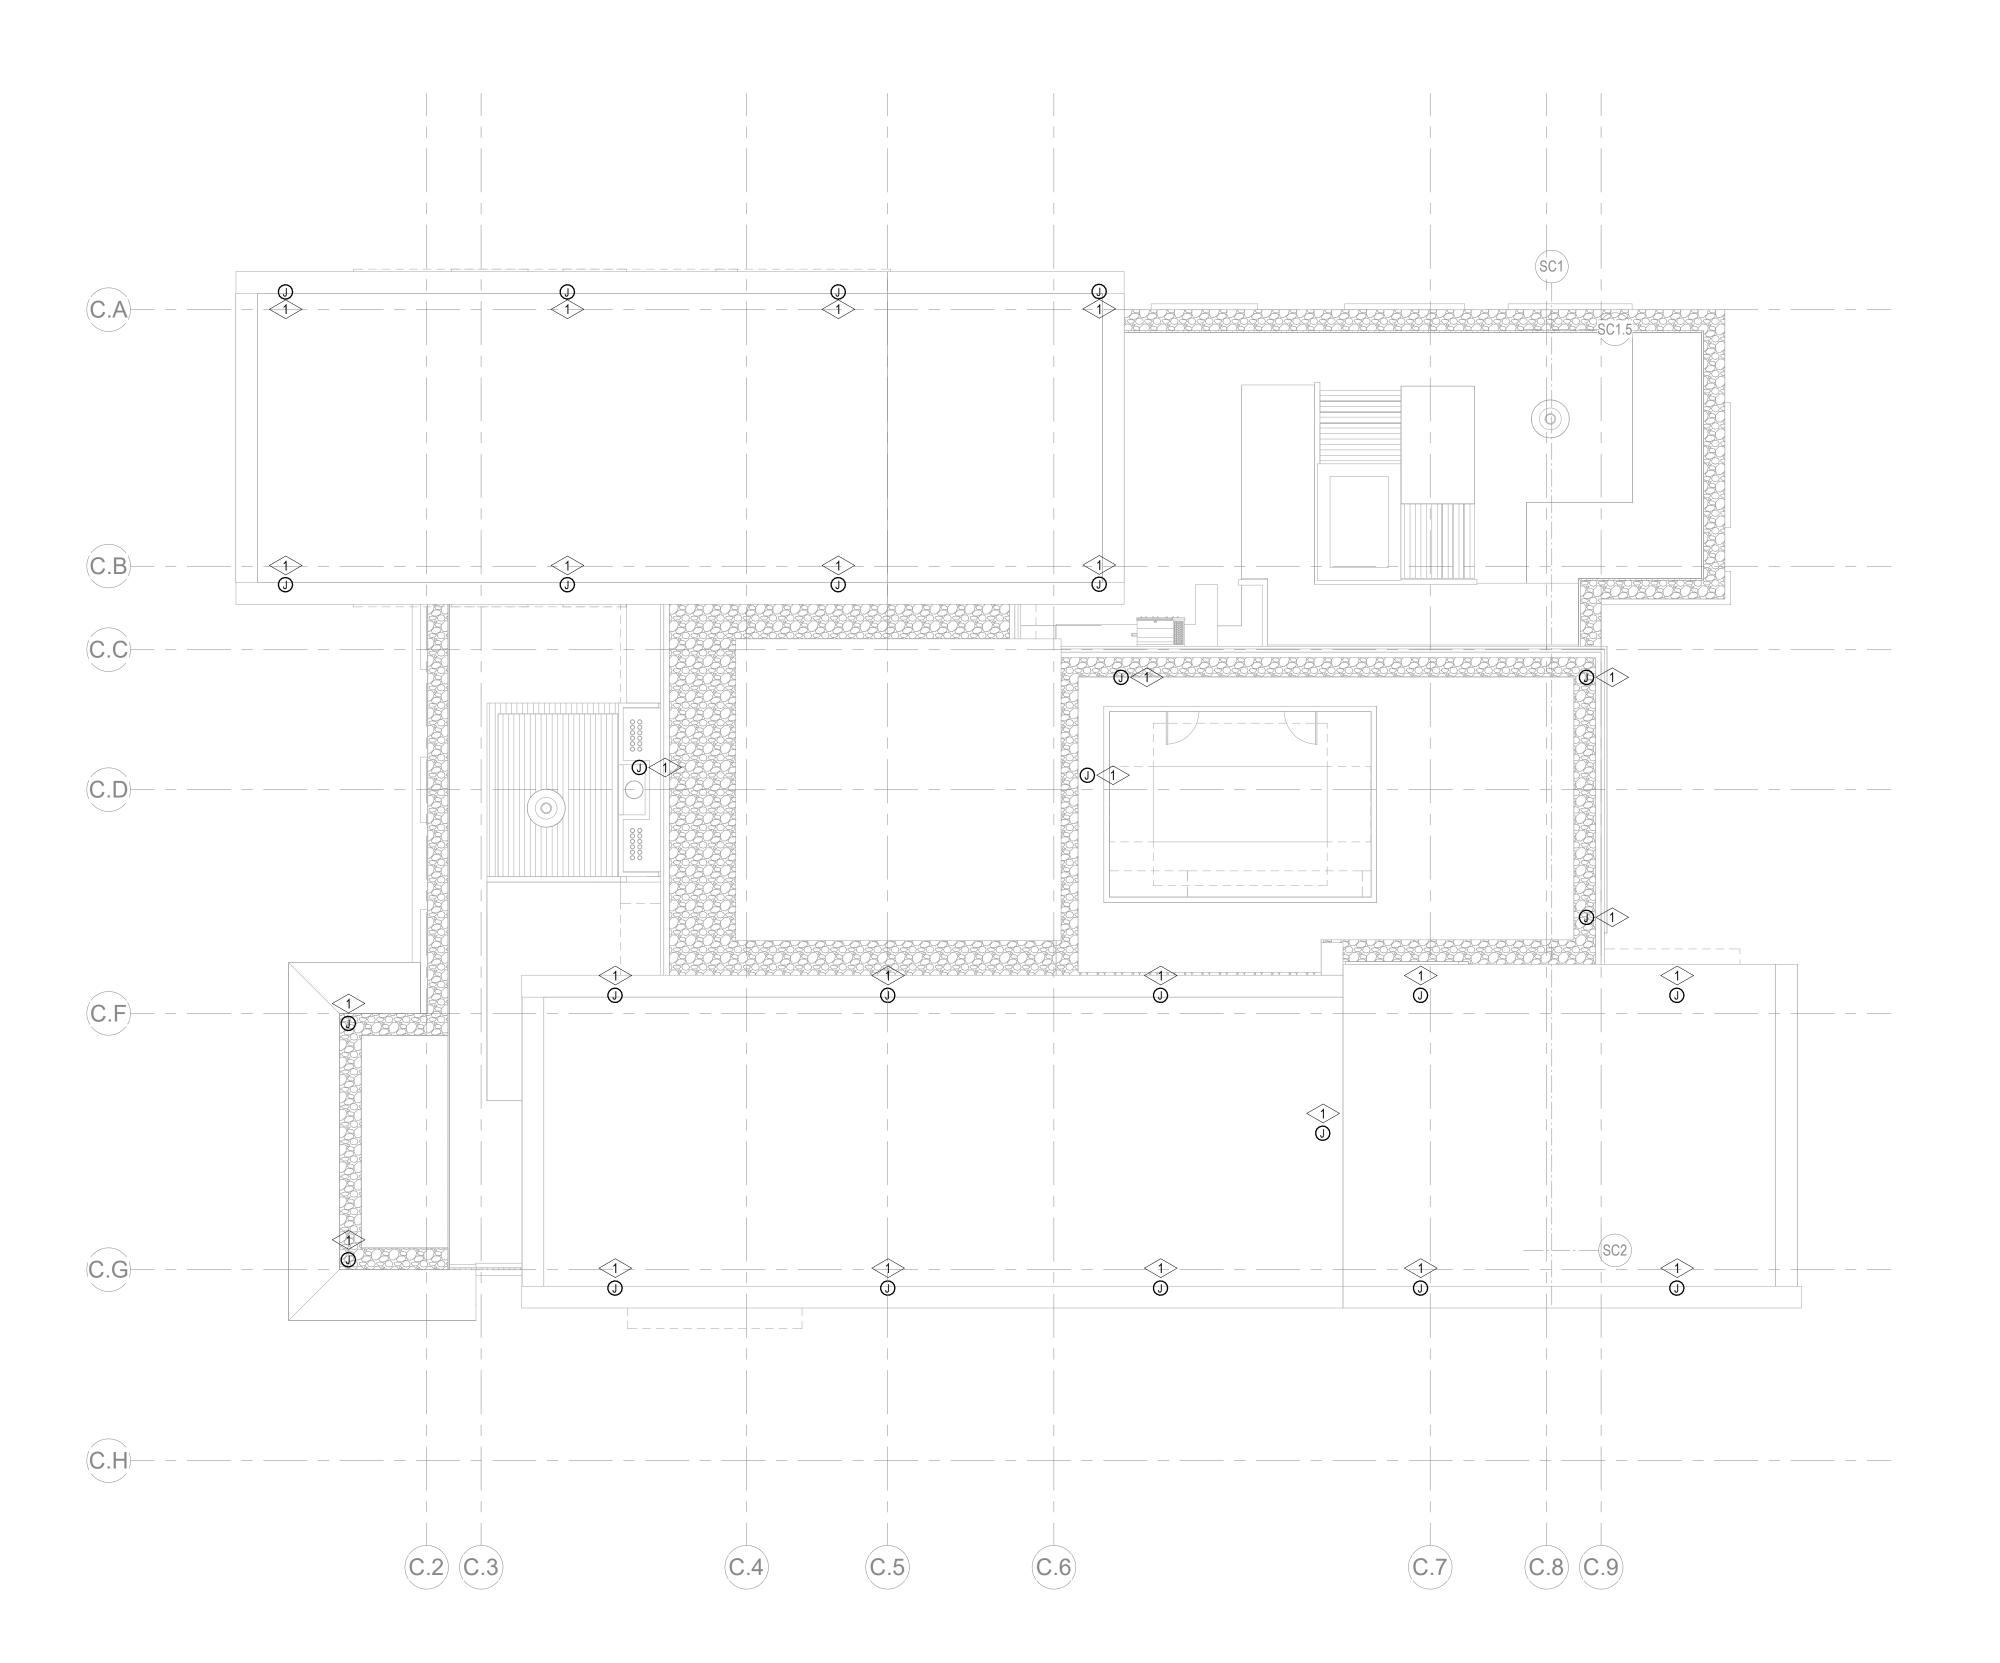

1 TOWER C - ROOF ELECTRICAL POWER PLAN

SCALE: 1/8" = 1'-0"



SHEET NOTES:

ROUGH-IN.

AS PER NEC 406.12.

A. DRAWINGS ARE INTENDED TO SHOW GENERAL ARRANGEMENT, DESIGN, AND EXTENT OF WORK AND ARE DIAGRAMMATIC. DRAWINGS ARE NOT INTENDED TO SHOW EXACT LOCATIONS EXCEPT WHERE DIMENSIONS ARE SHOWN. ELECTRICAL WORK IS SHOWN ON PLANS USING STANDARD INDUSTRY SYMBOLS. BEFORE ORDERING MATERIALS OR DOING WORK, VERIFY MEASUREMENTS PERTAINING THERETO AND ASSUME RESPONSIBILITY THEREFOR. ANY SUBSTANTIAL DIFFERENCES BETWEEN DRAWINGS AND CONDITIONS IN THE FIELD SHALL BE SUBMITTED TO THE CONSTRUCTION MANAGER FOR CONSIDERATION BEFORE PROCEEDING WITH WORK. B. WORK PERFORMED INCLUDES LABOR, MATERIALS, AND EQUIPMENT REQUIRED TO INSTALL A COMPLETE ELECTRICAL SYSTEM AS INDICATED ON THESE DRAWINGS AND AS SPECIFIED. C. REFER TO ELECTRICAL CONNECTION SCHEDULE FOR CONDUIT, WIRING, COPD,

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NUMBERED NOTES:

1 PLACEHOLDER FOR SNOWMELT HEAT TAPE AT EAVES AND GUTTERS. PROVIDE GFEP 30mA-TRIP CIRCUIT PROTECTION PER NEC.



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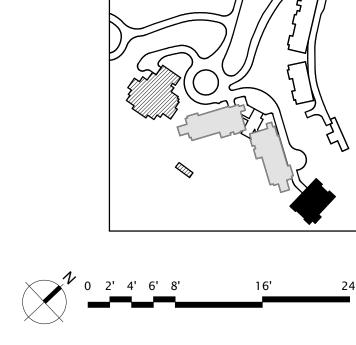
1001 Fourth Ave., Suite 3100 Seattle, WA 98154

MEP Engineer
WSP USA

principal architect _____ project manager_____ checked by <u>Checker</u> date 11/18/2022 no. date

ISSUE FOR CONSTRUCTION 11/18/2022

TOWER C - ROOF ELECTRICAL POWER PLAN E2.2C.R



BEFORE PROCEEDING WITH WORK.


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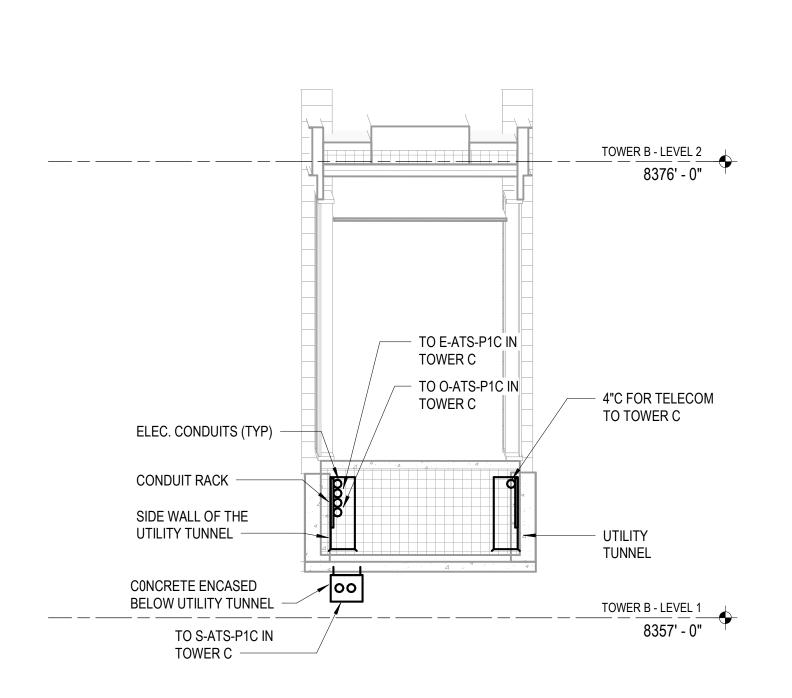


1 TOWER BC - LVL 1 CONNECTOR ELECTRICAL POWER PLAN


SCALE: 1/4" = 1'-0"



NUMBERED NOTES:

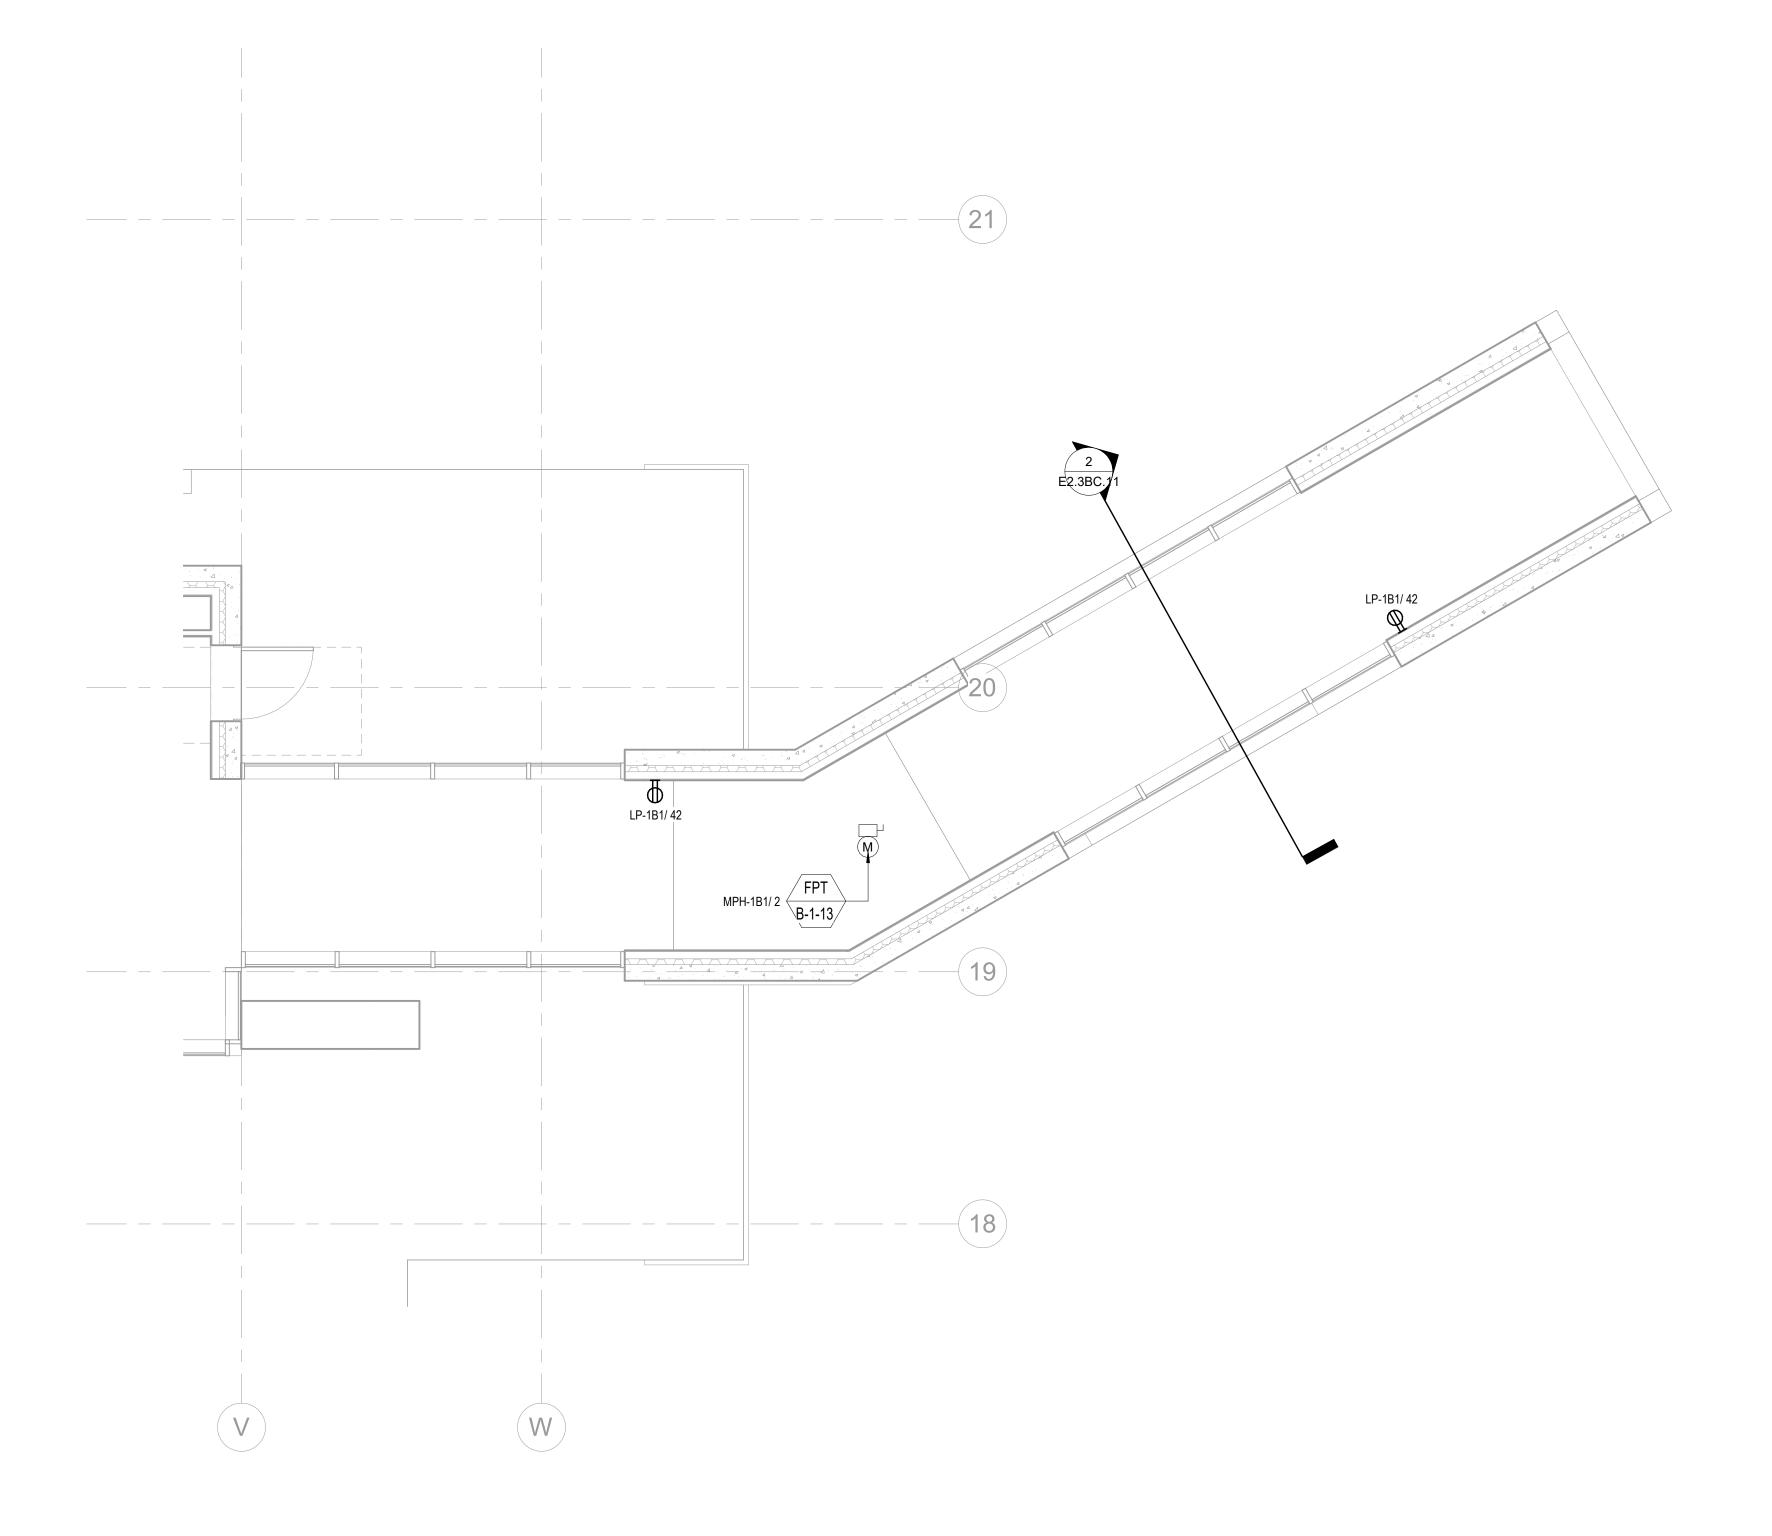

2 TOWER BC - CONNECTOR ELECTRICAL POWER SECTION
SCALE: 1/4" = 1'-0"

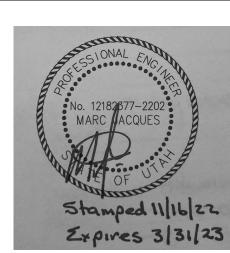

Reserved for permit stamp

450 Courts Lockoon C4 Courts 200

159 South Jackson St, S Seattle, Washington 981

on Kundig

SOMMET BLANC 9300 Marsac Ave (B2 East Pa

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principal architect	
project manager	
·	
checked by	Checker
job no.	
date	11/18/2022
revisions:	

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TOWER BC CONNECTOR
- LVL 1 ELECTRICAL
POWER PLAN

E2.3BC.11