


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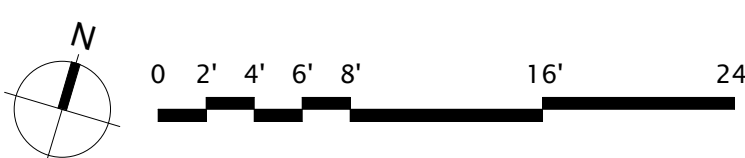
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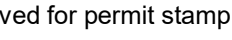
MECHANICAL PLANS  
POWER AB LOBBY

M2.2AB.11


**NUMBERED NOTES:**

- 1 PROVIDE CONTINUOUS PLENUM ON UNDERSIDE OF FLOOR GRILL WITHIN INTERSTITIAL SPACE FOR CONNECTION TO DUCT FROM BELOW. PROVIDE REMOTE DAMPER ACTUATORS ACCESSIBLE FROM FLOOR GRILL
- 2 ARCHITECT SHALL PROVIDE RATED ENCLOSURE WITH DUCT INSTALLED TIGHT TO UNDERSIDE OF SLAB TO PREVENT THE NEED FOR FSDS

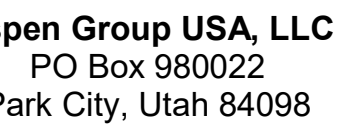



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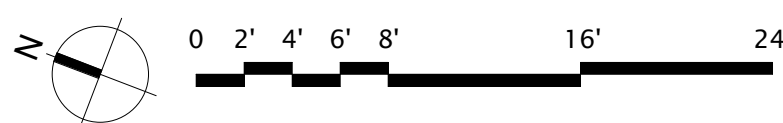
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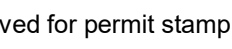
POWER B - LVL B  
MECHANICAL DUCT  
AN

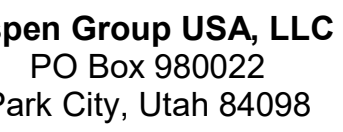M2.2B.01

**NUMBERED NOTES:**

- 1 PROVIDE 44X10 TRANSFER DUCT INTO MECH ROOM  
2 GRILL AND DUCTWORK BACK TO BRANCH LINE SHALL BE  
3 STAINLESS STEEL CONSTRUCTION  
4 3" FREE AIR GAP ALONG THIS WALL FOR RETURN AIR. SEE  
5 ARCH DRAWINGS  
6 WALL GRILL SHALL BE ABOVE FINISHED CEILING. FSD  
7 ACCESS IN ELECTRICAL ROOM  
8 REMAINING 3" GAP NOT OCCUPIED BY LINEAR DIFFUSER IN  
9 THIS LINE SHALL BE BLANKED OFF TO RETURN AIR AT THIS  
10 LOCATION





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date b7



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POWER B - LVL P2  
MECHANICAL DUCT  
AN

M2.2B.02

**NUMBERED NOTES:**


- 1 ROUTE CONDENSATE TO NEAREST FLOOR DRAIN.
- 2 ARCHITECT TO PROVIDE 30-SQFT GRILL IN SHAFT WALL  
FOR GARAGE EXHAUST INTAKE.
- 3 GENSET EXHAUST SILENCER, FURNISHED BY OTHERS,  
INSTALLED BY MECHANICAL CONTRACTOR.
- 4 ARCHITECT TO PROVIDE 58-SQFT NFA GARAGE AND SPI  
AIR INTAKE.

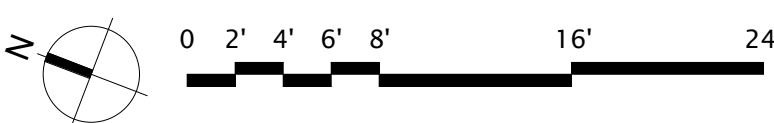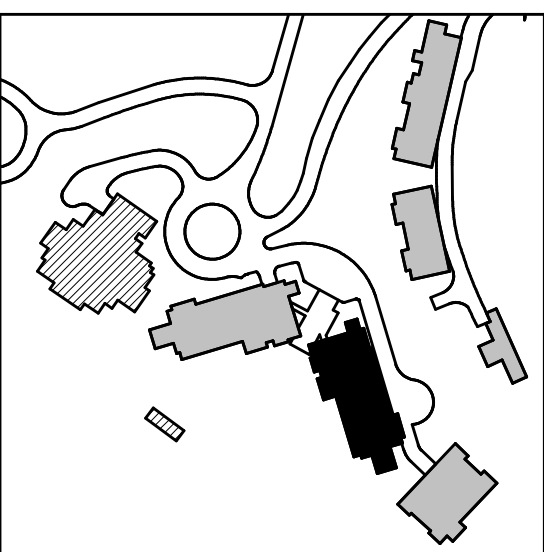

1 TOWER B - PARKING LEVEL 2 MECHANICAL DUCT PLAN  
SCALE: 1/8" = 1'-0"


SCALE: 1/8" = 1'-0"



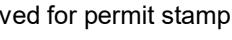

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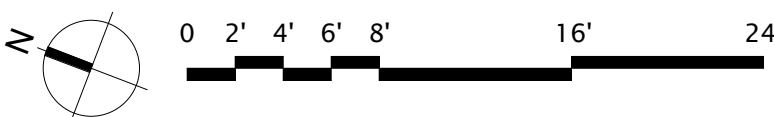
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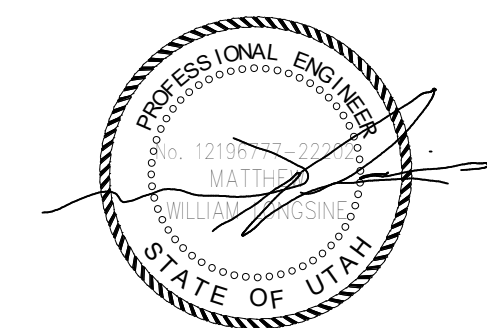
POWER B - LVL P1  
MECHANICAL DUCT  
AN

M2.2B.03

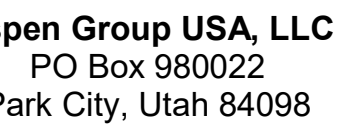**NUMBERED NOTES:**

- 1 SEE ARCHITECTURAL DRAWINGS FOR INTAKE WELL  
INFORMATION.
- 2 SEE ARCHITECTURAL DRAWINGS FOR EXHAUST WELL  
INFORMATION.
- 3 ARCHITECT TO PROVIDE 38-SQFT NFA GARAGE AND SPF  
INTAKE.
- 4 ROUTE CONDENSATE TO NEAREST FLOOR DRAIN.
- 5 GENERATOR REMOTE RADIATOR, PROVIDE BACKDRIFT  
DAMPERS ON THE EXHAUST AIR DUCT.
- 6 EQUIPMENT SHALL BE MOUNTED ON MECHANICAL  
PLATFORM ABOVE GARAGE DUCT ISLE.
- 7 START PRESSURIZATION FANS AND ASSOCIATED  
DUCTWORK TO BE LOCATED IN A 2-HR RATED ENCLOSURE  
ADJACENT TO FAN. SEE ARCHITECTURAL DRAWINGS FOR  
EQUIPMENT DETAIL.
- 8 REFER TO MF-04 FOR BLDG B HYDRONIC RISC DIAGRAM  
AND MECHANICAL ROOM PIPE CONFIGURATION.
- 9 1-CFM / SQFT PROVIDED FOR ELEVATOR LOBBY  
PRESSURIZATION.
- 10 PROVIDE ENERGY SMOX-S MODULATING DAMPER OFF  
BOILER EXHAUST STACK.





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checked by \_\_\_\_\_  
job no. \_\_\_\_\_  
date 11/18/2022

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TOWER B - LVL 1  
MECHANICAL DUCT  
PLAN


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#### SHEET NOTES:



- A. REFER TO M2.4 SERIES FOR ENLARGED PLANS.  
B. FIREPLACE FLUE ROUTING SHOWN FOR REFERENCE. REFER TO ENLARGED UNIT PLANS FOR ROUTING AND SIZING DETAIL.  
C. MECHANICAL EQUIPMENT SHOWN FOR REFERENCE. REFER TO ENLARGED UNIT PLANS FOR DETAIL.  
D. ARCHITECT SHALL PROVIDE 1-SQFT NFA OPENINGS IN ALL FULL HEIGHT, NON-RATED WALLS FOR RETURN AIR PATHS IF NO DUCT TRANSFER IS SHOWN.  
E. ALL EQUIPMENT, INSULATION, WIRING, AND INFRASTRUCTURE IN THE PLENUM SHALL BE PLENUM RATED.  
F. FLEX DUCT SHALL NOT BE INSTALLED ABOVE FINISHED HARD-LID CEILINGS.  
G. PROVIDE BUTTON TYPE TEMPERATURE SENSOR IN PUBLIC AREAS. SEE DETAIL-13, SHEET M5.04.  
H. PROVIDE REMOTE CABLE DAMPER OPERATOR IN DIFFUSERS ABOVE HARD-LID CEILINGS. SEE DETAIL-9, SHEET M5.04.

#### NUMBERED NOTES:

1. SEE ARCHITECTURAL DRAWINGS FOR INTAKE WELL INFORMATION.  
2. CONNECT TO TOP OF LOCKER PLENUM.  
3. SEE ARCHITECTURAL DRAWINGS FOR EXHAUST WELL INFORMATION.  
4. GENERATOR COMBUSTION SHALL EXHAUST 10' FROM PROPERTY LINES, 3' FROM EXTERIOR WALLS AND ROOFS, 10' ABOVE GRADE AND 10' FROM OPERABLE OPENINGS INTO THE BUILDING.  
5. 3" FREE AIR GAP ALONG THIS WALL FOR RETURN AIR. SEE ARCH DRAWINGS.

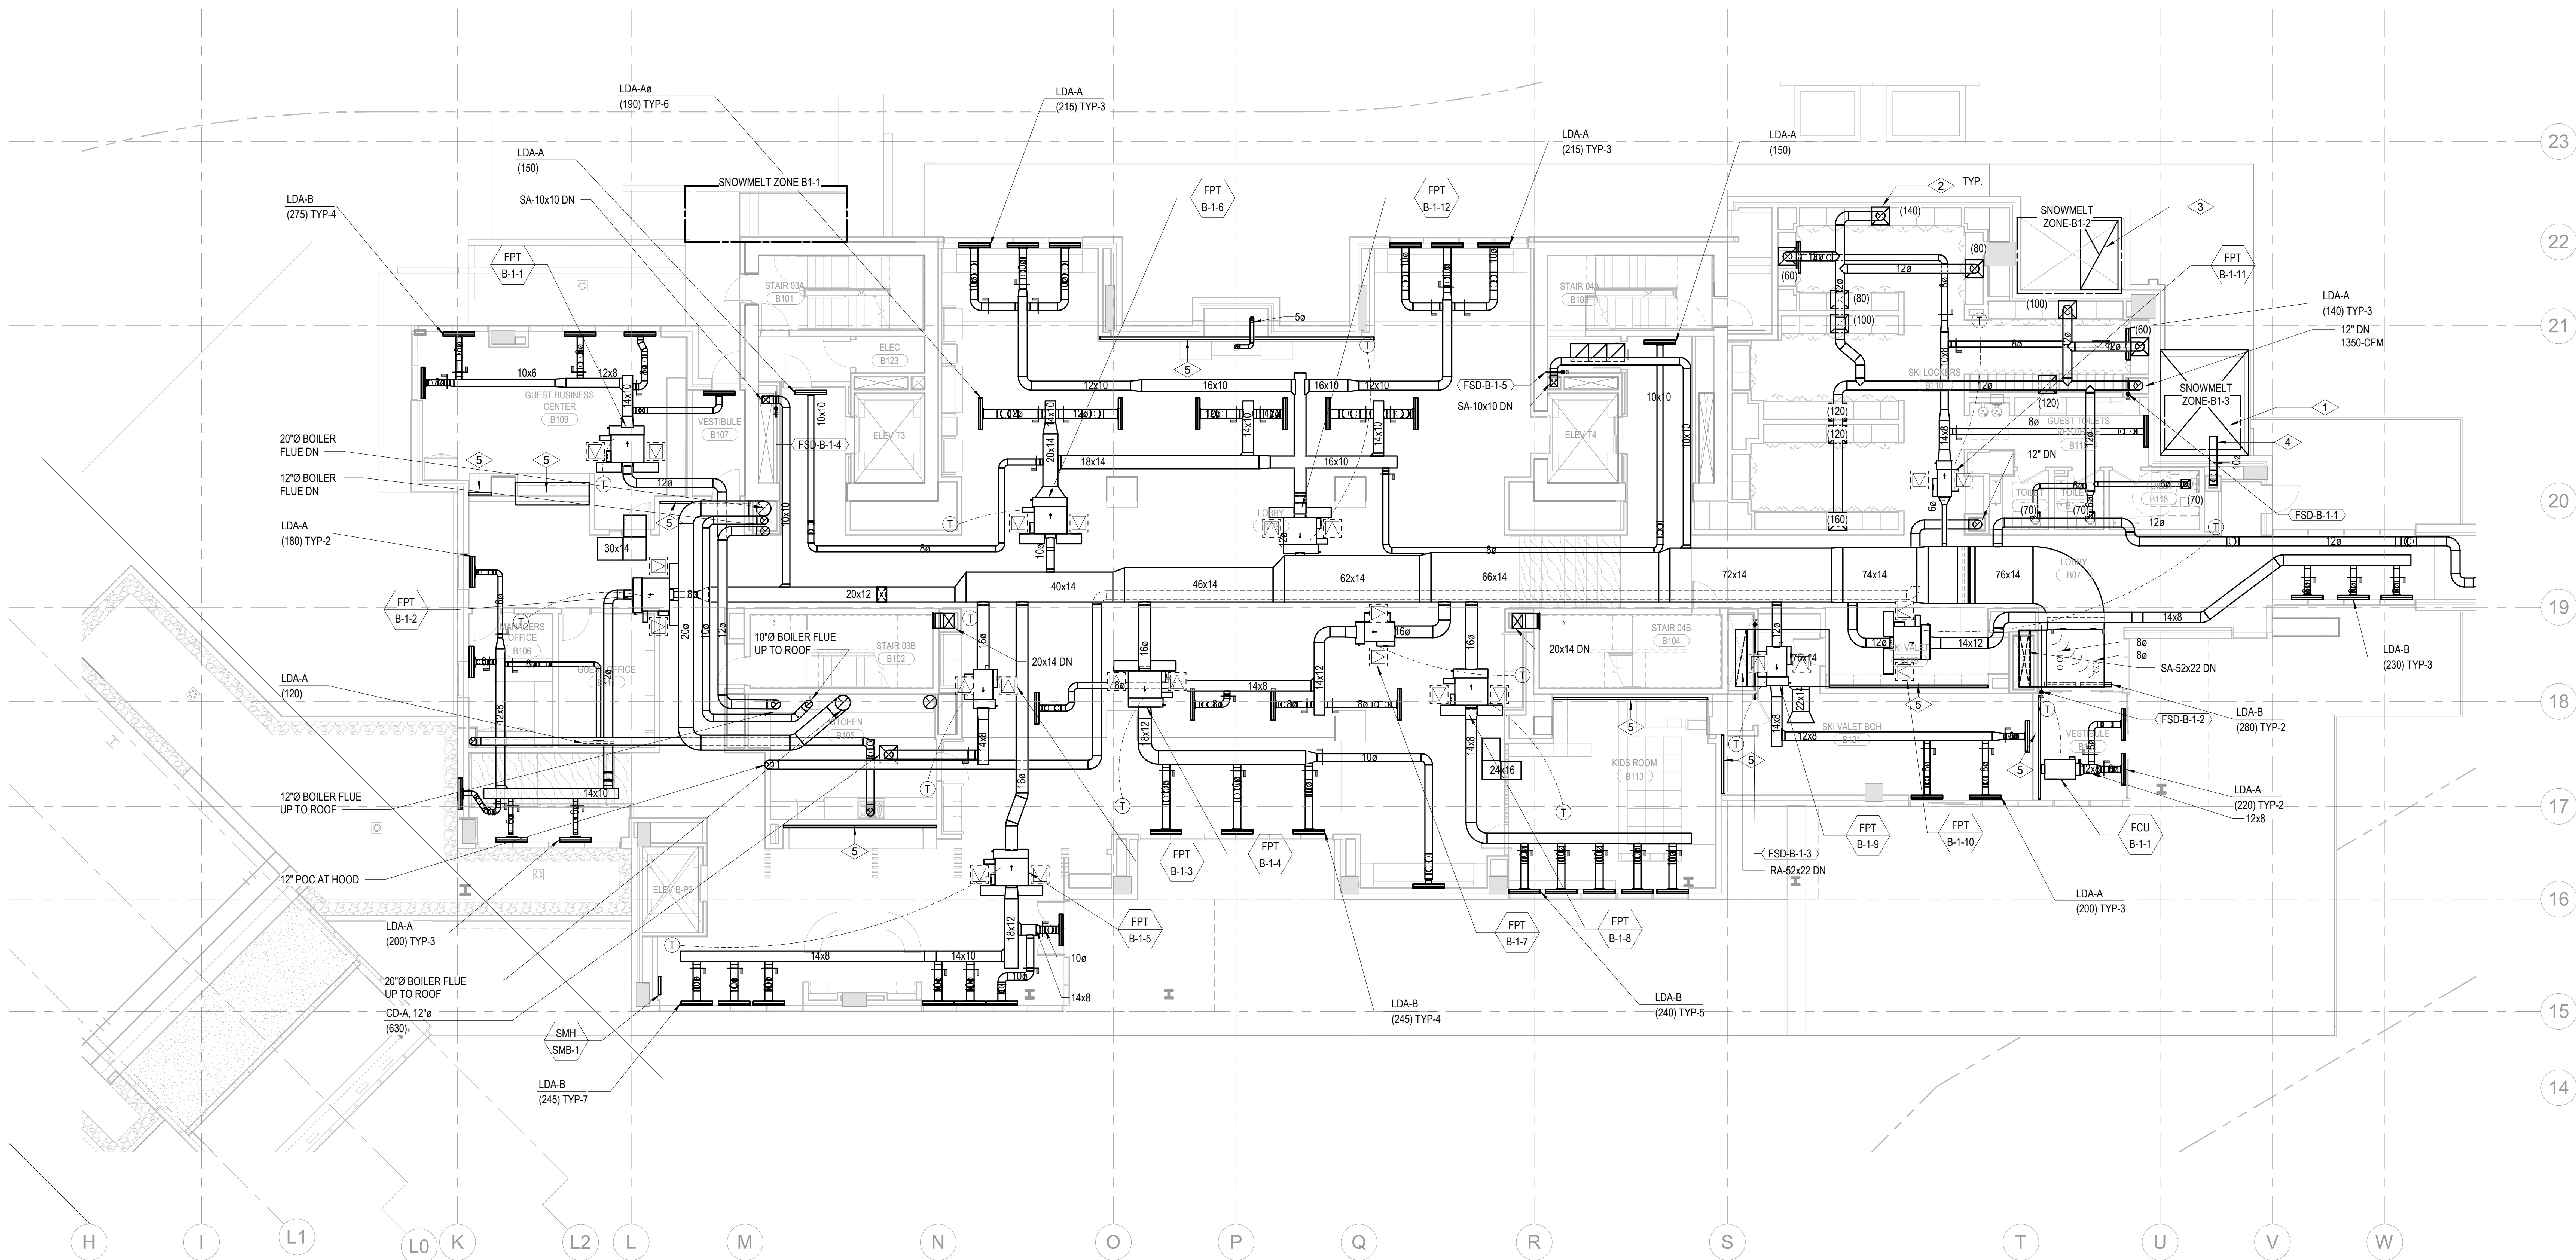

1 TOWER B - LEVEL 1 MECHANICAL DUCT PLAN  
SCALE: 1/8" = 1'-0"

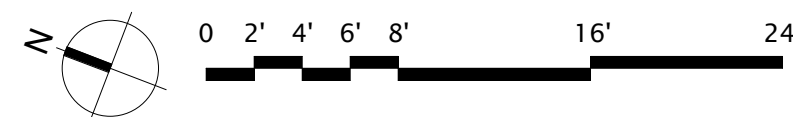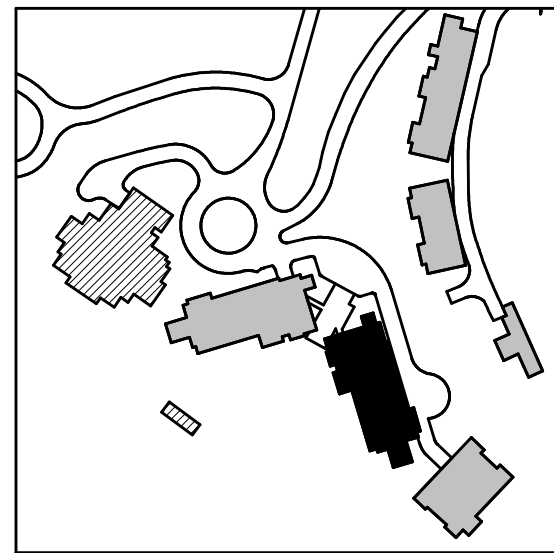




SHEET NOTES:

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C. MECHANICAL EQUIPMENT SHOWN FOR REFERENCE. REFER TO ENLARGED UNIT PLANS FOR DETAIL.  
D. ALL RESIDENTIAL TOILET EXHAUST, DRYER EXHAUST, AND KITCHEN RANGE HOOD EXHAUST TO BE PART OF A SUB-DUCT EXHAUST SYSTEM.

NUMBERED NOTES:

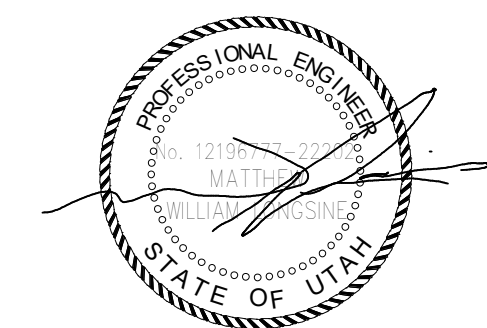

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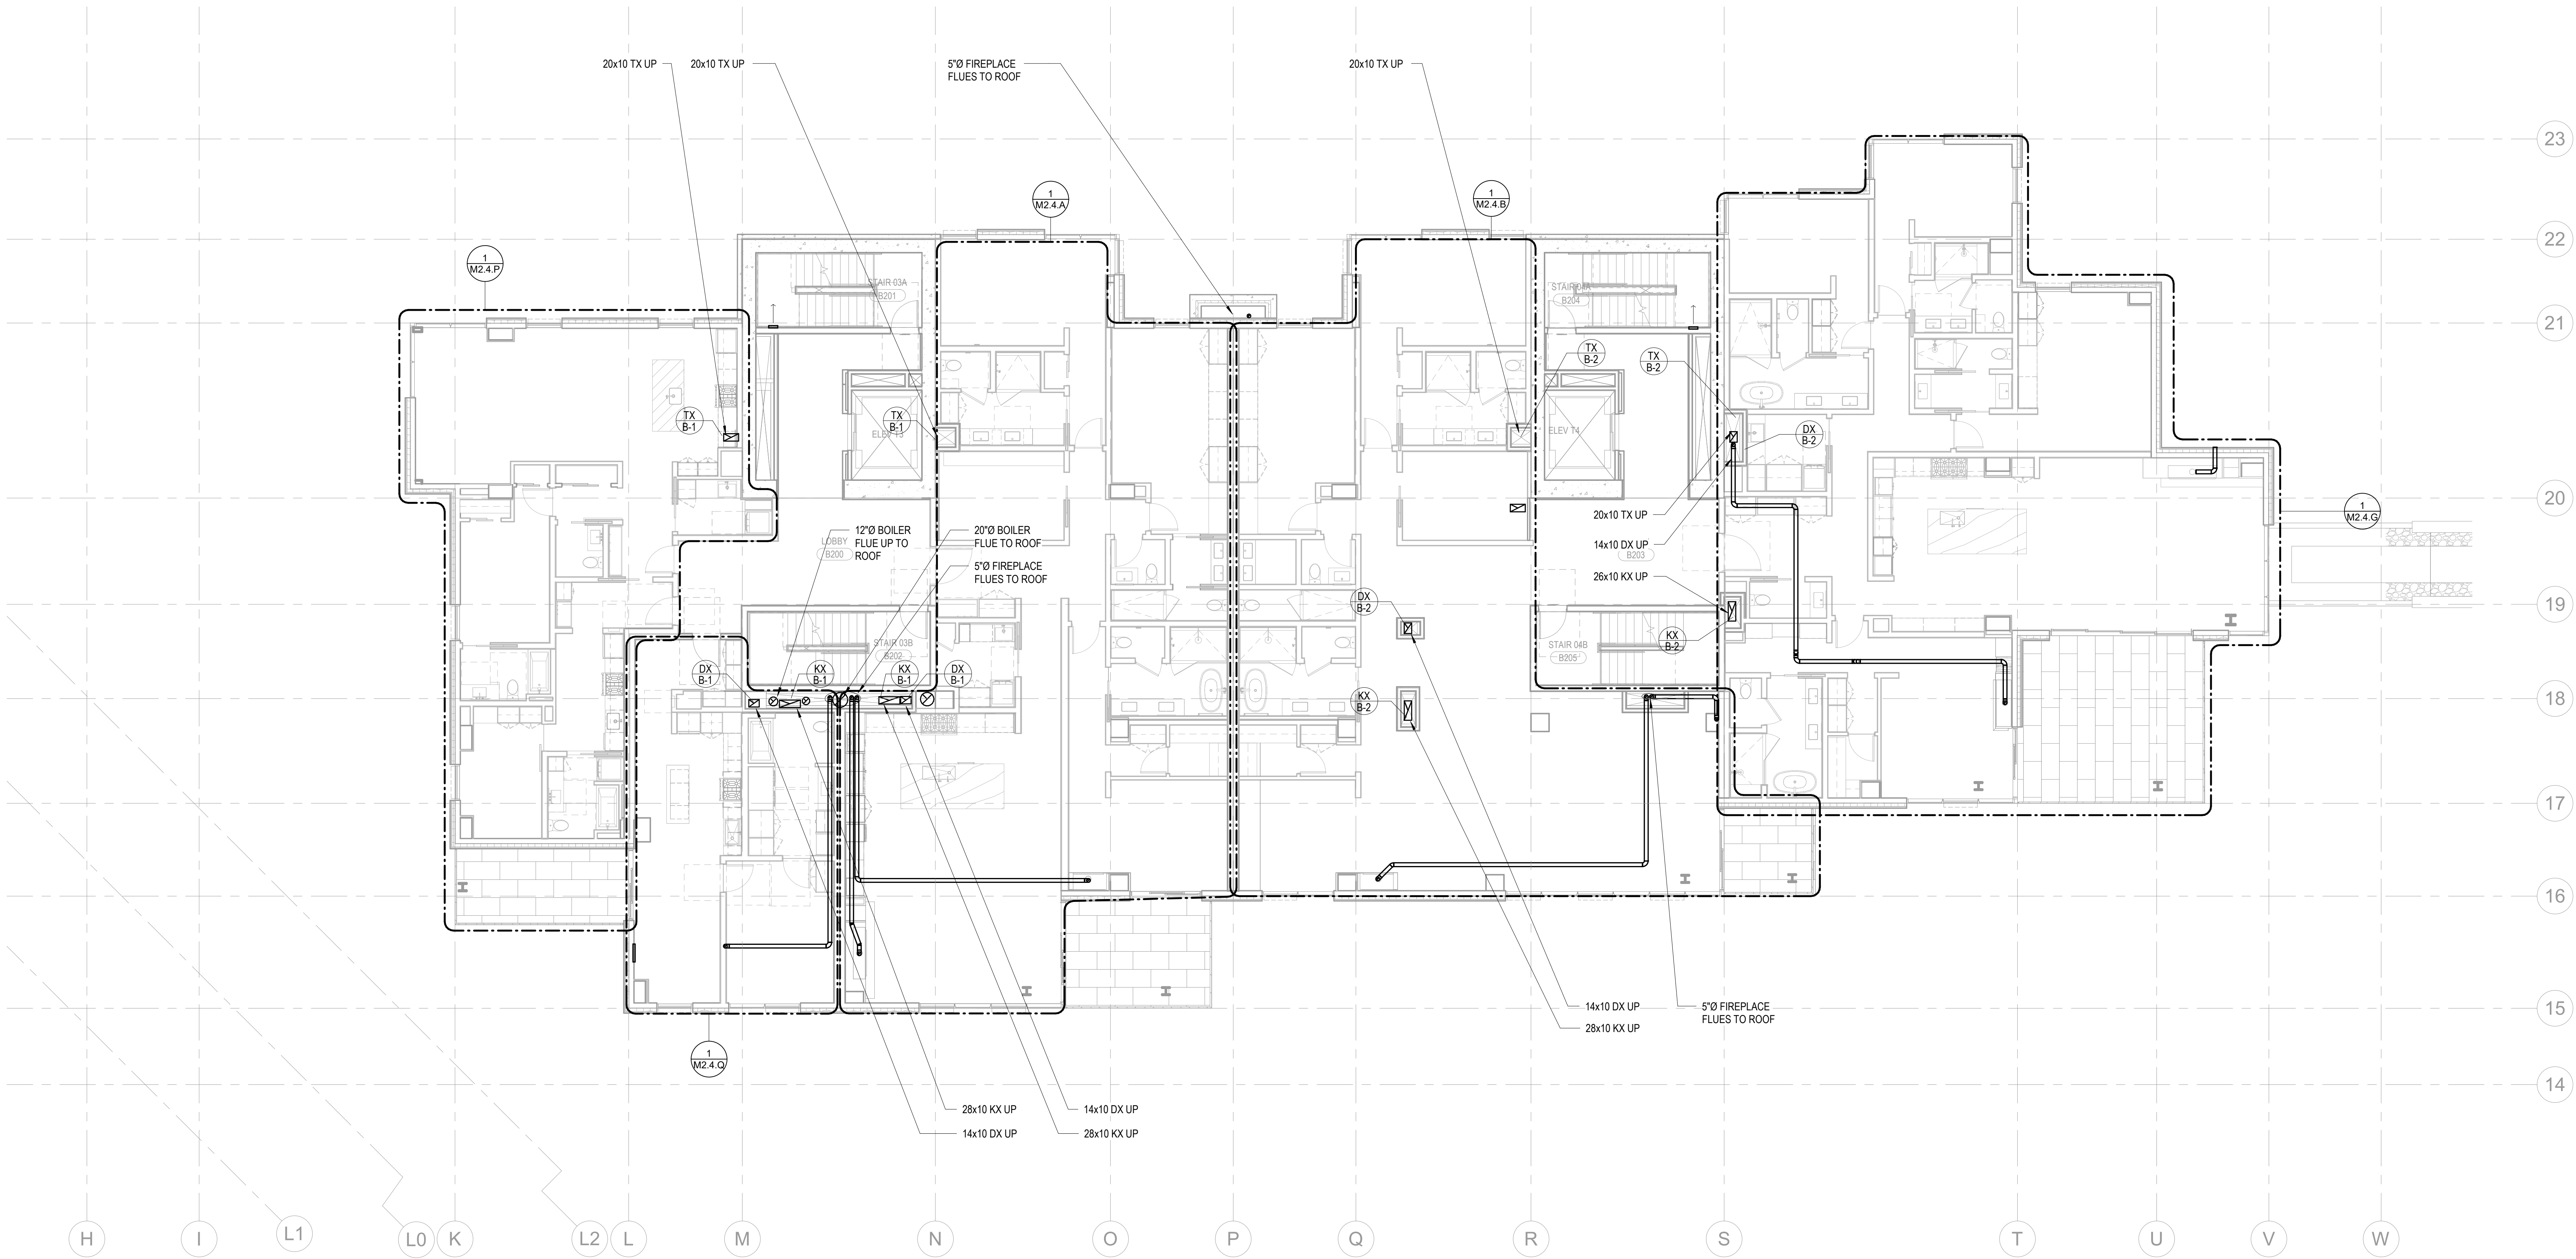
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project manager \_\_\_\_\_  
drawn by \_\_\_\_\_  
checked by \_\_\_\_\_  
job no. \_\_\_\_\_  
date 11/18/2022

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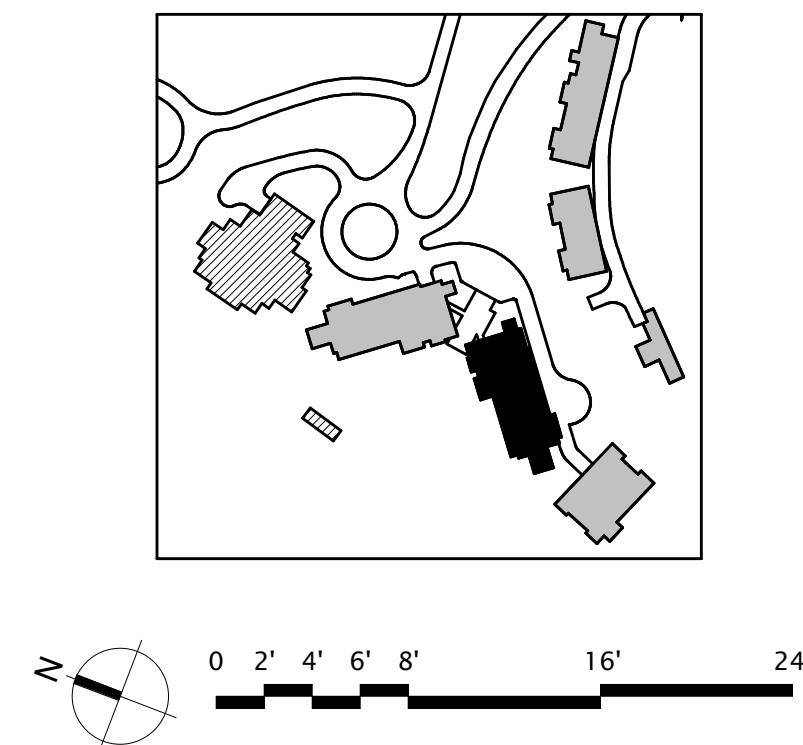
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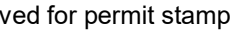
TOWER B - LVL 2  
MECHANICAL DUCT  
PLAN

M2.2B.12



1 TOWER B - LEVEL 2 MECHANICAL DUCT PLAN  
SCALE: 1/8" = 1'-0"






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POWER B - LVL 3  
MECHANICAL DUCT  
PLAN



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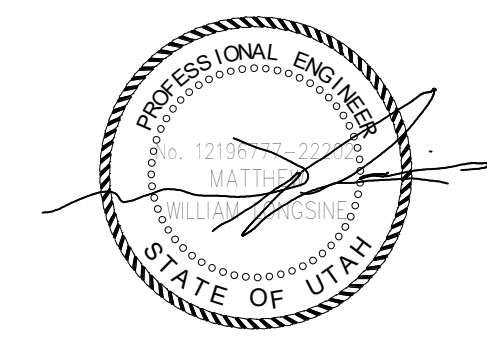
### SHEET NOTES

- A. REFER TO M2.4 SERIES FOR ENLARGED PLANS.  
B. FIREPLACE FLUE ROUTING SHOWN FOR REFERENCE. REFER TO ENLARGED UNIT PLANS FOR ROUTING AND SIZING DETAIL.  
C. MECHANICAL EQUIPMENT SHOWN FOR REFERENCE. REFER TO ENLARGED UNIT PLANS FOR DETAIL.  
D. ALL RESIDENTIAL TOILET EXHAUST, DRYER EXHAUST, AND KITCHEN RANGE HOOD EXHAUST TO BE PART OF A SUB-DUCT EXHAUST SYSTEM.

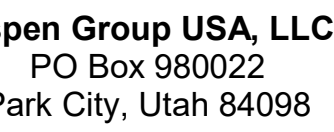

## NUMBERED NOTES



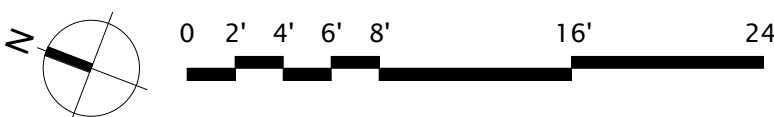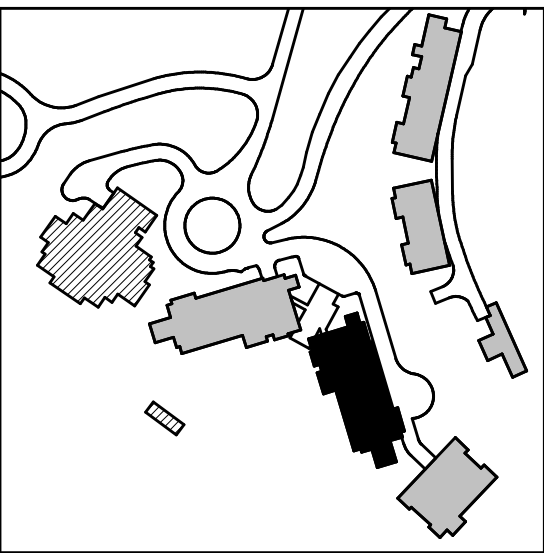

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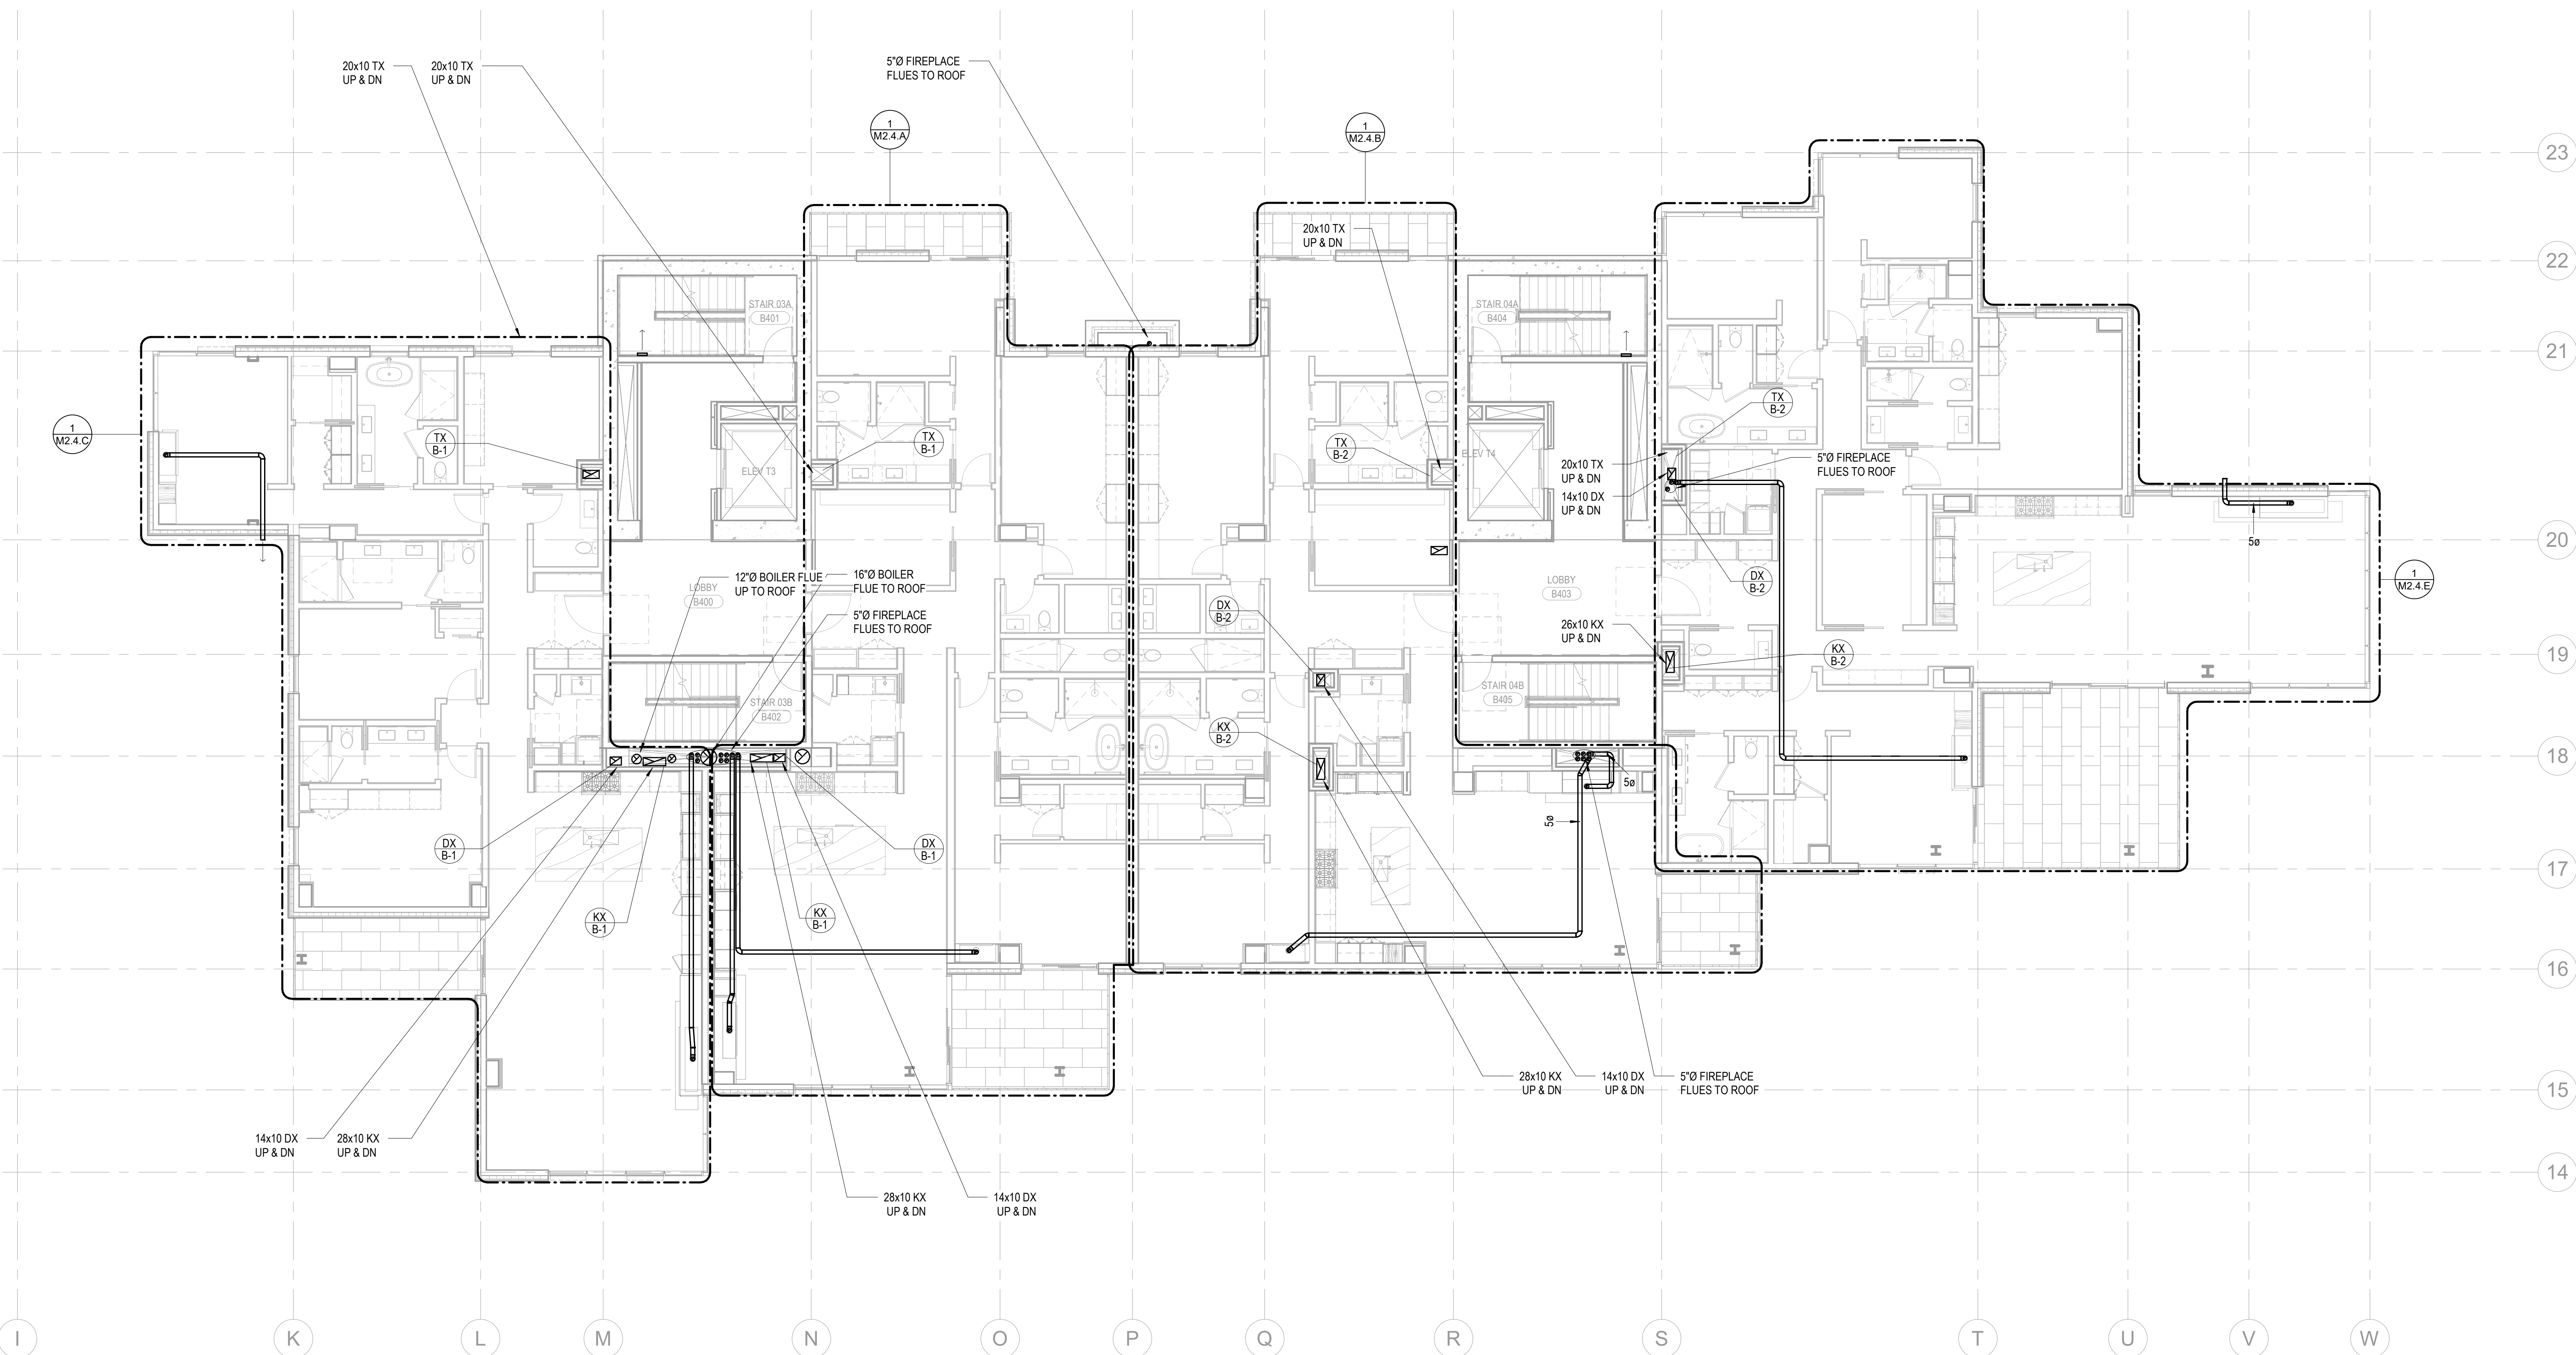
TOWER B - LVL 4  
MECHANICAL DUCT  
PLAN

M2.2B.14


#### SHEET NOTES:

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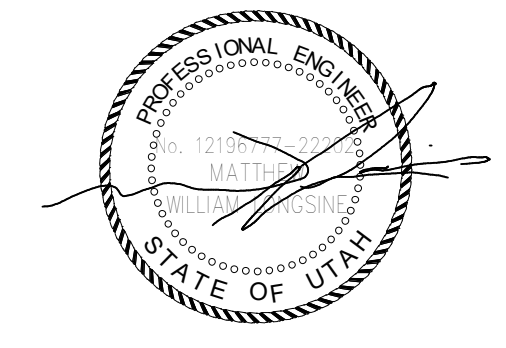
#### NUMBERED NOTES:



1 TOWER B - LEVEL 4 MECHANICAL DUCT PLAN  
SCALE: 1/8" = 1'-0"



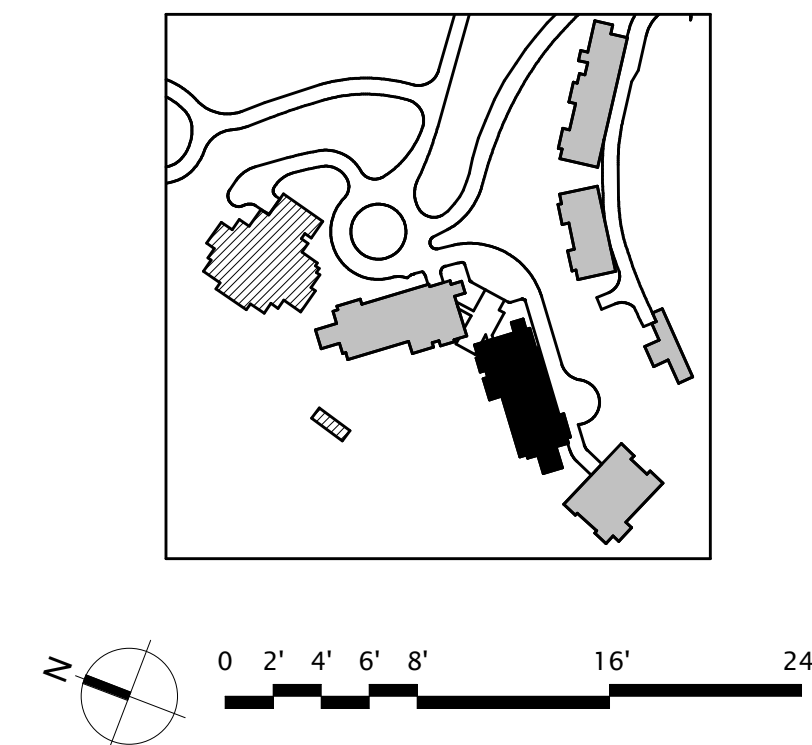



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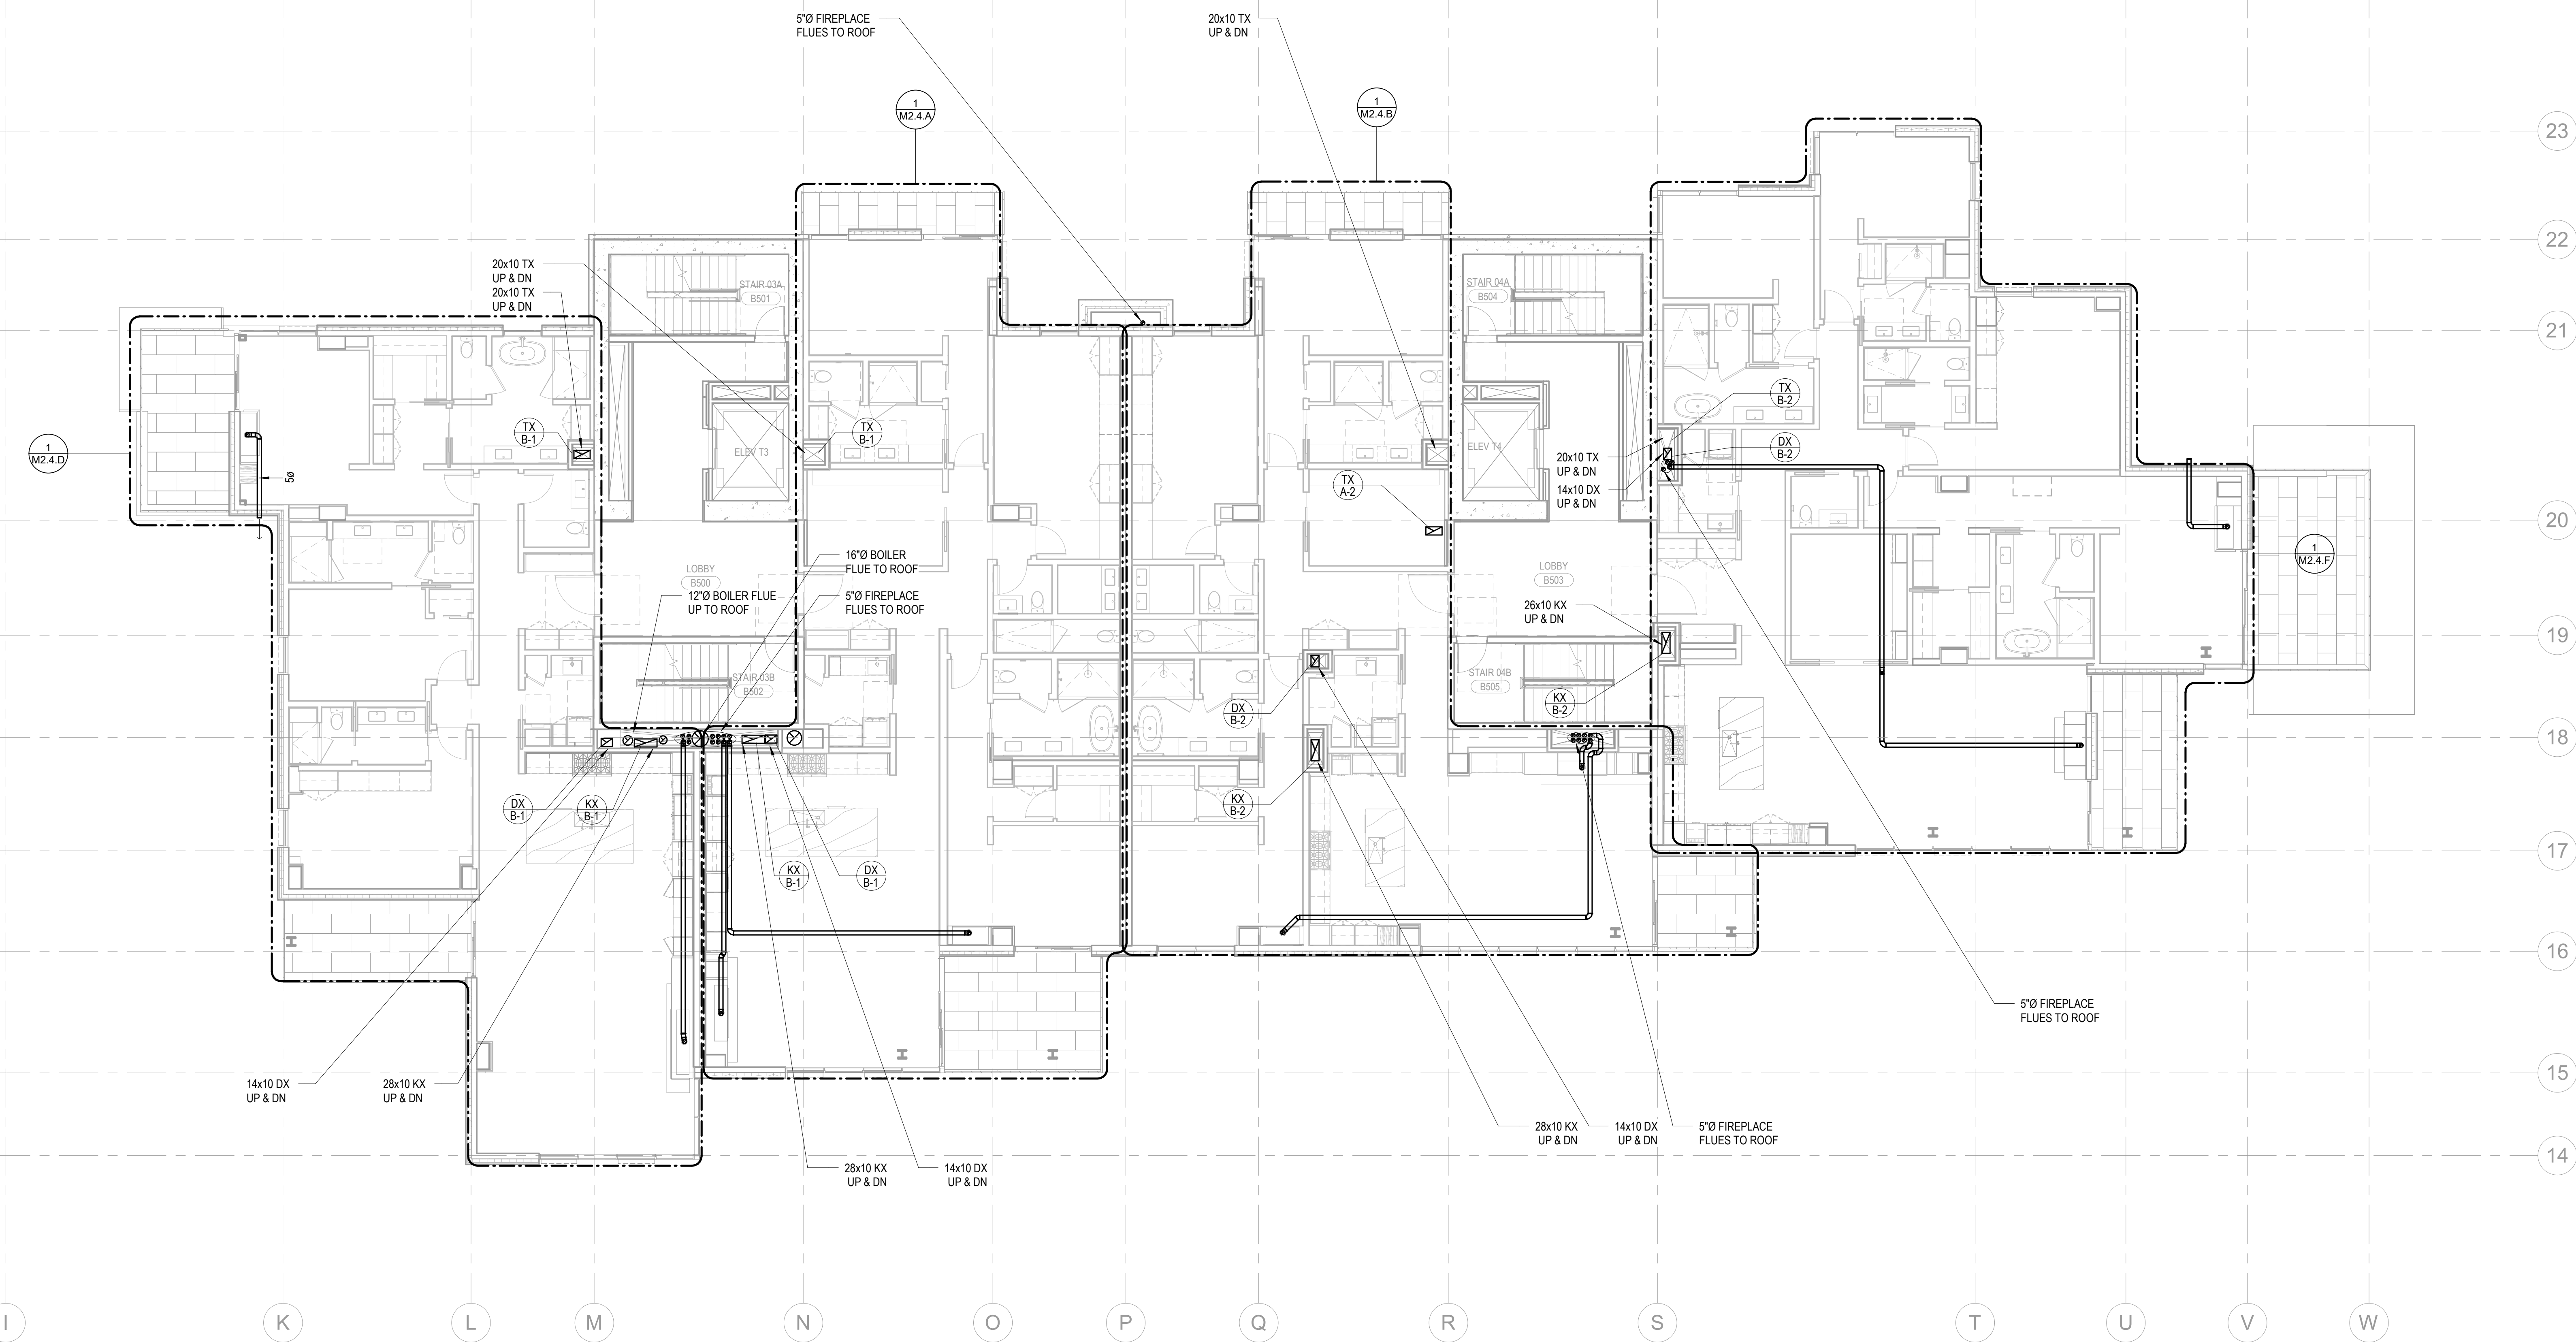
TOWER B - LVL 5  
MECHANICAL DUCT  
PLAN

M2.2B.15



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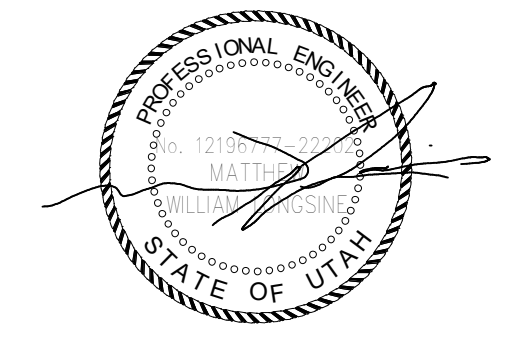
- A. REFER TO M2.4 SERIES FOR ENLARGED PLANS.  
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C. MECHANICAL EQUIPMENT SHOWN FOR REFERENCE. REFER TO ENLARGED UNIT PLANS FOR DETAIL.  
D. ALL RESIDENTIAL TOILET EXHAUST, DRYER EXHAUST, AND KITCHEN RANGE HOOD EXHAUST TO BE PART OF A SUB-DUCT EXHAUST SYSTEM.

NUMBERED NOTES:



1 TOWER B - LEVEL 5 MECHANICAL DUCT PLAN  
SCALE: 1/8" = 1'-0"



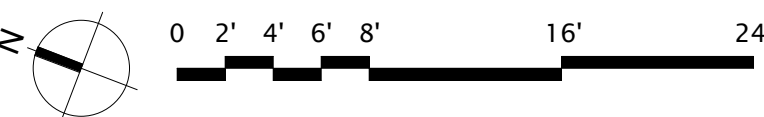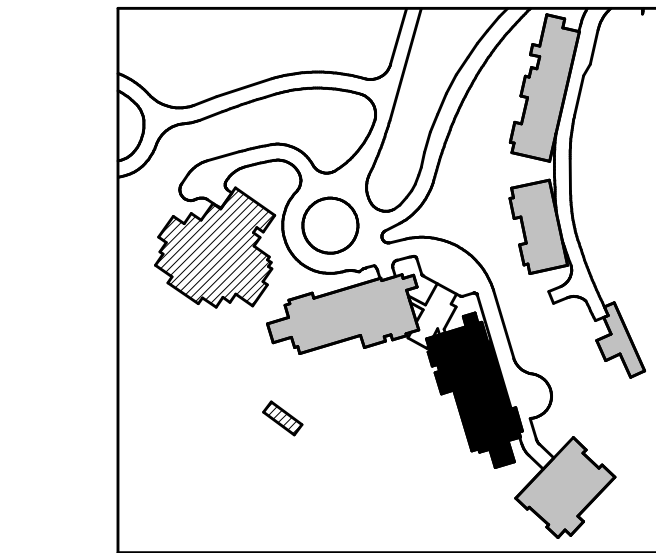

Reserved for permit stamp

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**Studio Pacifica**  
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MEP Engineer  
**WSP USA**  
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Seattle, WA 98154

principal architect \_\_\_\_\_  
project manager \_\_\_\_\_  
drawn by \_\_\_\_\_  
checked by \_\_\_\_\_  
job no. \_\_\_\_\_  
date 11/18/2022

revisions:  
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no. date by

ISSUE FOR  
CONSTRUCTION  
11/18/2022


TOWER B - LVL 6  
MECHANICAL DUCT  
PLAN

M2.2B.16



**SHEET NOTES:**


- A. REFER TO M2.4 SERIES FOR ENLARGED PLANS.  
B. FIREPLACE FLUE ROUTING SHOWN FOR REFERENCE. REFER TO ENLARGED UNIT PLANS FOR ROUTING AND SIZING DETAIL.  
C. MECHANICAL EQUIPMENT SHOWN FOR REFERENCE. REFER TO ENLARGED UNIT PLANS FOR DETAIL.  
D. ALL RESIDENTIAL TOILET EXHAUST, DRYER EXHAUST, AND KITCHEN RANGE HOOD EXHAUST TO BE PART OF A SUB-DUCT EXHAUST SYSTEM.

**NUMBERED NOTES:**

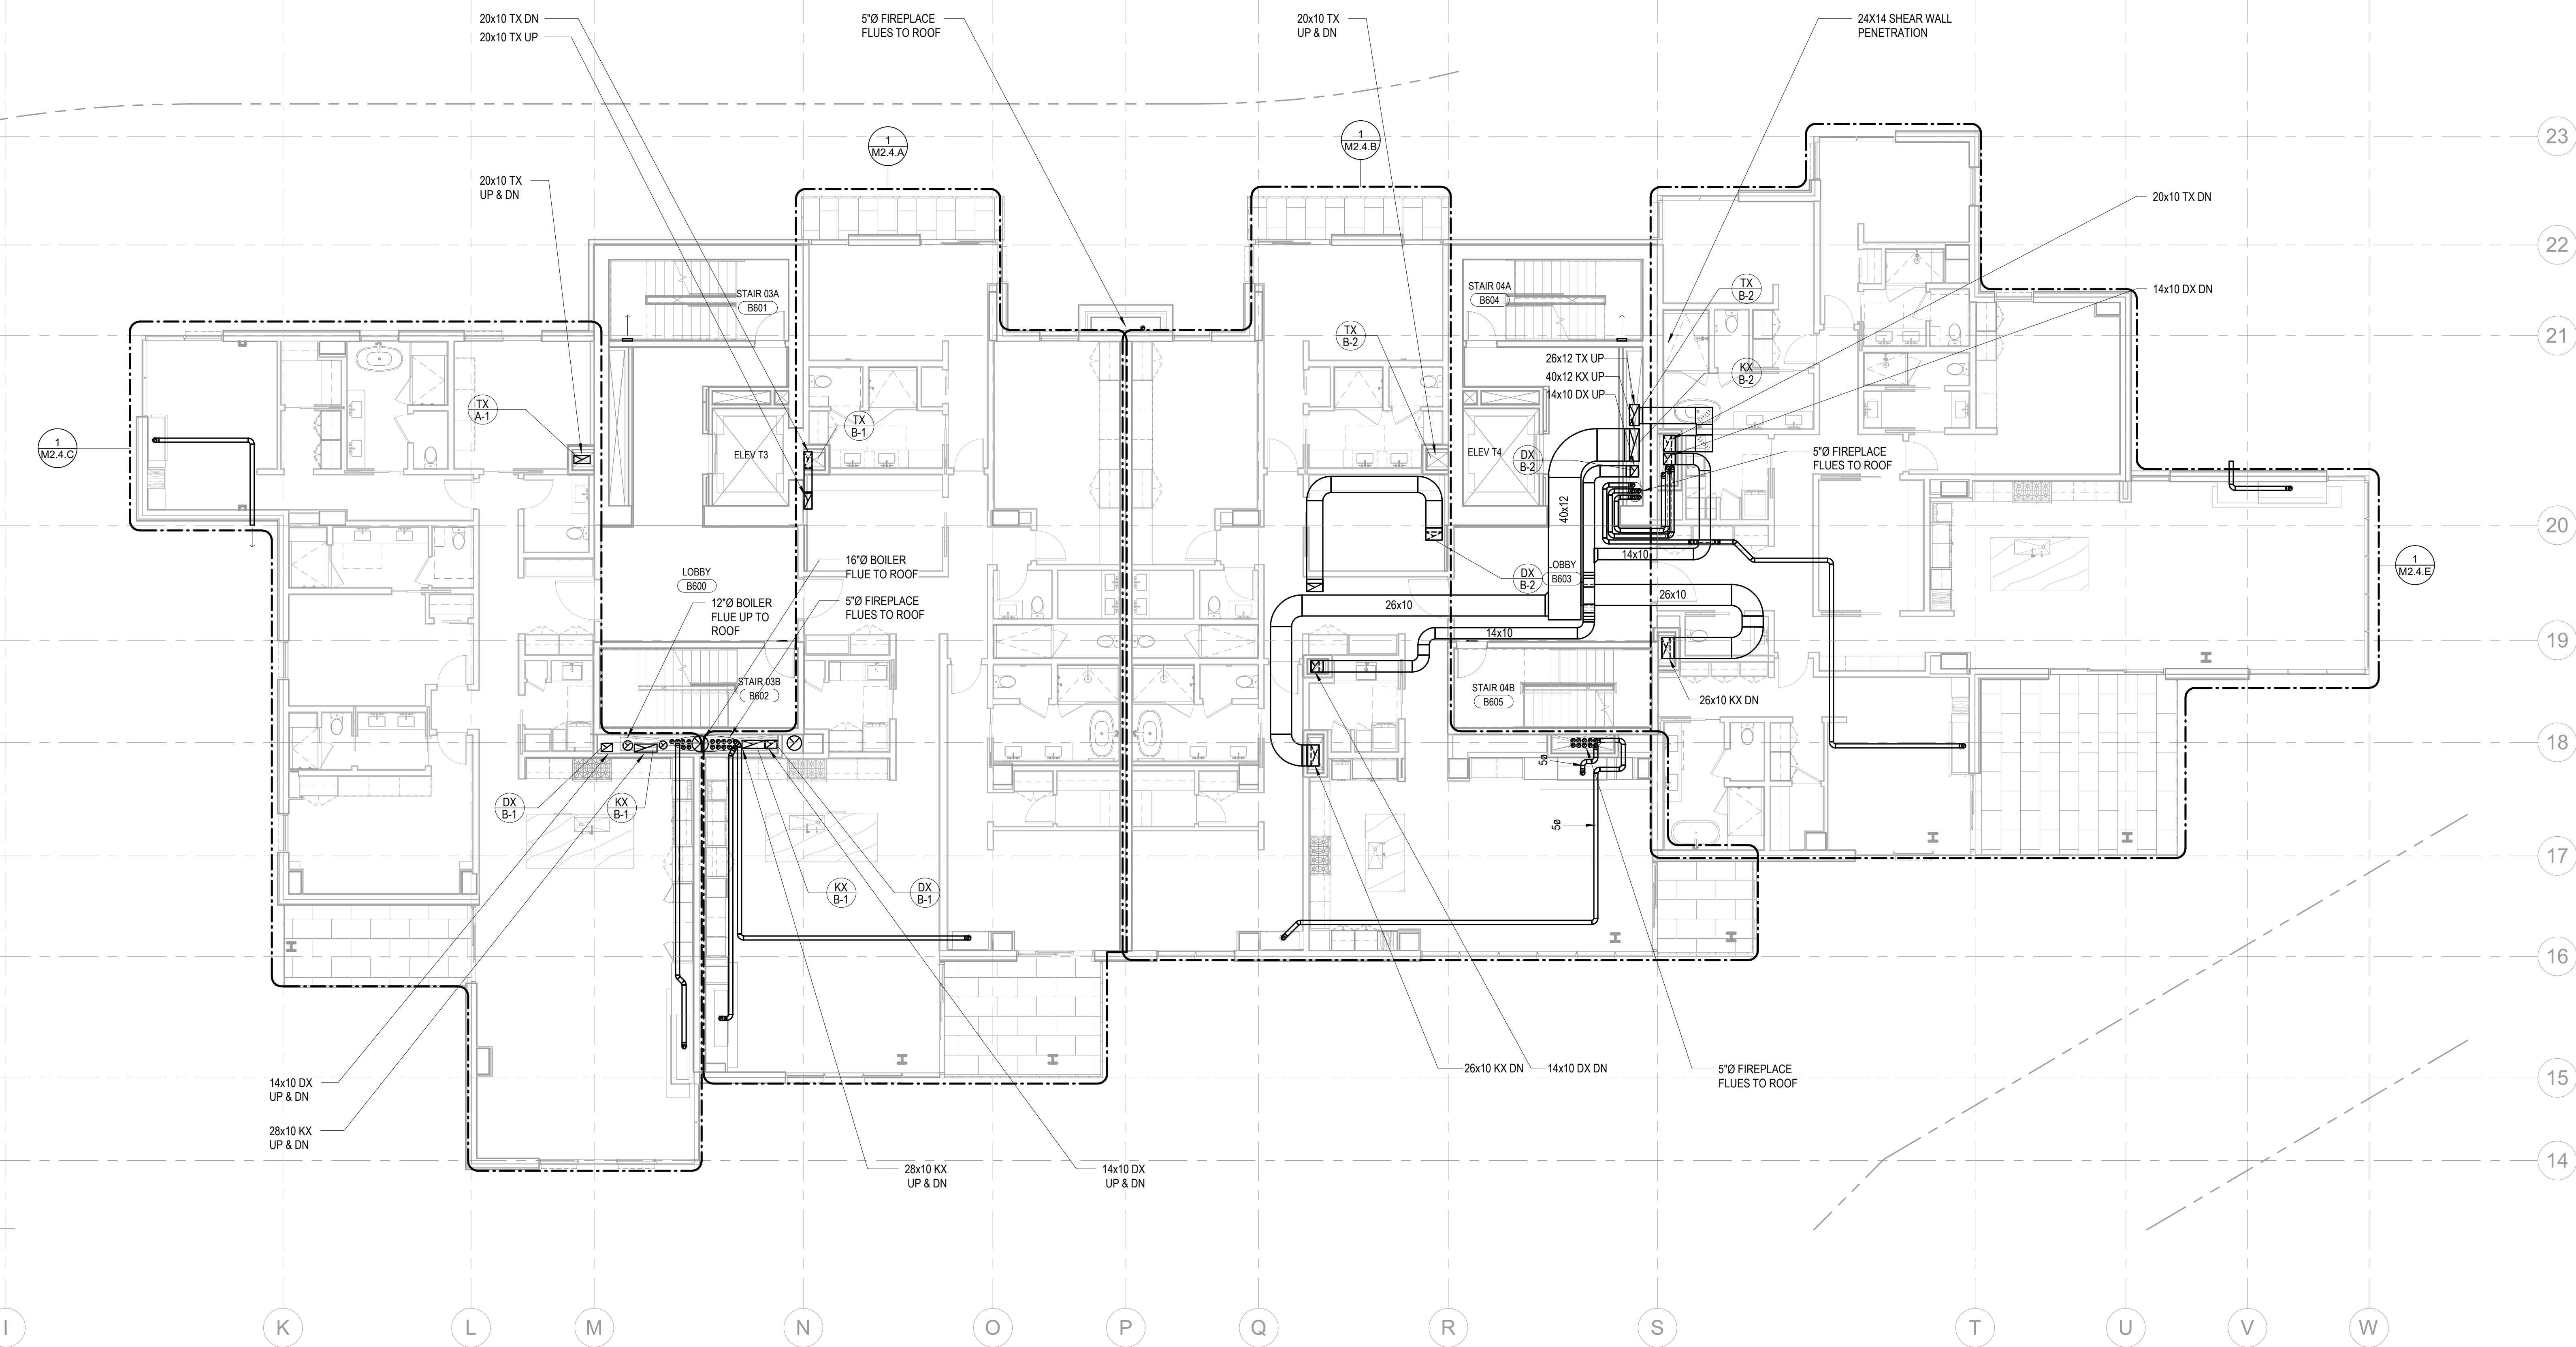

**1 TOWER B - LEVEL 6 MECHANICAL DUCT PLAN**  
SCALE: 1/8" = 1'-0"

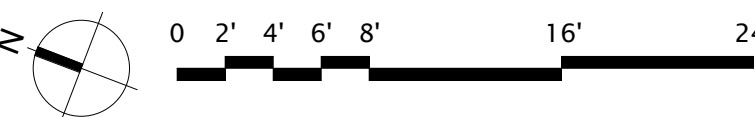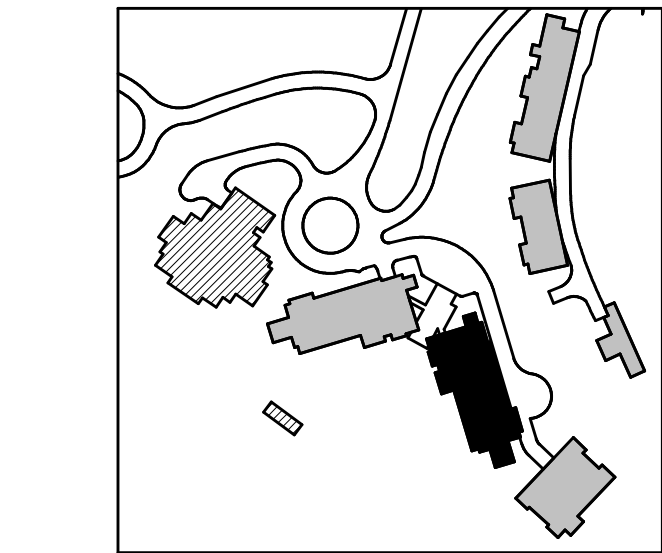


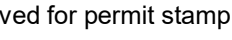

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 project manager \_\_\_\_\_  
 drawn by \_\_\_\_\_  
 \_\_\_\_\_  
 checked by Checker  
 job no. \_\_\_\_\_  
 date 11/18/2022

19:

date	by
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11/18/2022

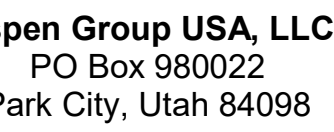
POWER B - LVL 7  
MECHANICAL DUCT  
AN

M2.2B.17



### SHEET NOTES:

A. REFER TO M2.4 SERIES FOR ENLARGED PLANS.  
B. FIREPLACE FLUE ROUTING SHOWN FOR REFERENCE. REFER TO ENLARGED UNIT PLANS FOR ROUTING AND SIZING DETAIL.  
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D. ALL RESIDENTIAL TOILET EXHAUST, DRYER EXHAUST, AND KITCHEN RANGE HOOD EXHAUST TO BE PART OF A SUB-DUCT EXHAUST SYSTEM.


**NUMBERED NOTES:**

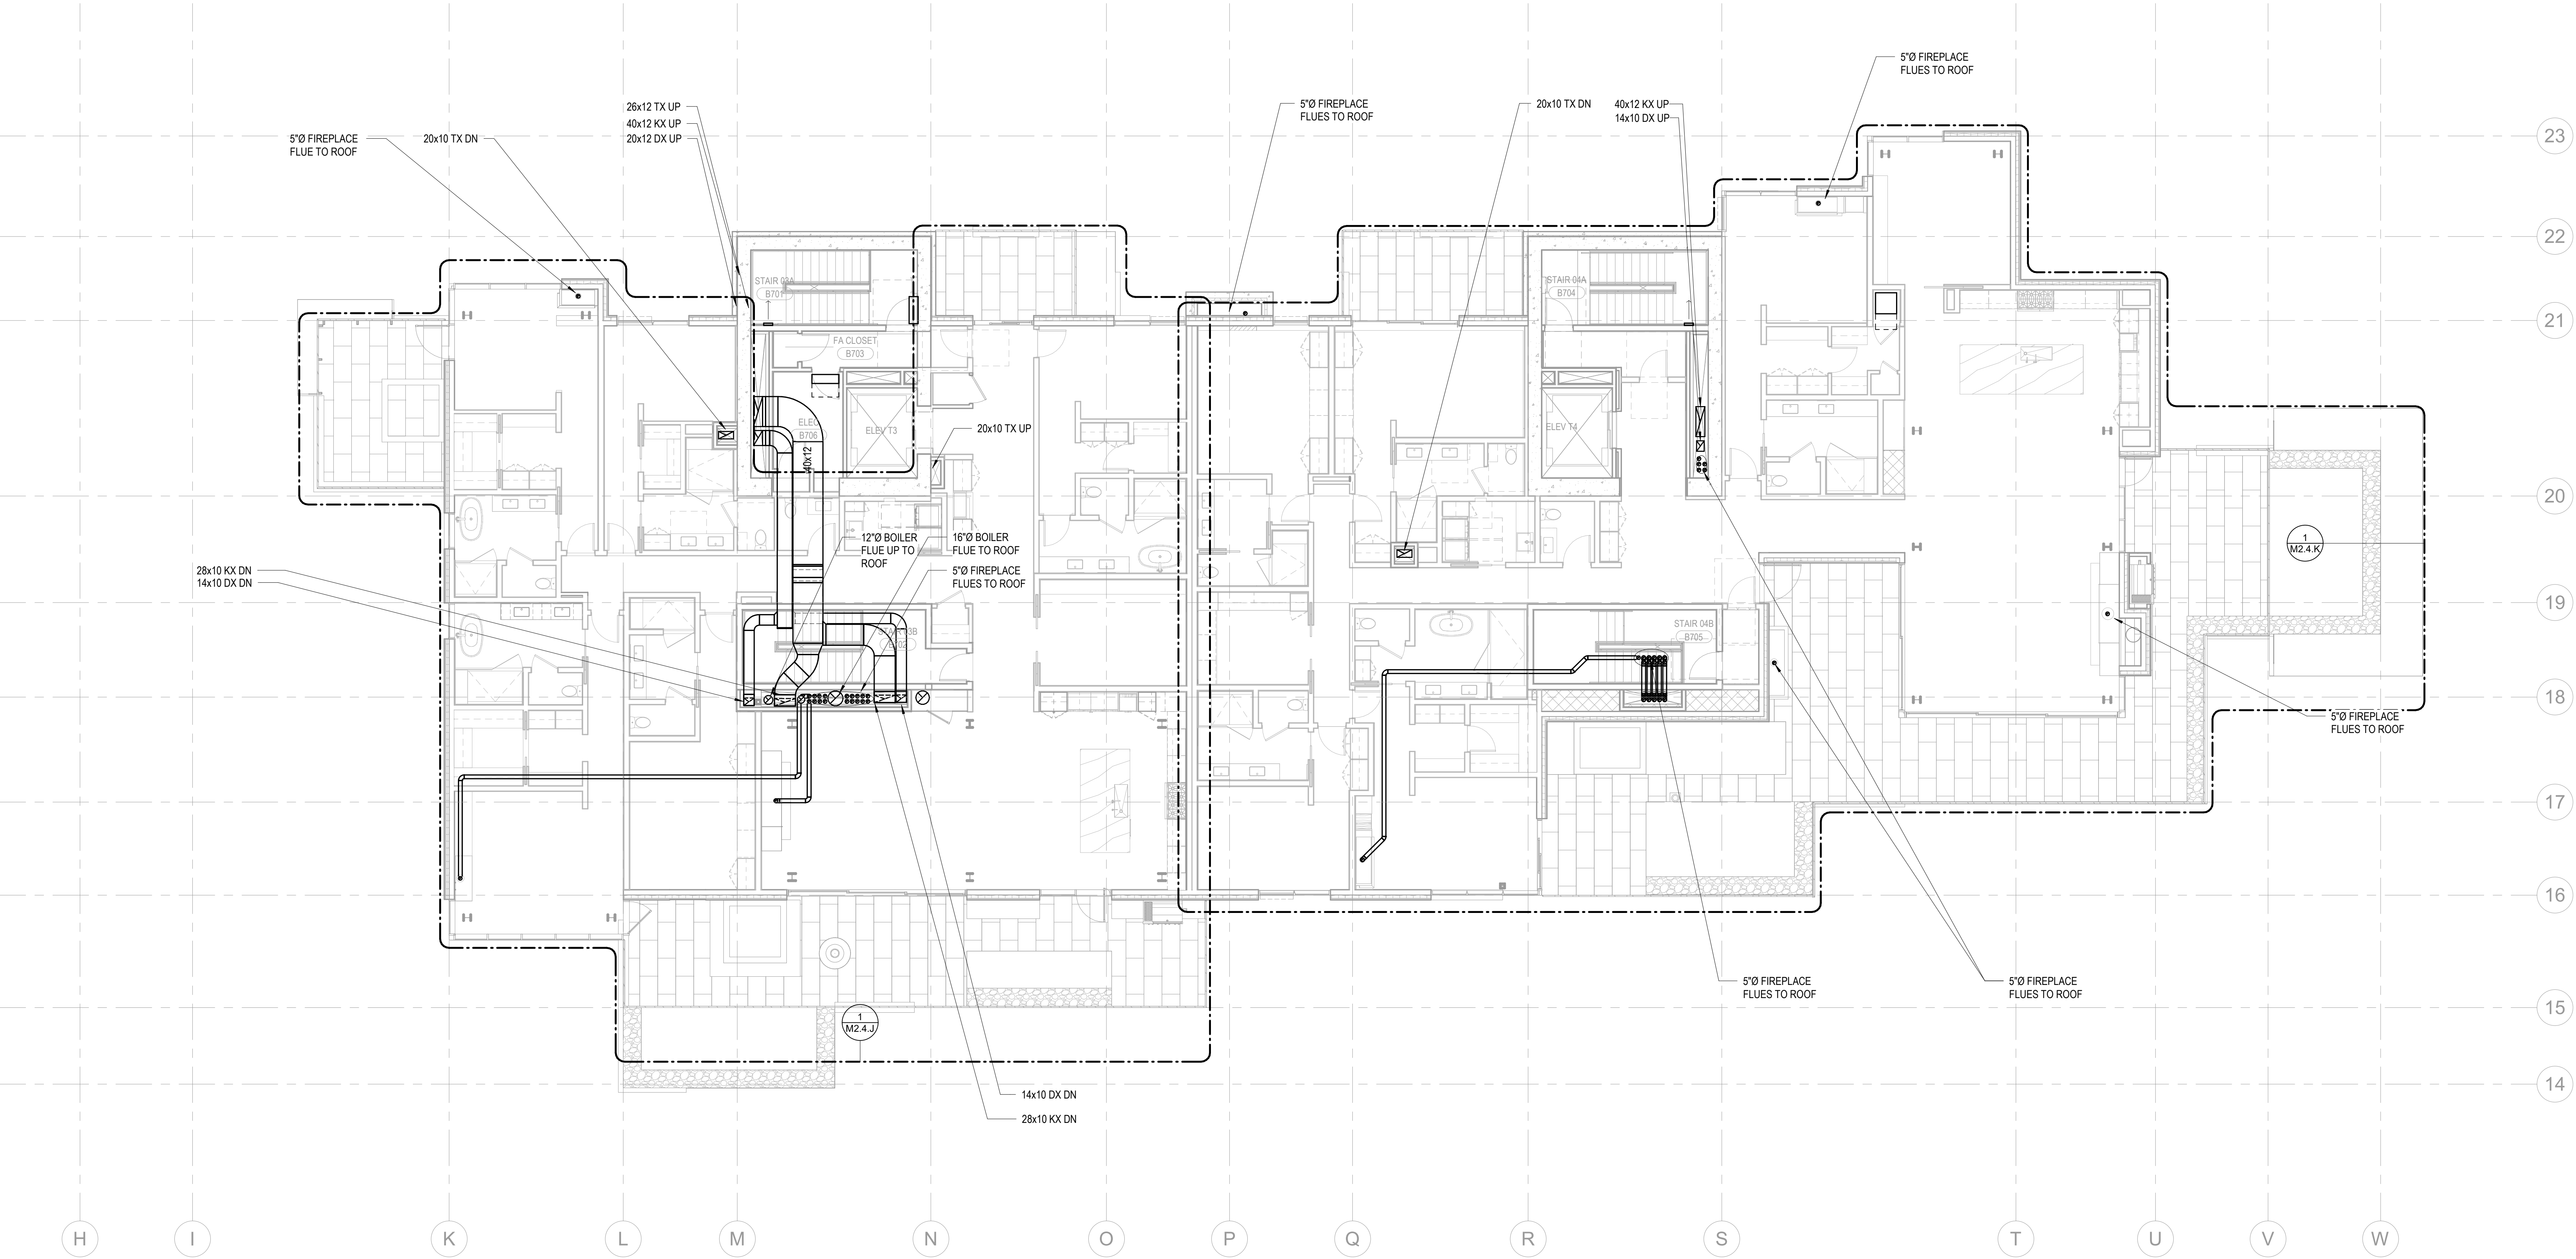

1 TOWER B - LEVEL 7 MECHANICAL DUCT PLAN  
SCALE: 1/8" = 1'-0"

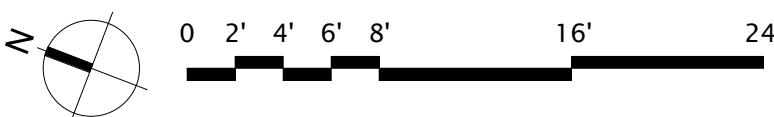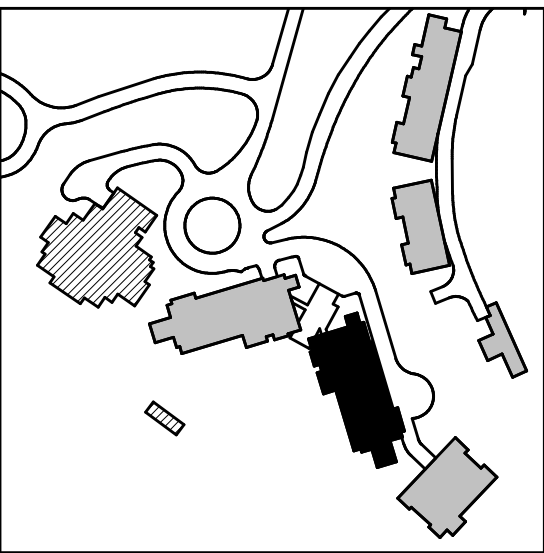




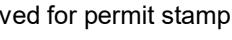

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**Jensen Hughes**  
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**Arch Bates**  
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SP USA  
01 Fourth Ave., Suite 3100  
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principal architect \_\_\_\_\_  
project manager \_\_\_\_\_  
drawn by \_\_\_\_\_  
checked by Checker  
job no. \_\_\_\_\_  
date 11/18/2022

ins:

date	by
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11/18/2022

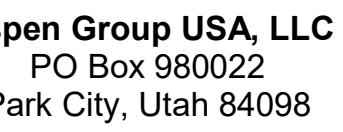POWER B - ROOF  
MECHANICAL DUCT  
PLAN

## M2.2B.R

### SHEET NOTES

- A. REFER TO M2.4 SERIES FOR ENLARGED PLANS.  
B. FIREPLACE FLUE ROUTING SHOWN FOR REFERENCE. REFER TO ENLARGED UNIT PLANS FOR ROUTING AND SIZING DETAIL.  
C. MECHANICAL EQUIPMENT SHOWN FOR REFERENCE. REFER TO ENLARGED UNIT PLANS FOR DETAIL.



**NUMBERED NOTES:**

- 1 STAIR TO BE PROVIDED WITH 2-HR RATED CEILING

