

1 TOWER A/B - PARKING LEVEL 2 LOBBY MECHANICAL DUCT PLAN SCALE: 1/8" = 1'-0"

SHEET NOTES:


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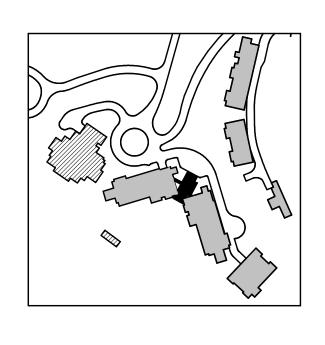
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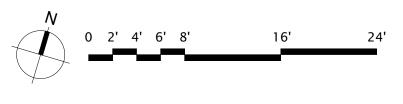
- A. REFER TO M2.4 SERIES FOR ENLARGED PLANS.B. FIREPLACE FLUE ROUTING SHOWN FOR REFERENCE. REFER TO ENLARGED UNIT PLANS FOR ROUTING
- AND SIZING DETAIL.
  C. MECHANICAL EQUIPMENT SHOWN FOR REFERENCE. REFER TO ENLARGED UNIT PLANS FOR DETAIL.
  D. ALL DUCTS AND EQUIPMENT LOCATED IN THE GARAGE SHALL BE INSTALLED TIGHT TO UNDERSIDE OF
- THE SLAB TO MAINTAIN 8'-6" CLEARANCES FOR VEHICLES. E. ARCHITECT SHALL PROVIDE 1-SQFT NFA OPENINGS IN ALL FULL HEIGHT, NON-RATED WALLS FOR
- RETURN AIR PATHS IF NO DUCT TRANSFER IS SHOWN. ALL EQUIPMENT, INSULATION, WIRING, AND INFRASTRUCTURE IN THE PLENUM SHALL BE PLENUM RATED.
- G. FLEX DUCT SHAL NOT BE INSTALLED ABOVE FINISHED HARD-LID CEILINGS.
   H. PROVIDE BUTTON TYPE TEMPERATURE SENSOR IN PUBLIC AREAS. SEE DETAIL-13, SHEET M5.04
   I. PROVIDE REMOTE CABLE DAMPER OPERATOR IN DIFFUSERS ABOVE HARD-LID CEILINGS. SEE DETAIL-9, SHEET M5.04


# > NUMBERED NOTES:

PROVIDE CONTINUOUS PLENUM ON UNDERSIDE OF FLOOR GRILL WITHIN INTERSTITIAL SPACE FOR CONNECTION TO DUCT FROM BELOW. PROVIDE REMOTE DAMPER ACTUATORS ACCESSIBLE FROM FLOOR GRILL ARCHITECT SHALL PROVIDE RATED ENCLOSURE WITH DUCT INSTALLED TIGHT TO UNDERSIDE OF SLAB TO PREVENT THE NEED FOR FSDS





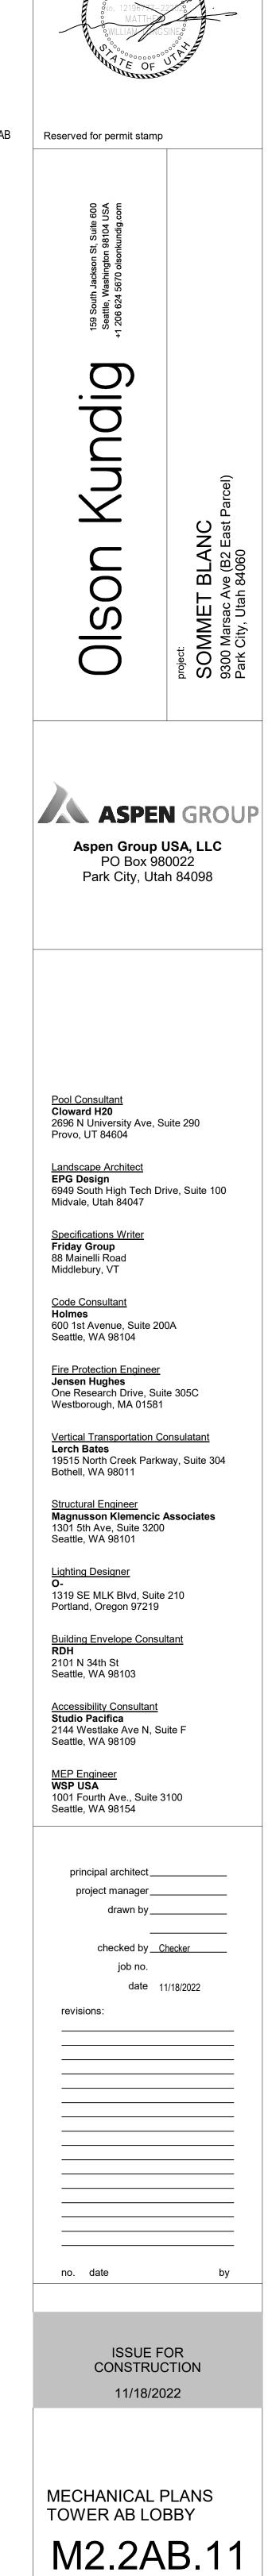

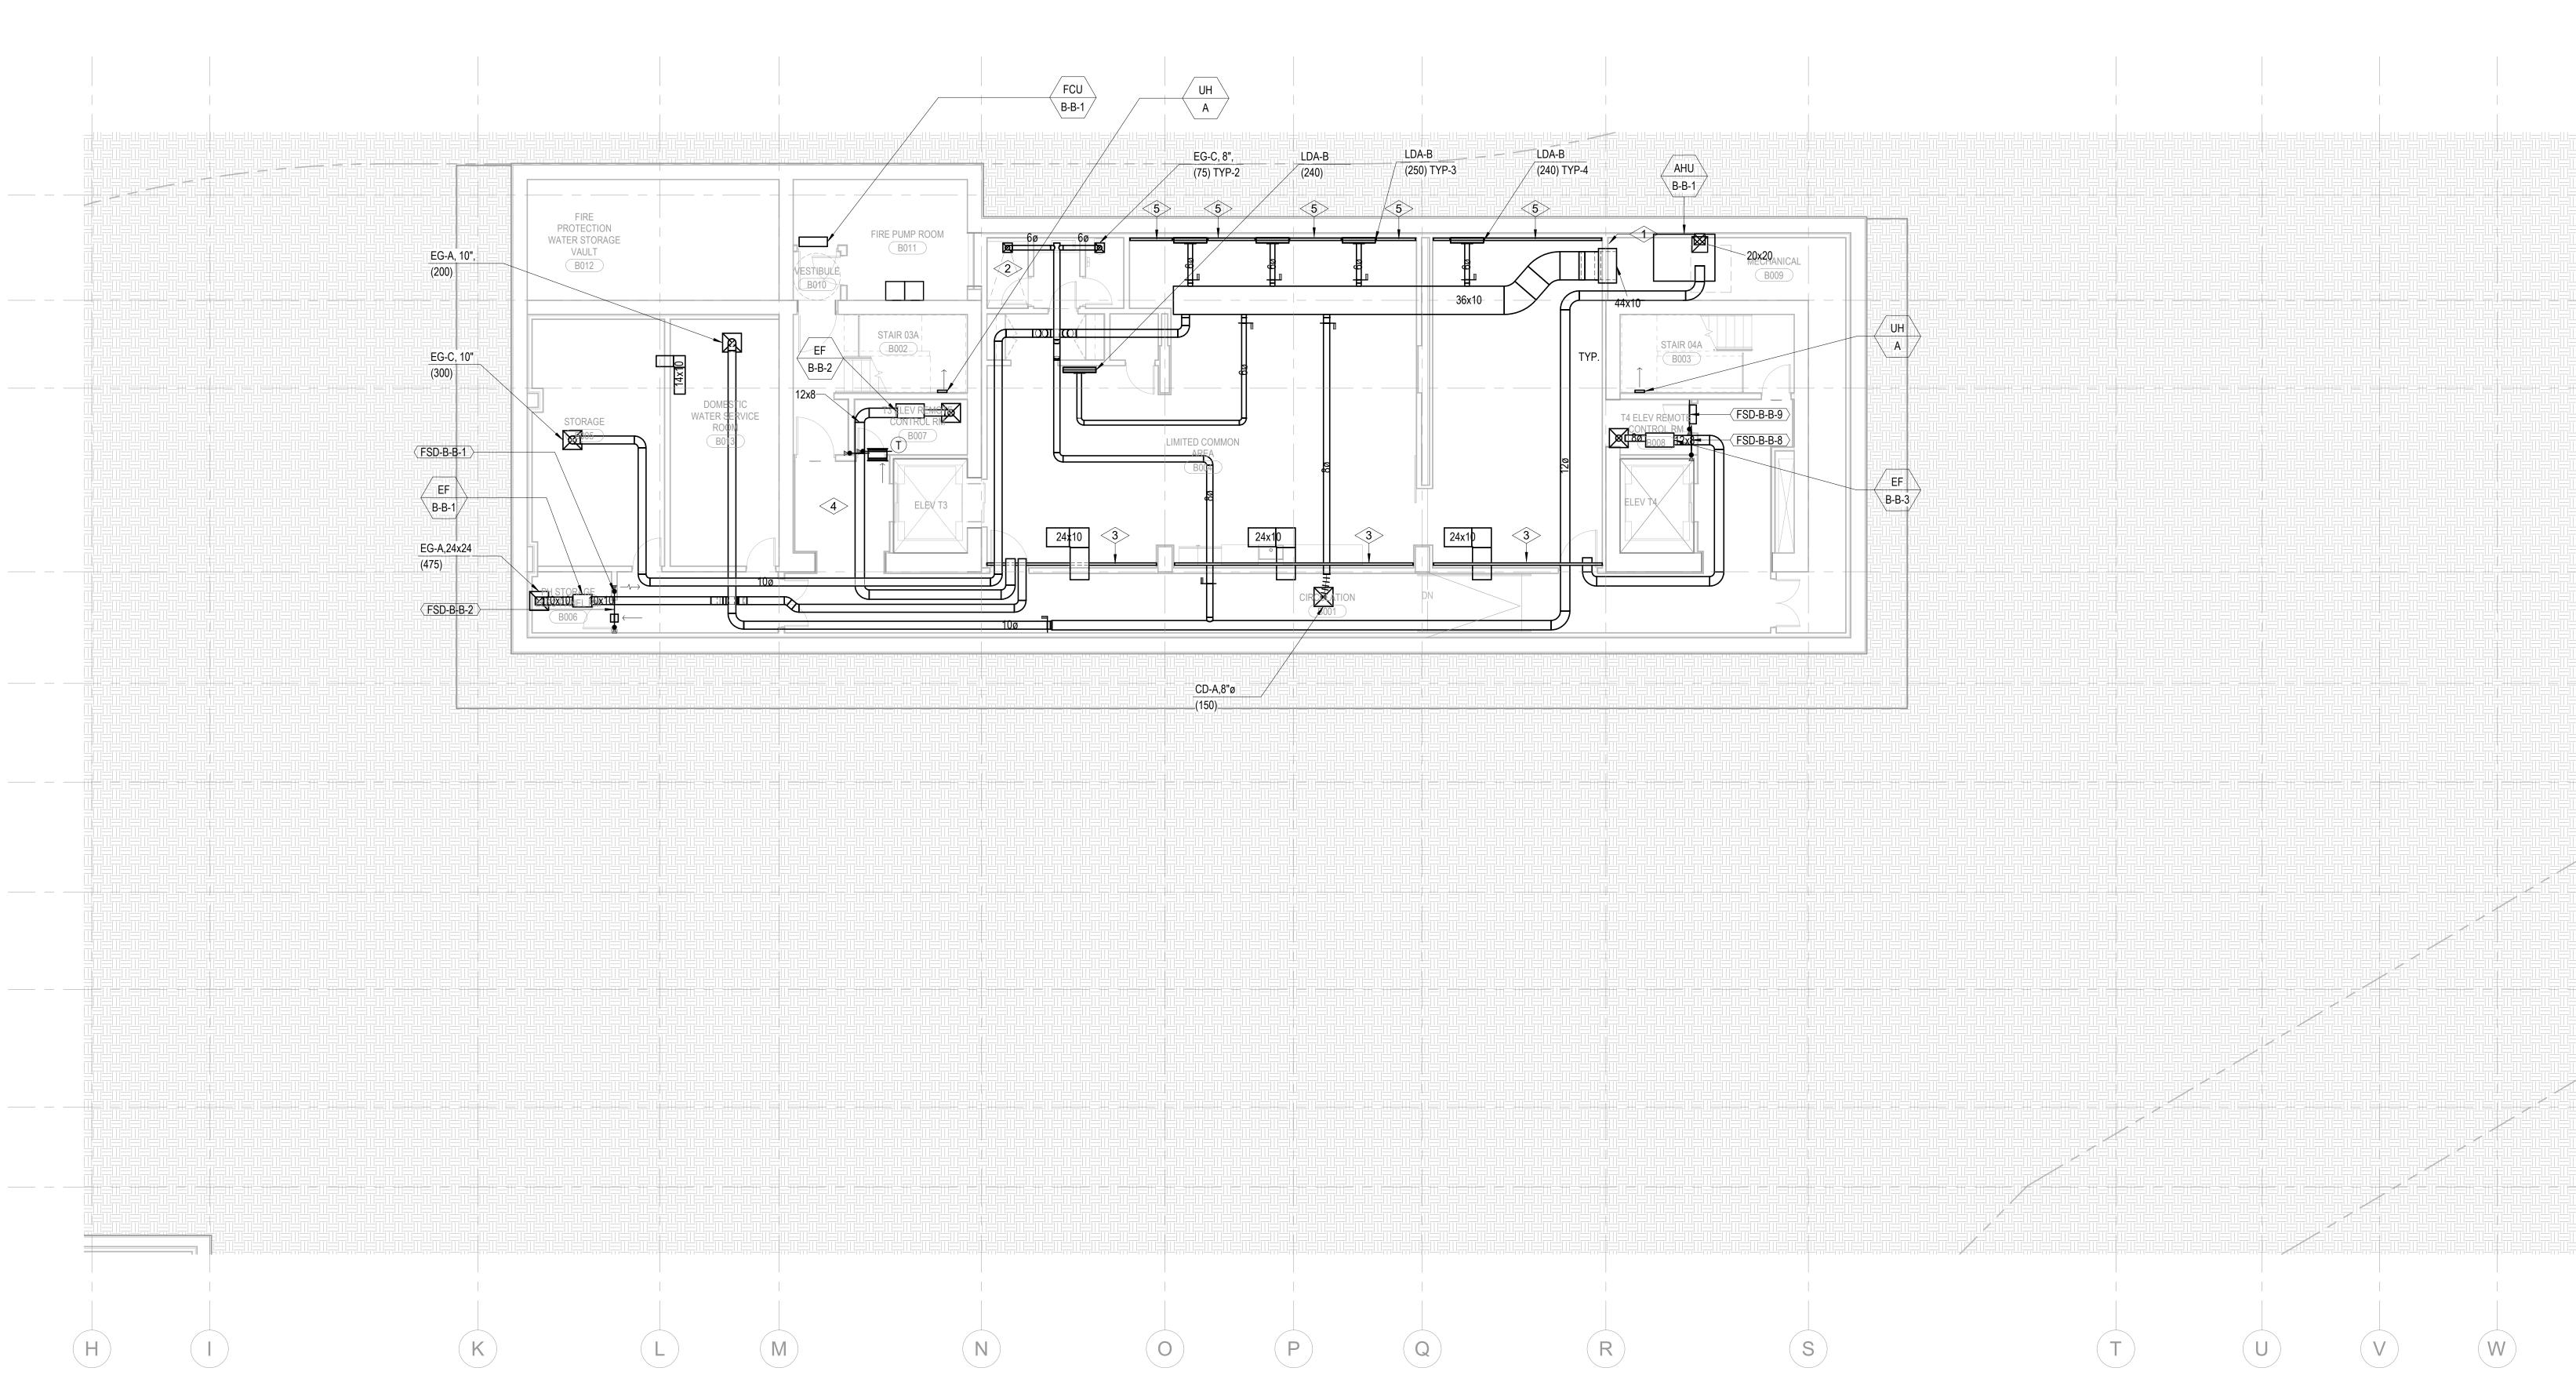

1 TOWER B - LEVEL B1 MECHANICAL DUCT PLAN SCALE: 1/8" = 1'-0"

#### SHEET NOTES:

- REFER TO M2.4 SERIES FOR ENLARGED PLANS. Α. B. FIREPLACE FLUE ROUTING SHOWN FOR REFERENCE. REFER TO ENLARGED UNIT PLANS FOR ROUTING
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### #><u>NUMBERED NOTES:</u>

5

- PROVIDE 44X10 TRANSFER DUCT INTO MECH ROOM 2 GRILL AND DUCTWORK BACK TO BRANCH LINE SHALL BE STAINLESS STEEL CONSTRUCTION 3 3" FREE AIR GAP ALONG THIS WALL FOR RETURN AIR. SEE ARCH DRAWINGS WALL GRILL SHALL BE ABOVE FINISHED CEILING. FSD 4 ACCESS IN ELECTRICAL ROOM
  - REMAINING 3" GAP NOT OCCUPIED BY LINEAR DIFFUSER IN THIS LINE SHALL BE BLANKED OFF TO RETURN AIR AT THIS LOCATION

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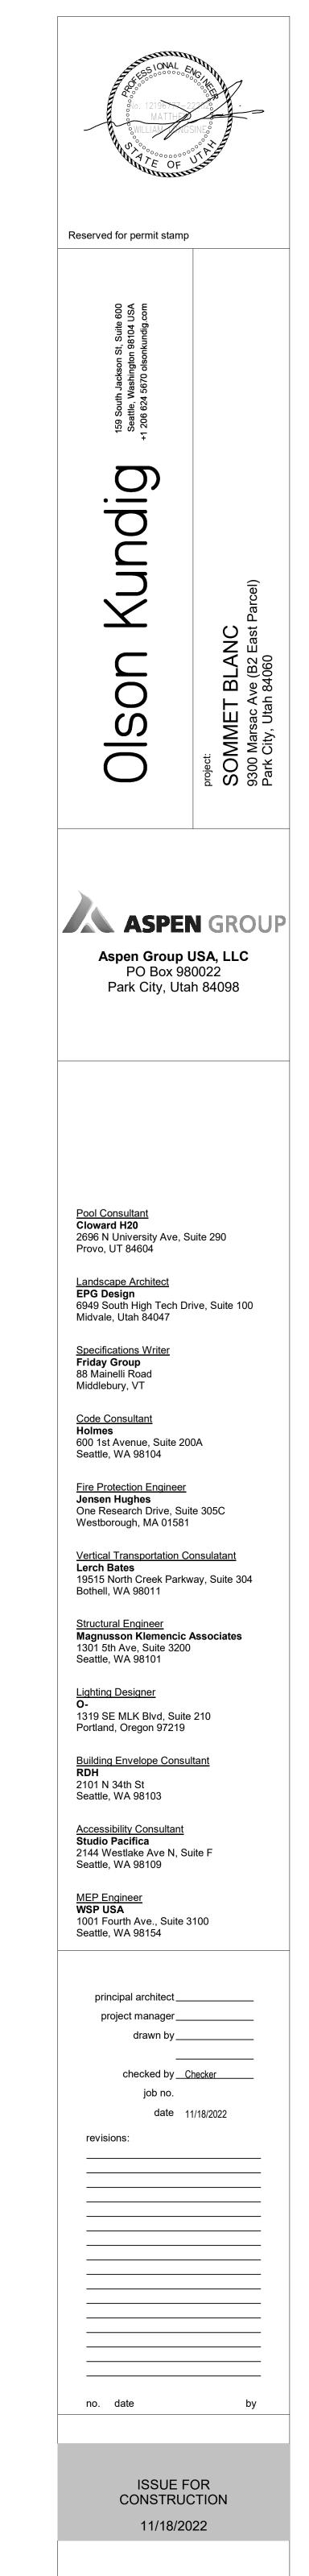
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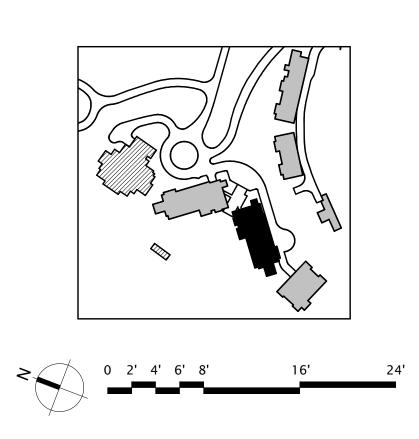
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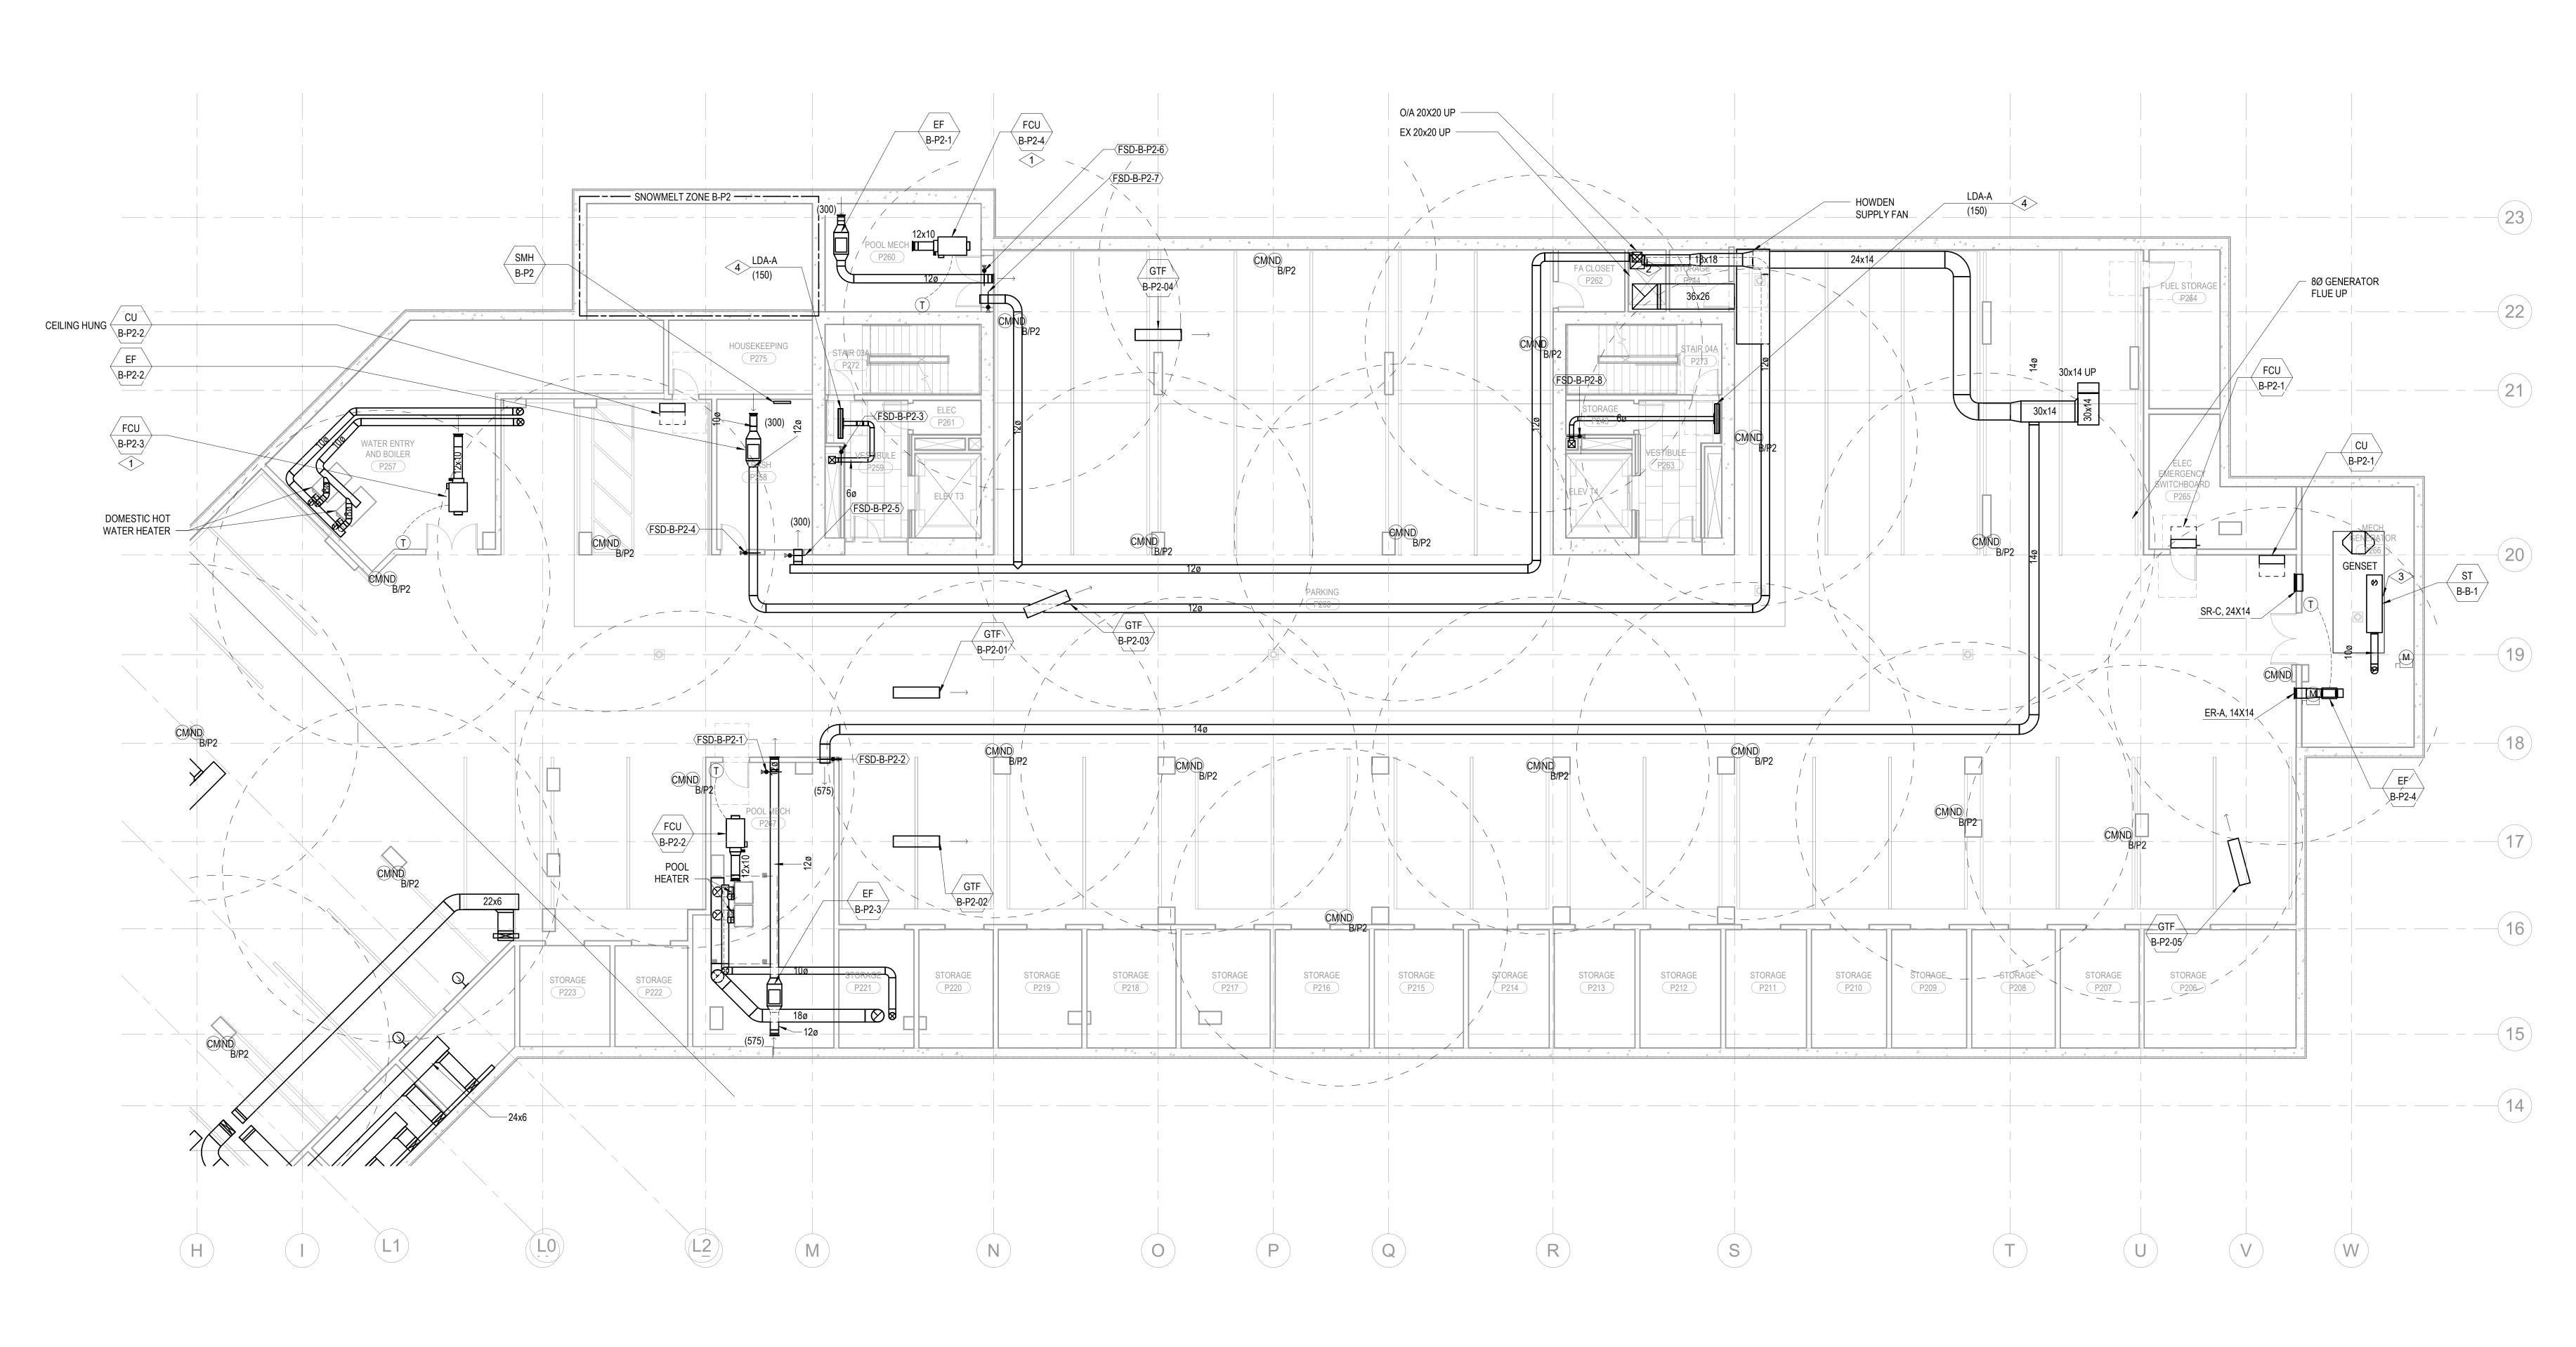
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TOWER B - LVL B MECHANICAL DUCT PLAN

M2.2B.01





1 TOWER B - PARKING LEVEL 2 MECHANICAL DUCT PLAN SCALE: 1/8" = 1'-0"


# SHEET NOTES:


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## # NUMBERED NOTES:


- ROUTE CONDENSATE TO NEAREST FLOOR DRAIN. 2 ARCHITECT TO PROVIDE 30-SQFT GRILL IN SHAFT WALL FOR GARAGE EXHAUST INTAKE. 3 GENSET EXHAUST SILENCER, FURNISHED BY OTHERS, INSTALLED BY MECHANICAL CONTRACTOR.
- 4 ARCHITECT TO PROVIDE 58-SQFT NFA GARAGE AND SPF AIR INTAKE.





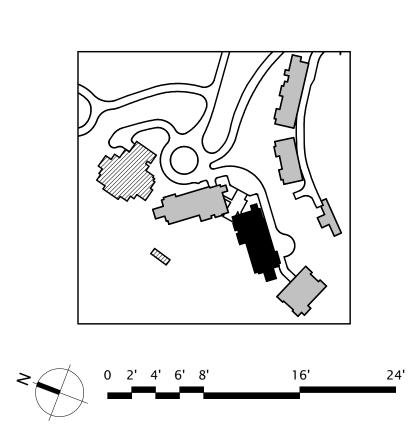


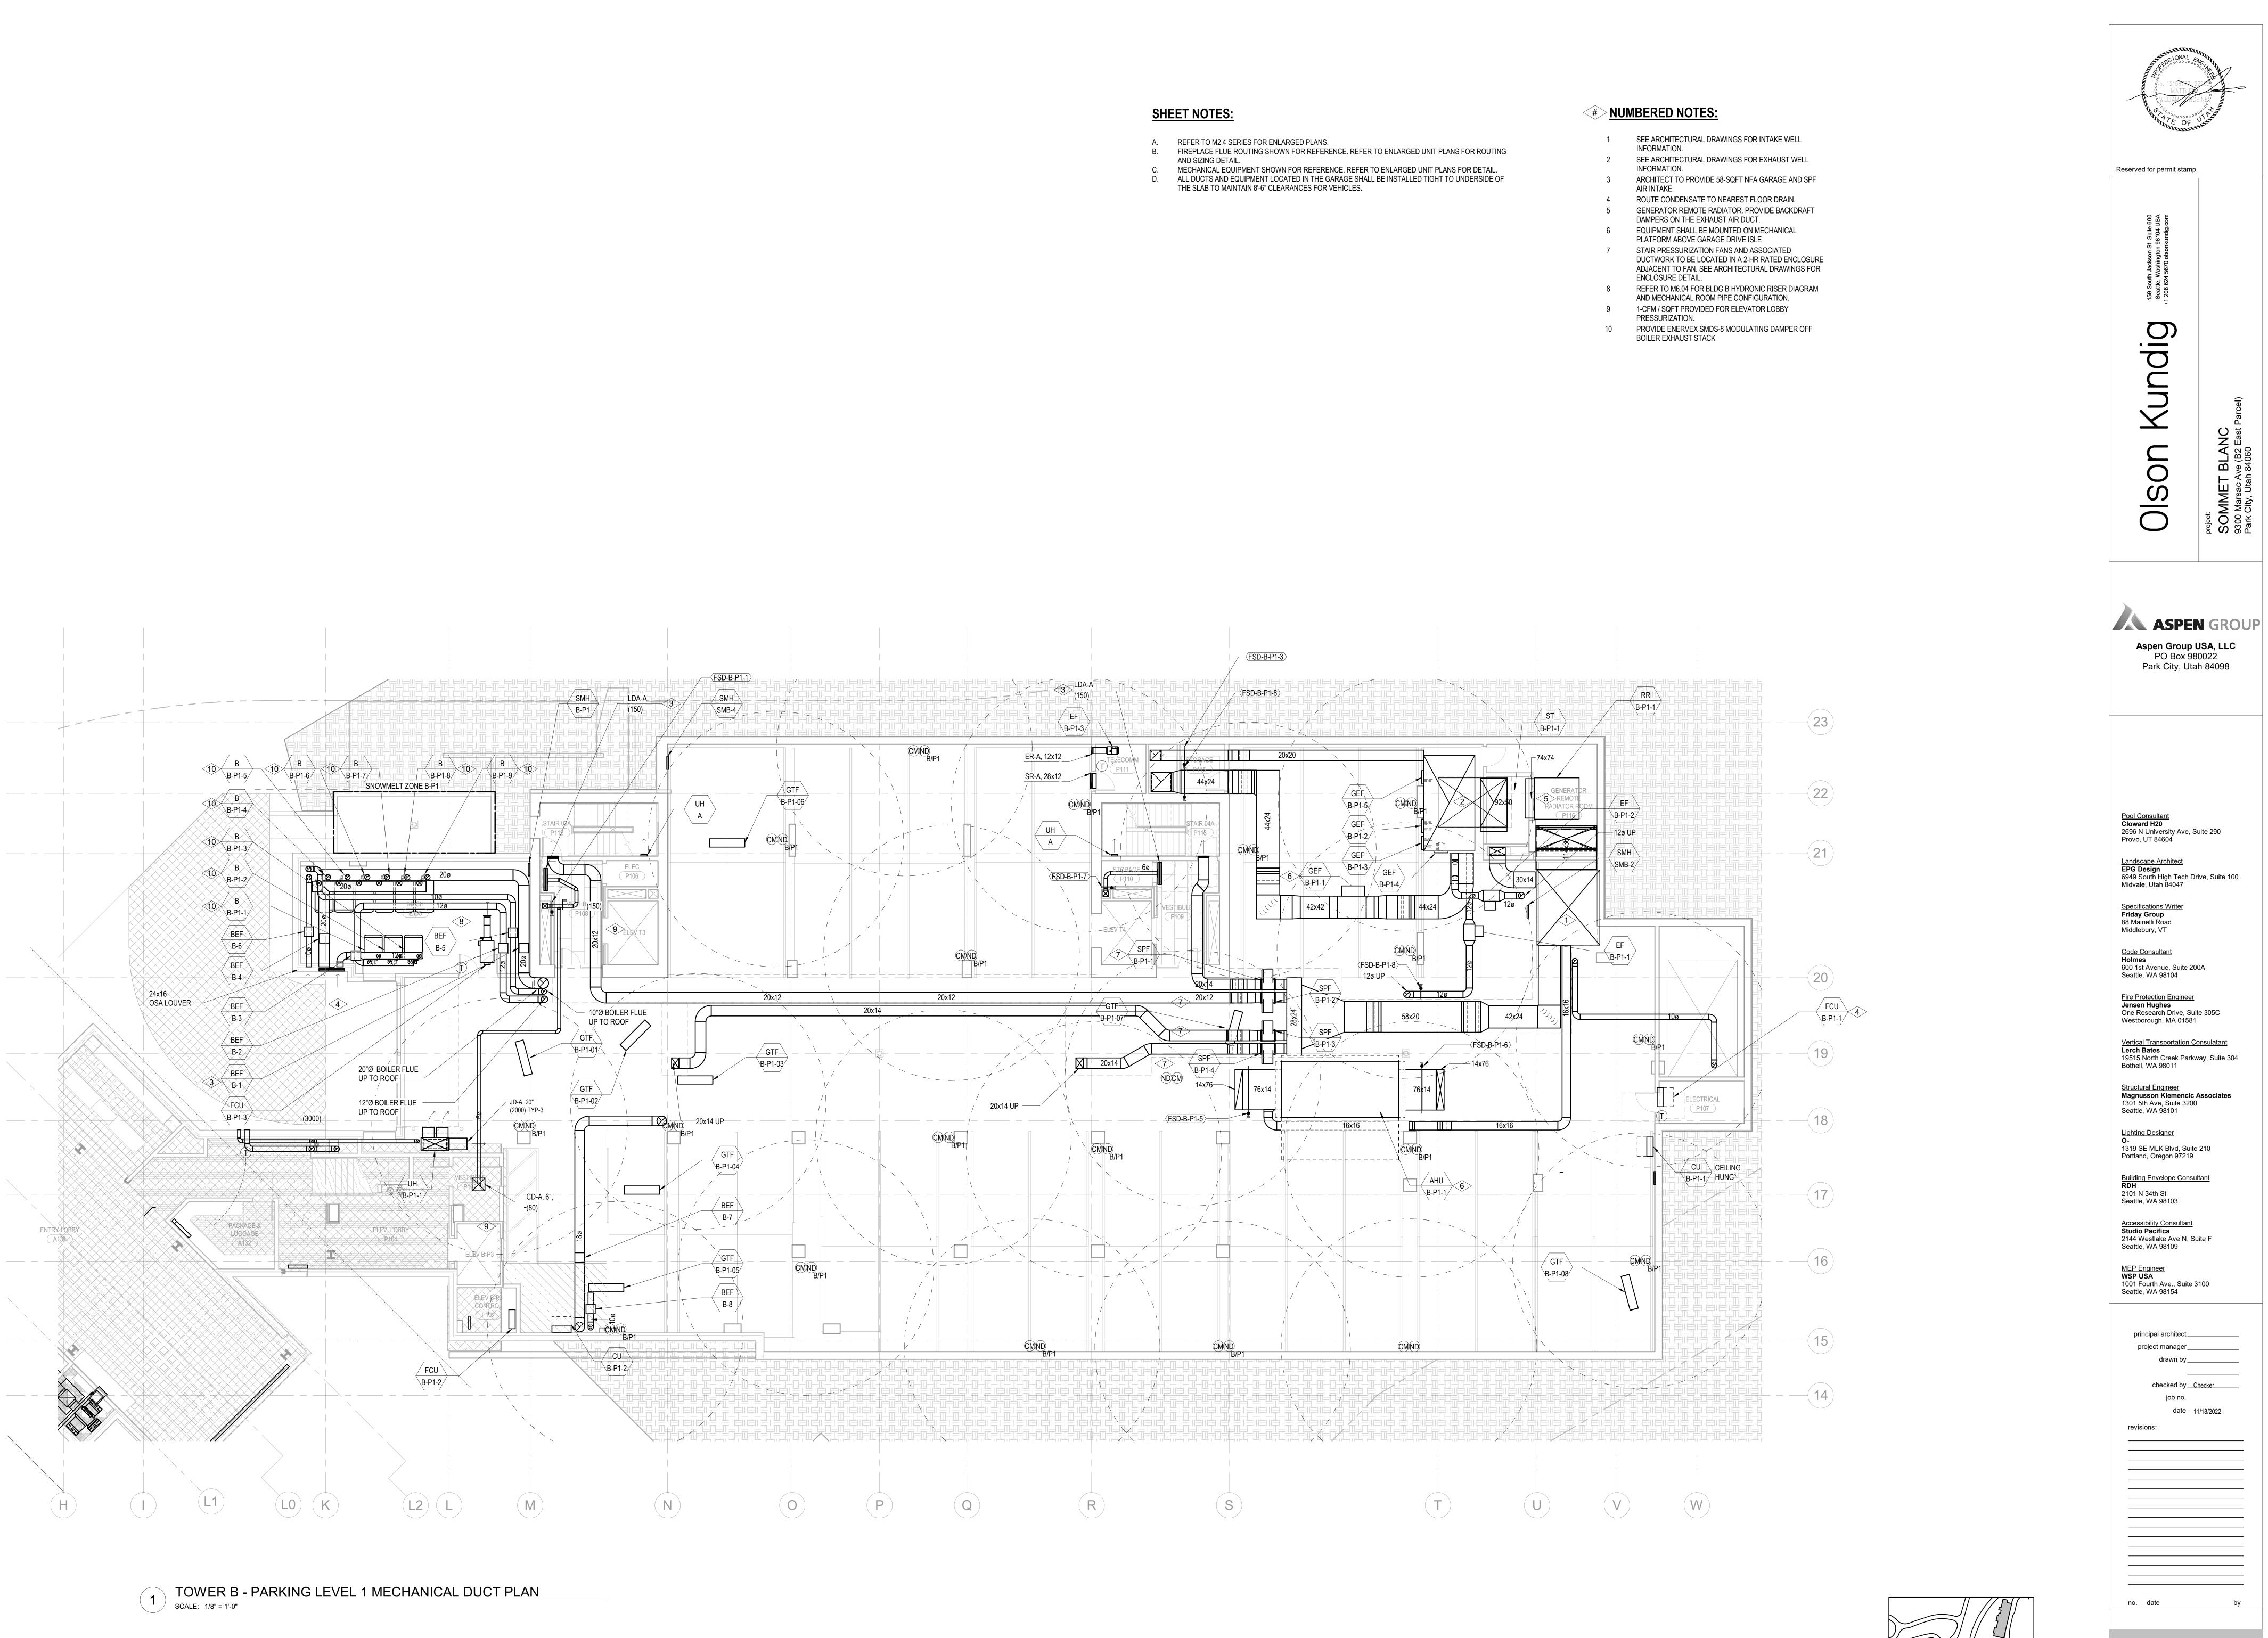
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2	SEE ARCHITECTURAL DRAWINGS FO
5	ARCHITECT TO PROVIDE 58-SQFT N AIR INTAKE.
	ROUTE CONDENSATE TO NEAREST
<b>)</b>	GENERATOR REMOTE RADIATOR. P DAMPERS ON THE EXHAUST AIR DU
i	EQUIPMENT SHALL BE MOUNTED OF PLATFORM ABOVE GARAGE DRIVE I
,	STAIR PRESSURIZATION FANS AND DUCTWORK TO BE LOCATED IN A 2- ADJACENT TO FAN. SEE ARCHITECT ENCLOSURE DETAIL.
}	REFER TO M6.04 FOR BLDG B HYDR AND MECHANICAL ROOM PIPE CONF
	1-CFM / SQFT PROVIDED FOR ELEVA PRESSURIZATION.

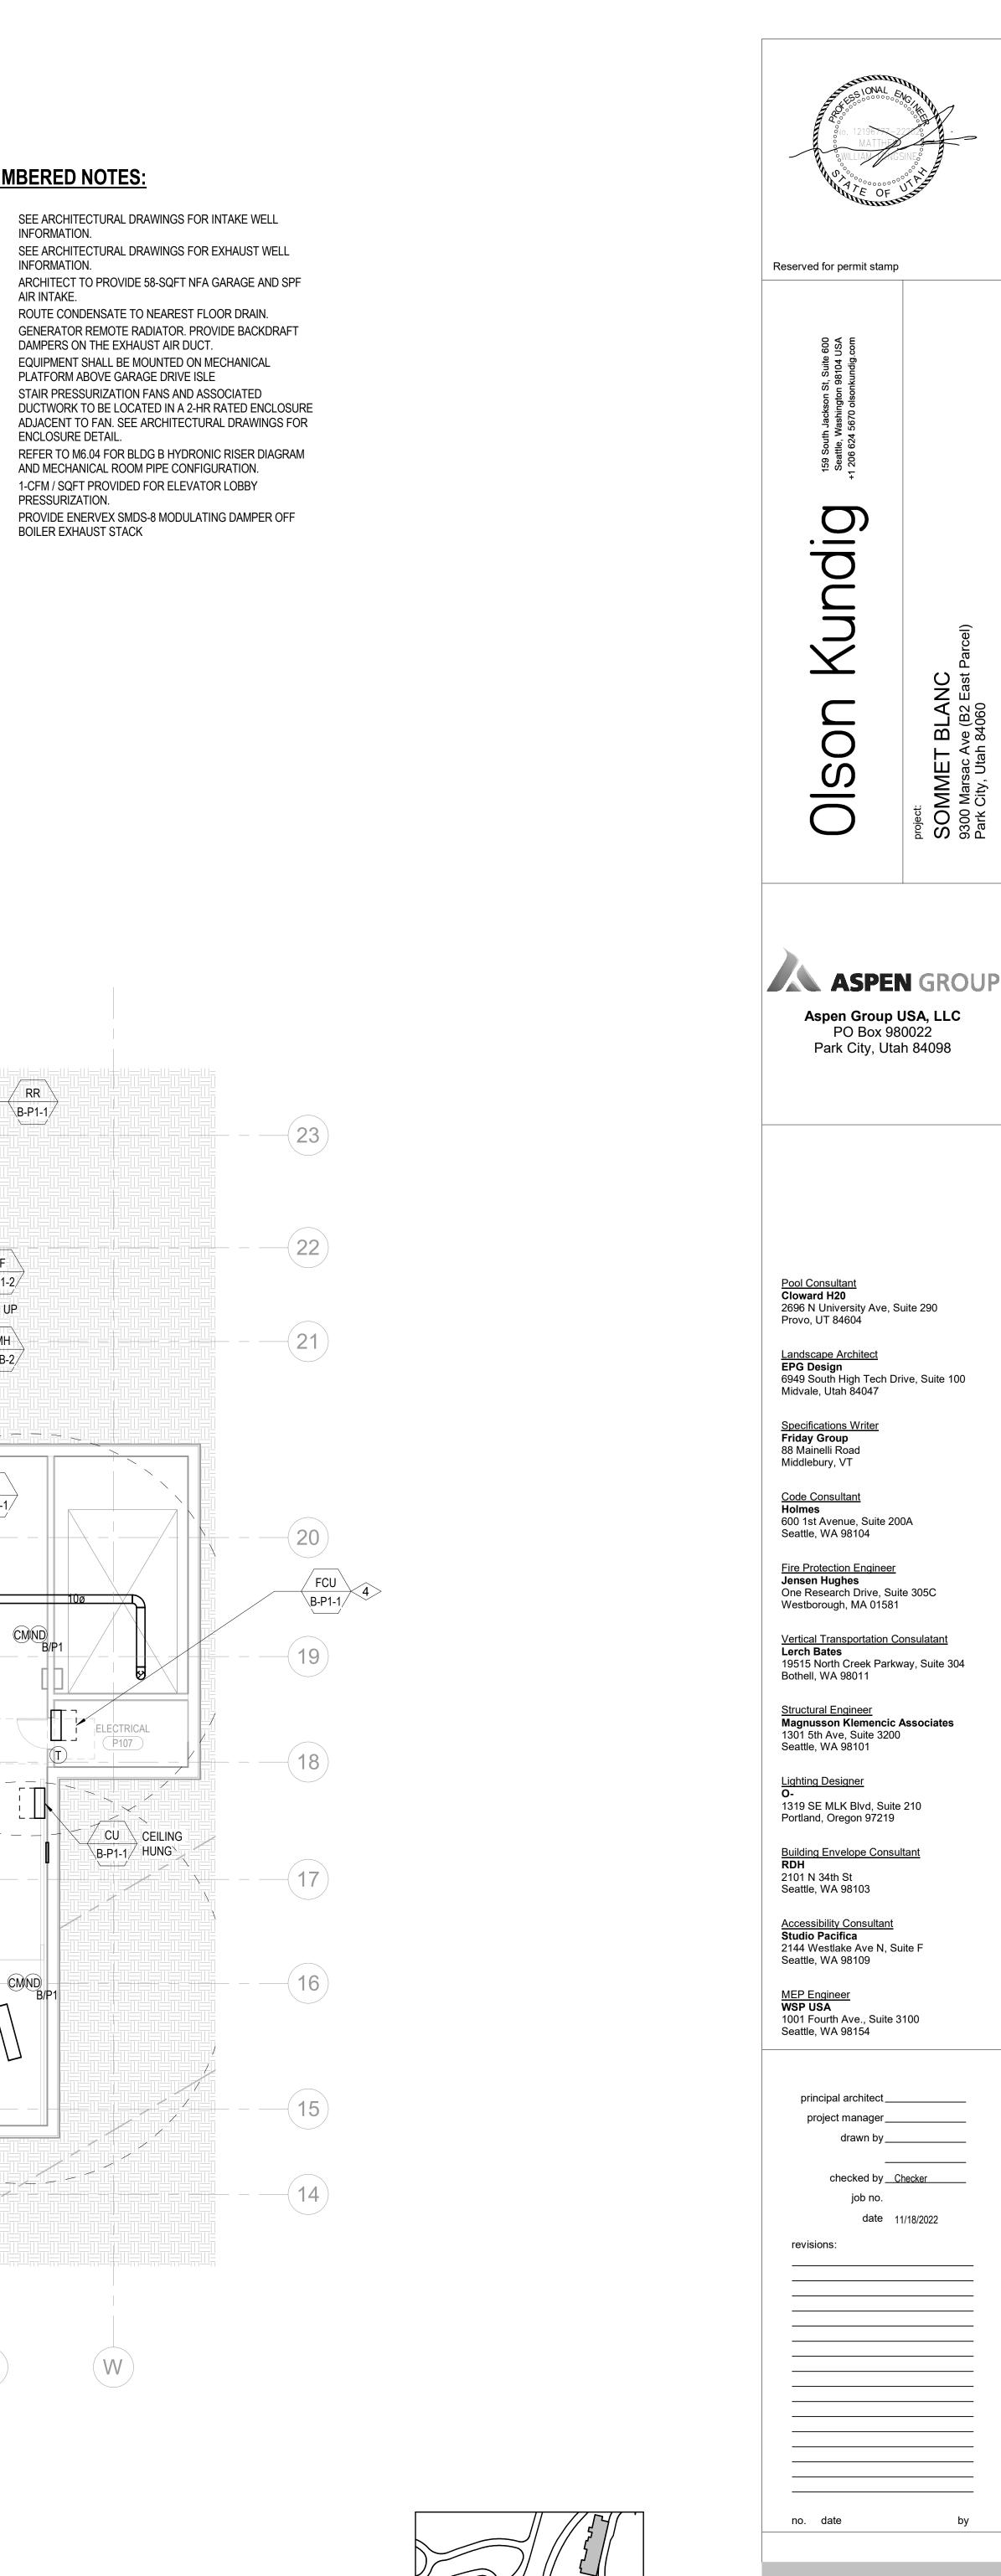

0 2' 4' 6' 8' 16' 24'

ISSUE FOR CONSTRUCTION 11/18/2022

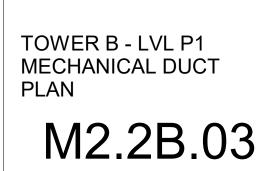

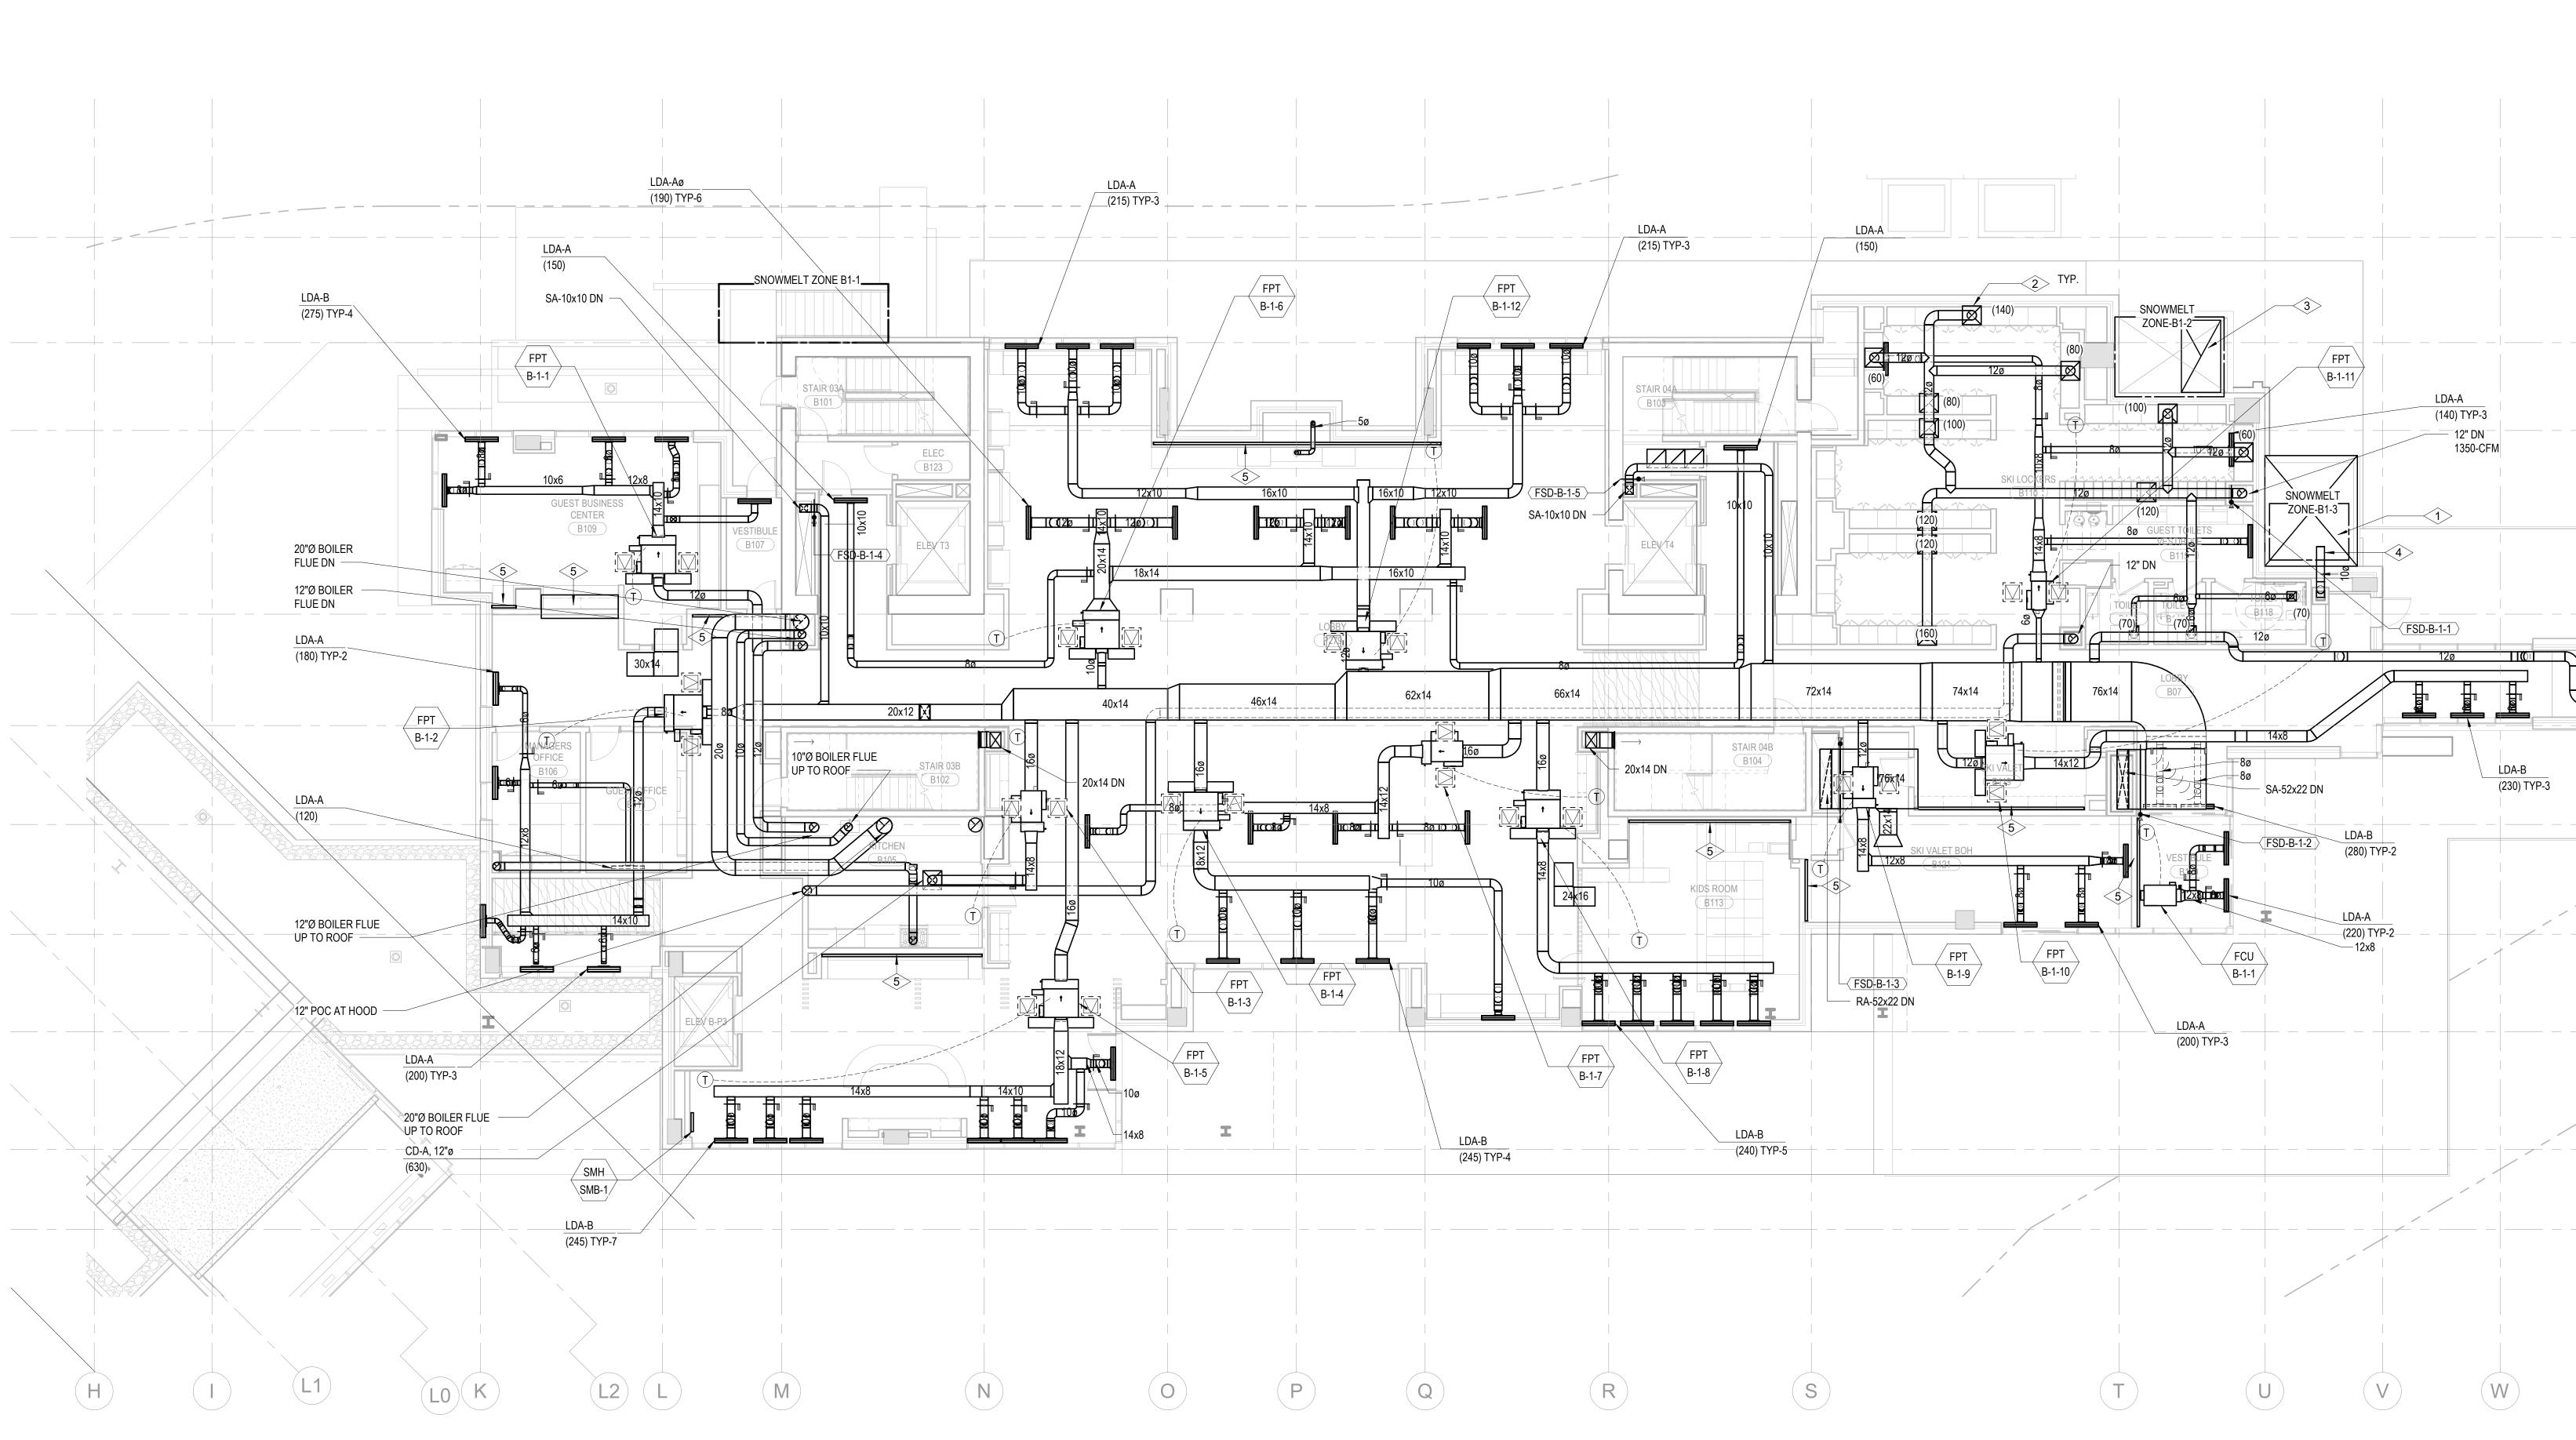

1 TOWER B - LEVEL 1 MECHANICAL DUCT PLAN SCALE: 1/8" = 1'-0"

# SHEET NOTES:


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# <u>NUMBERED NOTES:</u>

- 1 SEE ARCHITECTURAL DRAWINGS FC INFORMATION. 2 CONNECT TO TOP OF LOCKER PLEN 3 SEE ARCHITECTURAL DRAWINGS F INFORMATION. 4 GENERATOR COMBUSTION SHALL E PROPERTY LINES, 3' FROM EXTERIO 10' ABOVE GRADE AND 10' FROM OP INTO THE BUILDING.
- 5 3" FREE AIR GAP ALONG THIS WALL ARCH DRAWINGS

FOR INTAKE WELL ENUM.		WILLIAM WGSINE®		
: EXHAUST WELL HAUST 10' FROM WALLS AND ROOFS, RABLE OPENINGS OR RETURN AIR. SEE			Reserved for permission of the formulation of the f	project: <b>SOMMET BLANC</b> 9300 Marsac Ave (B2 East Parcel) Park City, Utah 84060
			ASPI Aspen Grou PO Box Park City, U	980022
23				
22			Pool Consultant	
21			Cloward H20 2696 N University Ave Provo, UT 84604 <u>Landscape Architect</u> EPG Design 6949 South High Tech Midvale, Utah 84047	
20			Specifications Writer Friday Group 88 Mainelli Road Middlebury, VT <u>Code Consultant</u> Holmes 600 1st Avenue, Suite Seattle, WA 98104 Eiro Protection Engine	
ſ 19			Fire Protection Engineer Jensen Hughes One Research Drive, Suite 305C Westborough, MA 01581 <u>Vertical Transportation Consulatant</u> Lerch Bates 19515 North Creek Parkway, Suite 304	
— — — 18			Bothell, WA 98011 <u>Structural Engineer</u> <b>Magnusson Klemencic Associates</b> 1301 5th Ave, Suite 3200 Seattle, WA 98101	
( <b>17</b> )			Lighting Designer O- 1319 SE MLK Blvd, Suite 210 Portland, Oregon 97219 Building Envelope Consultant RDH 2101 N 34th St	
— — — 16			Seattle, WA 98103 <u>Accessibility Consultant</u> <u>Studio Pacifica</u> 2144 Westlake Ave N, Suite F Seattle, WA 98109 <u>MEP Engineer</u>	
			WSP USA 1001 Fourth Ave., Sui Seattle, WA 98154 principal architect	
(15)			project manager drawn by checked by	Checker
(14)			revisions: 	11/18/2022

ISSUE FOR
CONSTRUCTION
11/18/2022
FOWER B - LVL 1 MECHANICAL DUCT PLAN
M2.2B.11

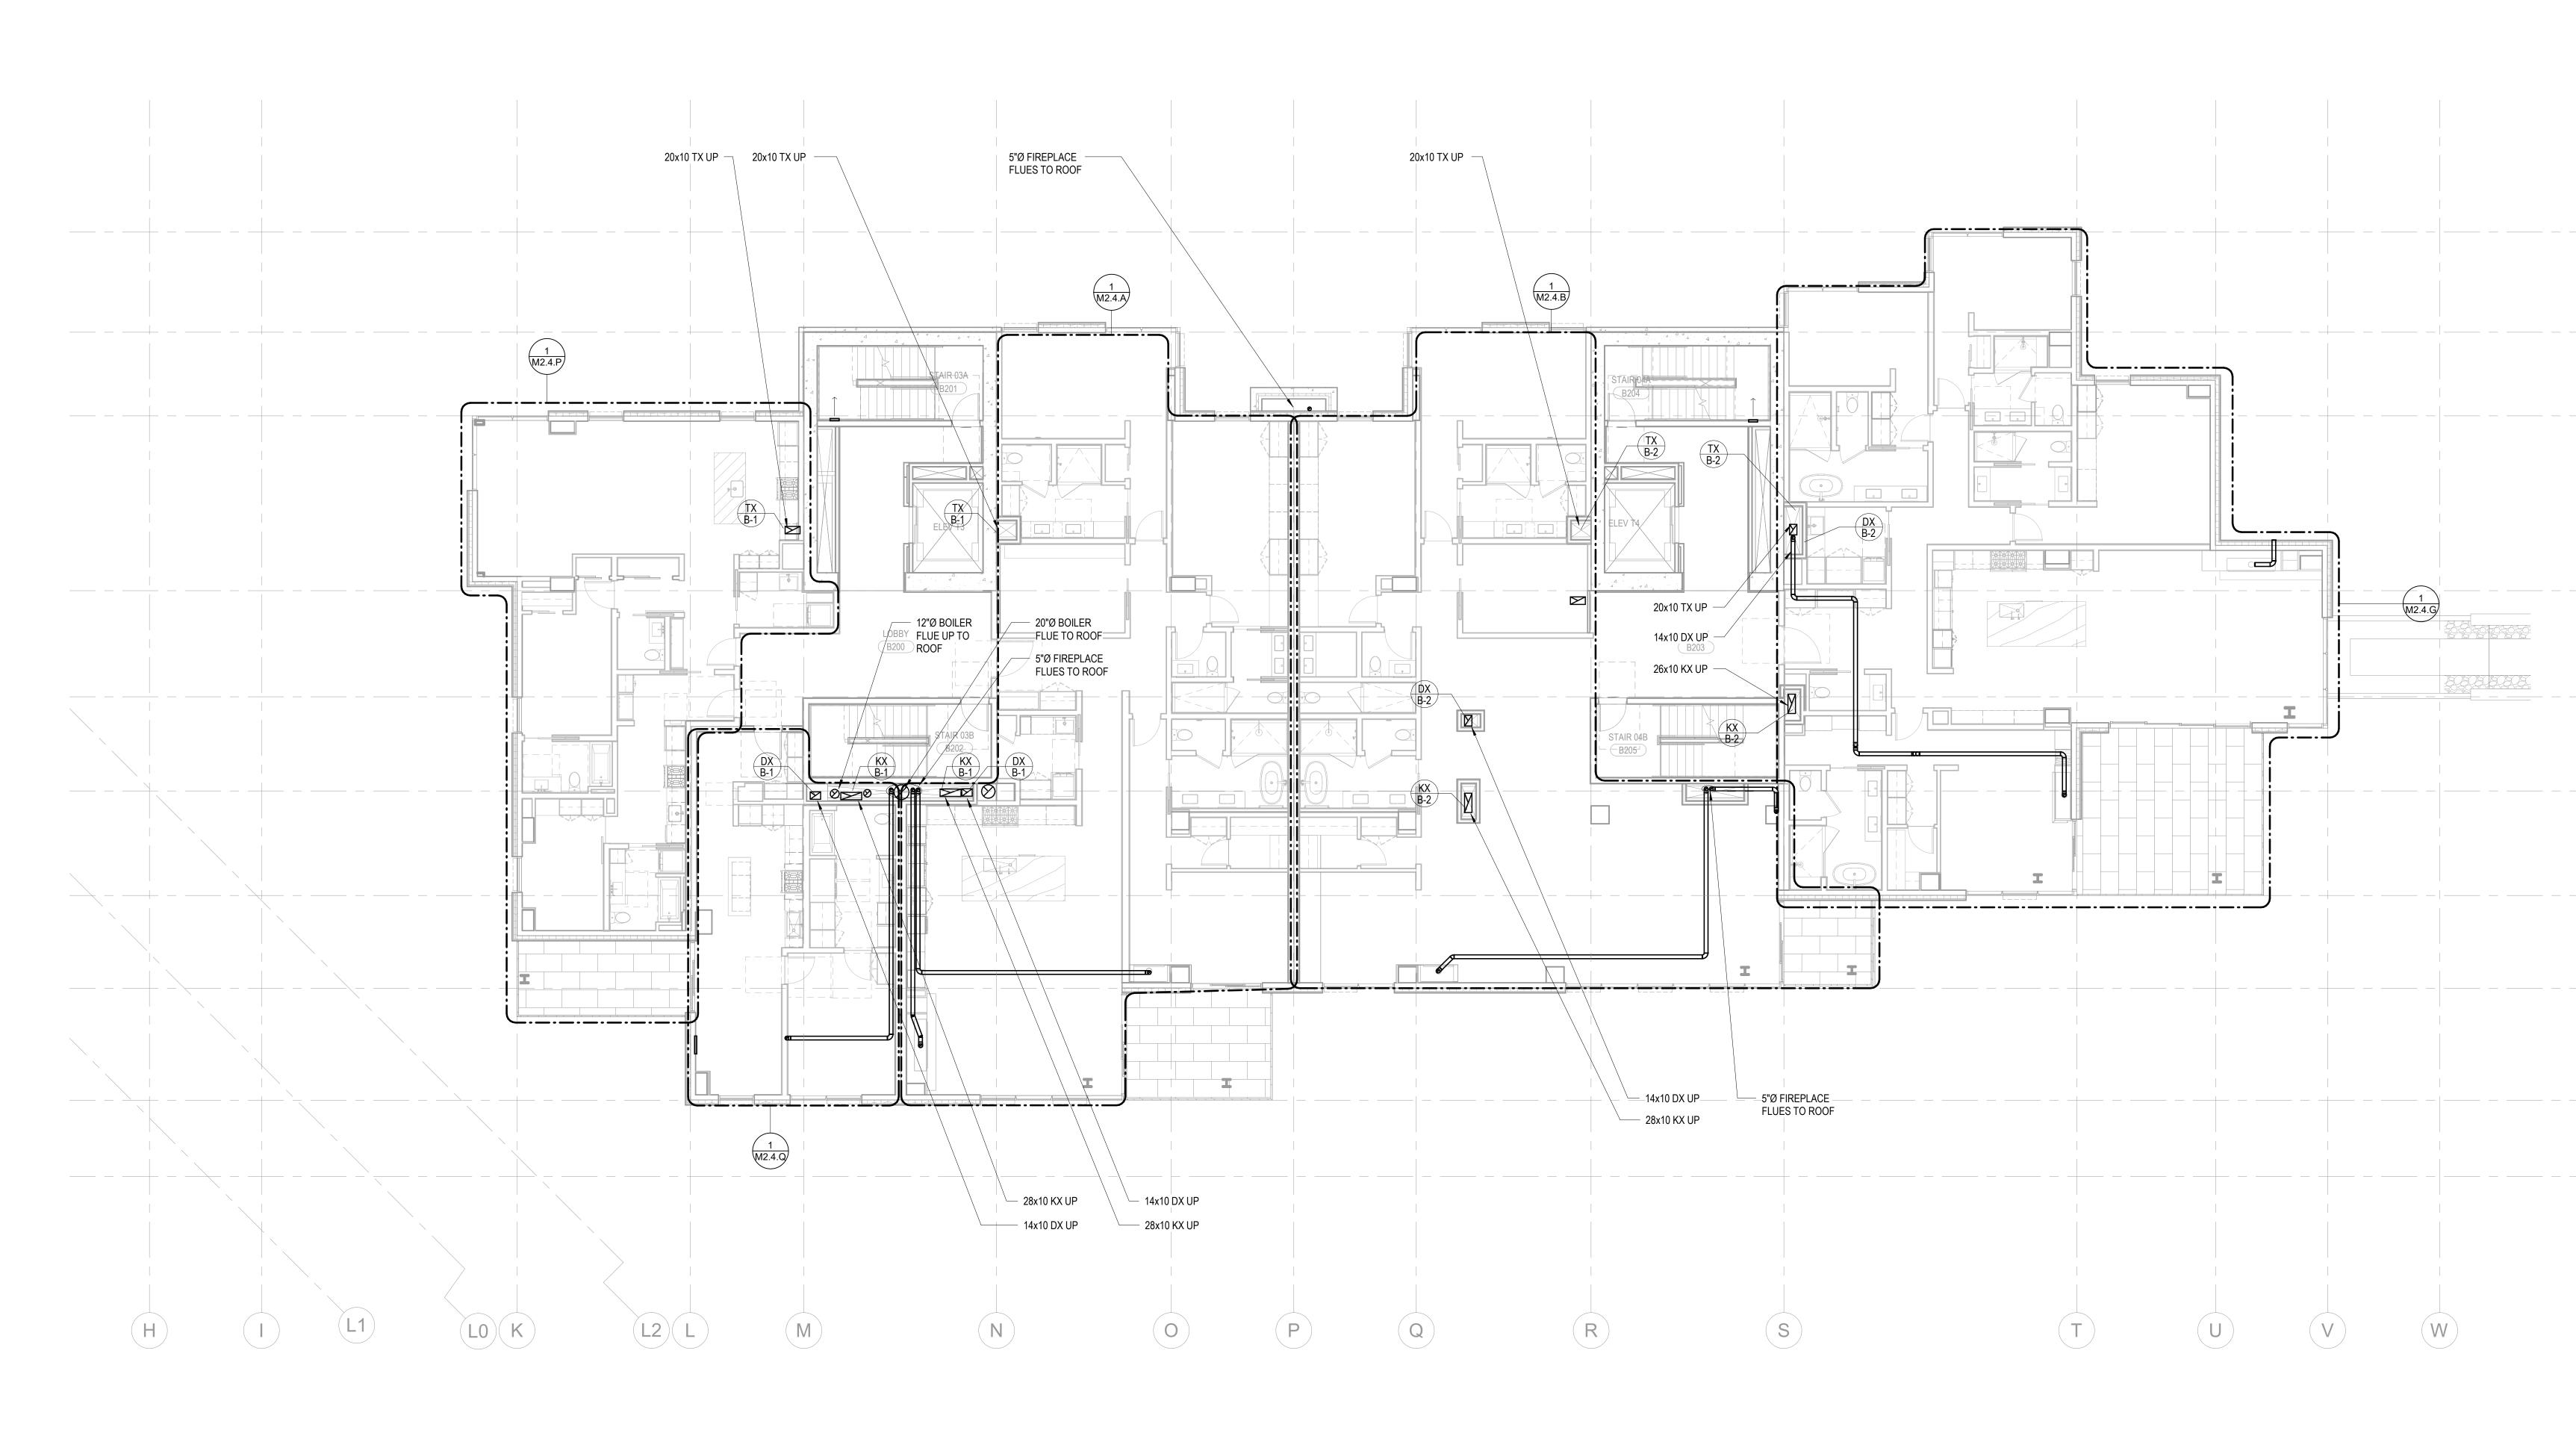


# 1 TOWER B - LEVEL 2 MECHANICAL DUCT PLAN SCALE: 1/8" = 1'-0"

# SHEET NOTES:

- A. REFER TO M2.4 SERIES FOR ENLARGED PLANS.
   B. FIREPLACE FLUE ROUTING SHOWN FOR REFERENCE. REFER TO ENLARGED UNIT PLANS FOR ROUTING AND SIZING DETAIL.
- C. MECHANICAL EQUIPMENT SHOWN FOR REFERENCE. REFER TO ENLARGED UNIT PLANS FOR DETAIL.
   D. ALL RESIDENTIAL TOILET EXHAUST, DRYER EXHAUST, AND KITCHEN RANGE HOOD EXHAUST TO BE PART OF A SUB-DUCT EXHAUST SYSTEM.

			MATHING CONTRACT	
		OD Kundig seattle, Washington 8104 USA +1 206 624 5670 olsonkundig.com	SOMMET BLANC 9300 Marsac Ave (B2 East Parcel) Park City, Utah 84060	
23		Aspen Group USA, PO Box 980022	ASPEN GROUP Aspen Group USA, LLC PO Box 980022 Park City, Utah 84098	
22		<u>Pool Consultant</u> <b>Cloward H20</b> 2696 N University Ave, Suite 29 Provo, UT 84604	10	
21		Landscape Architect <b>EPG Design</b> 6949 South High Tech Drive, Su Midvale, Utah 84047 <u>Specifications Writer</u> <b>Friday Group</b> 88 Mainelli Road	uite 100	
20		<u>Code Consultant</u> <u>Holmes</u> 600 1st Avenue, Suite 200A Seattle, WA 98104		
20		Fire Protection Engineer Jensen Hughes	<u>Fire Protection Engineer</u> <b>Jensen Hughes</b> One Research Drive, Suite 305C	
19		Lerch Bates 19515 North Creek Parkway, Su Bothell, WA 98011	19515 North Creek Parkway, Suite 304 Bothell, WA 98011	
18		Magnusson Klemencic Associ 1301 5th Ave, Suite 3200 Seattle, WA 98101 Lighting Designer	Seattle, WA 98101 Lighting Designer	
		O- 1319 SE MLK Blvd, Suite 210 Portland, Oregon 97219 Building Envelope Consultant RDH	<b>O-</b> 1319 SE MLK Blvd, Suite 210 Portland, Oregon 97219 Building Envelope Consultant	
17		2101 N 34th St Seattle, WA 98103 Accessibility Consultant Studio Pacifica 2144 Westlake Ave N. Suite F	2101 N 34th St Seattle, WA 98103 Accessibility Consultant	
16		Seattle, WA 98109 <u>MEP Engineer</u> <b>WSP USA</b> 1001 Fourth Ave., Suite 3100 Seattle, WA 98154		
15		principal architect project manager	principal architect	
14		drawn by checked by <u>Checker</u> job no. date 11/18/202		
		revisions:		
		no. date ISSUE FOR CONSTRUCTION 11/18/2022	by	
	0 2' 4' 6' 8' 16'	<sup>24'</sup> TOWER B - LVL 2 MECHANICAL DUC PLAN M2.2B.		

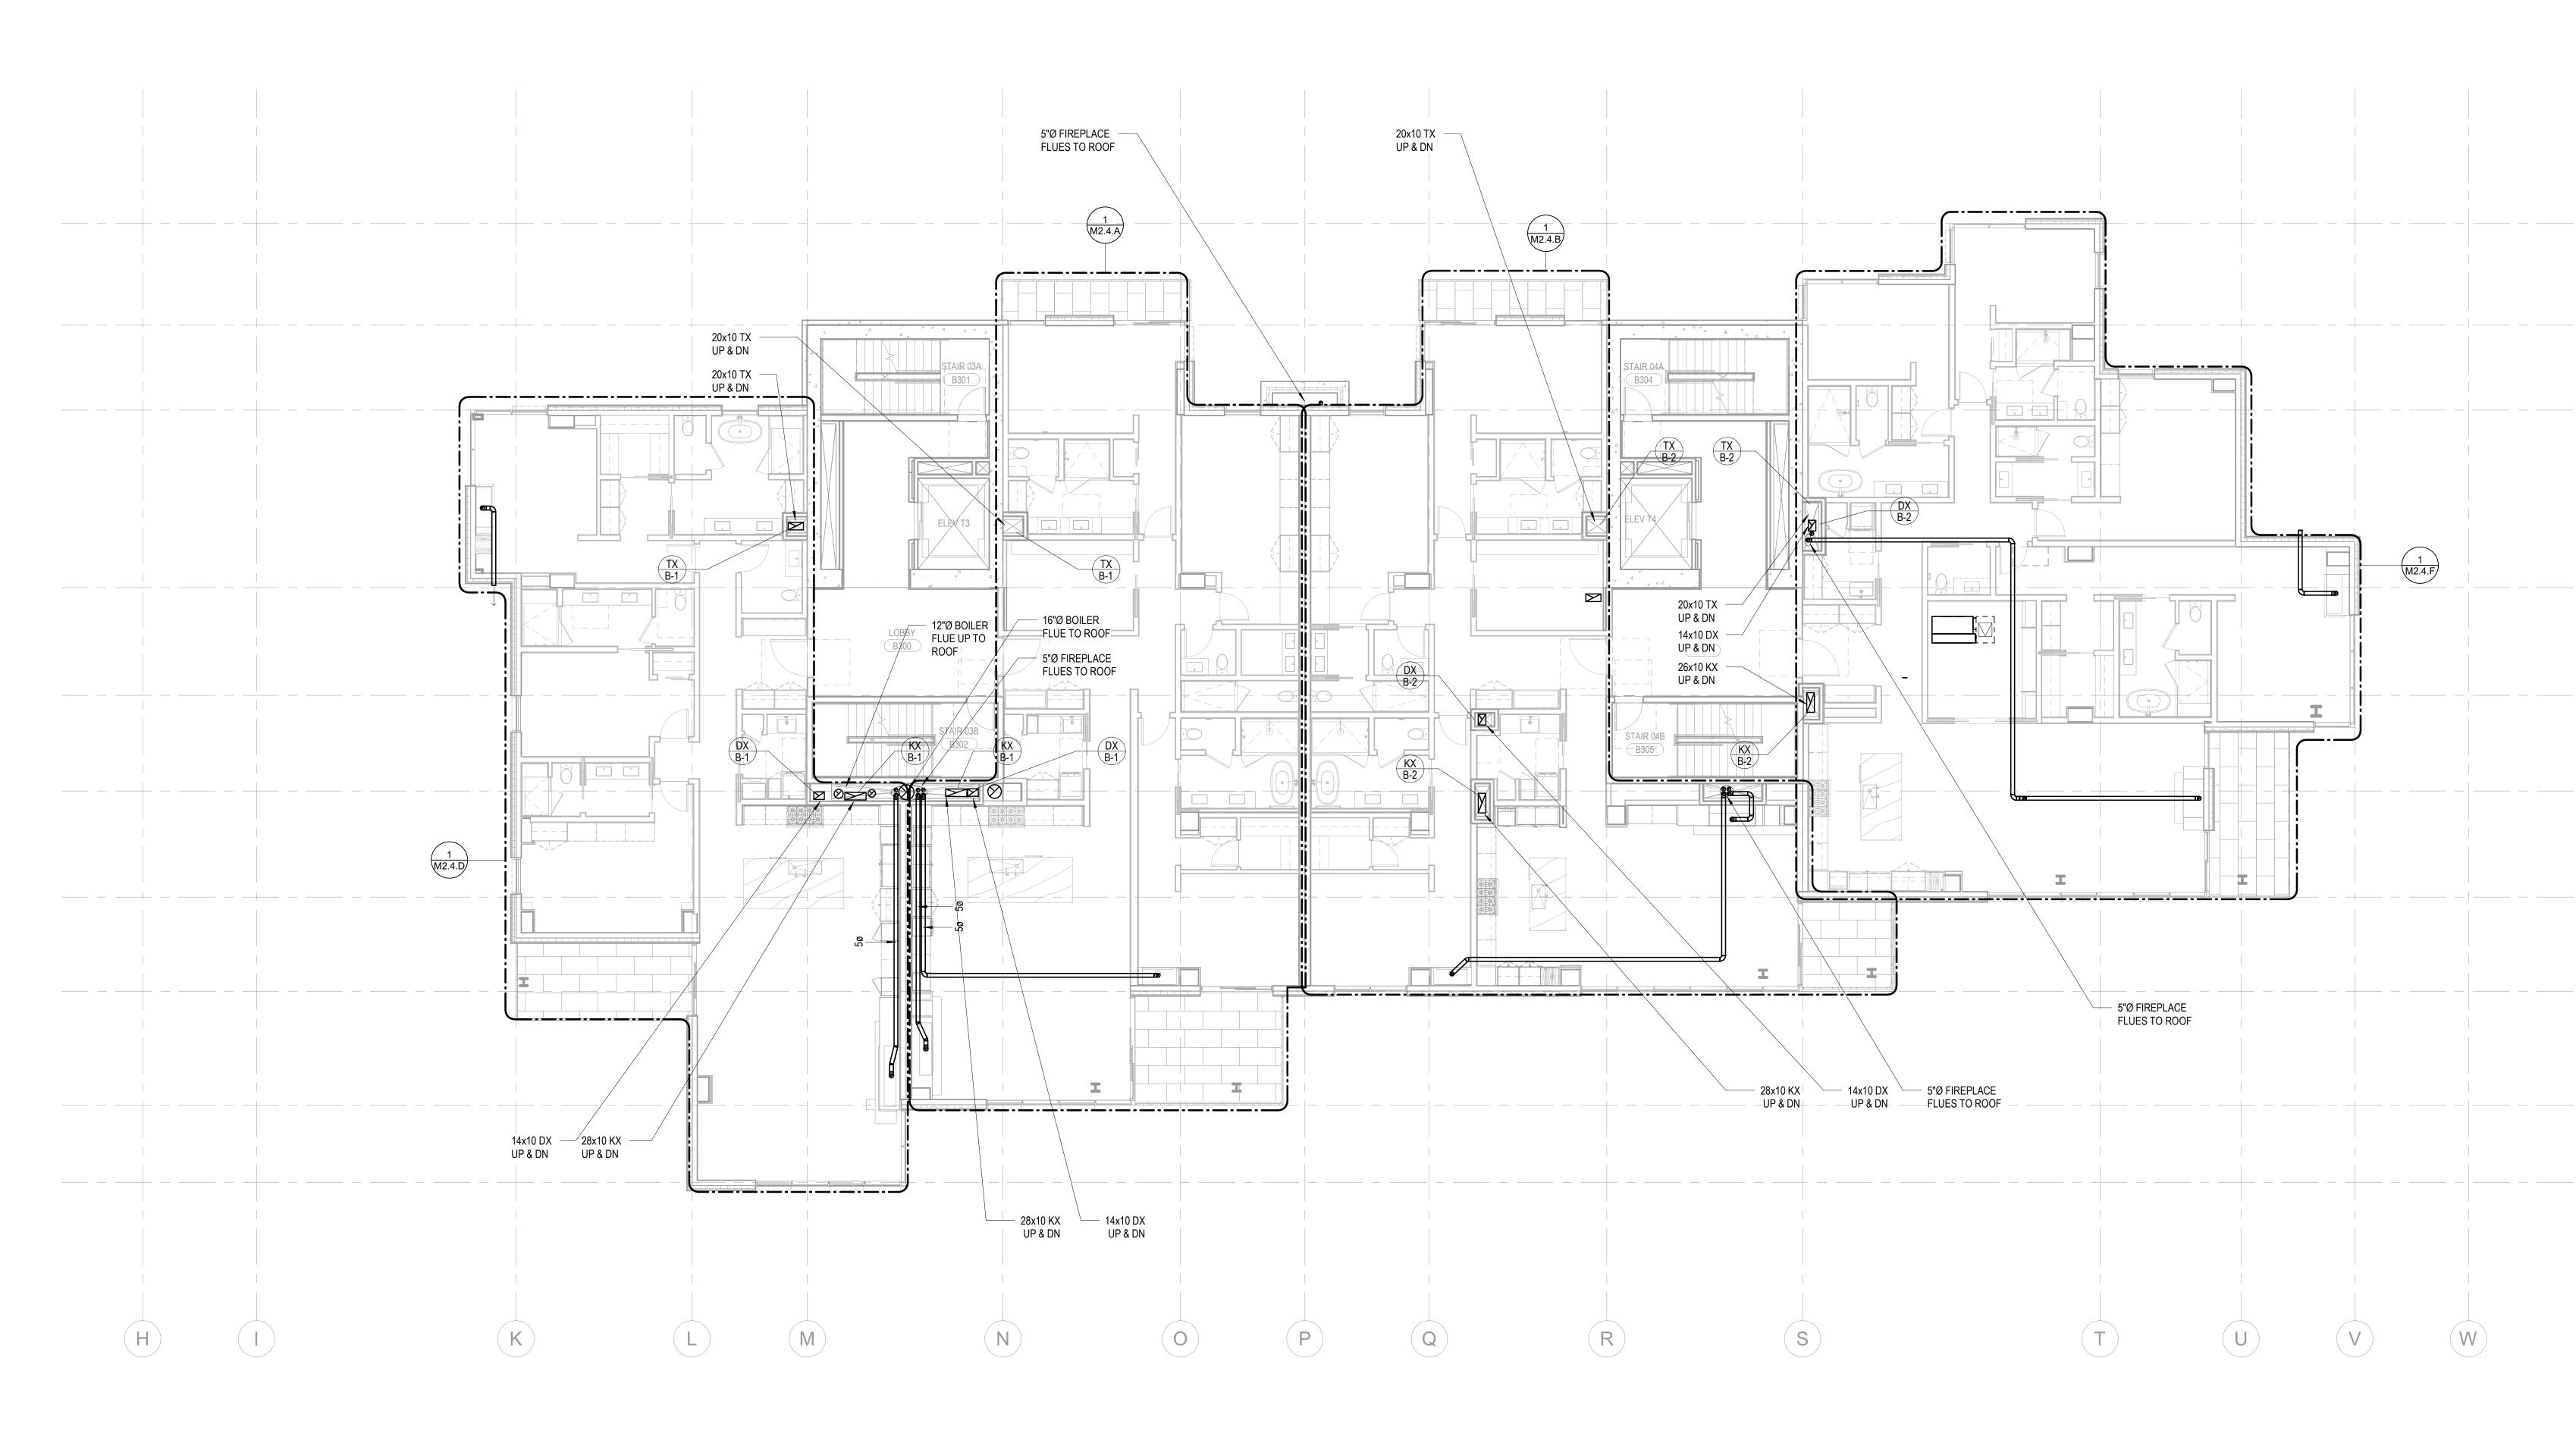

1 TOWER B - LEVEL 3 MECHANICAL DUCT PLAN SCALE: 1/8" = 1'-0"

# SHEET NOTES:

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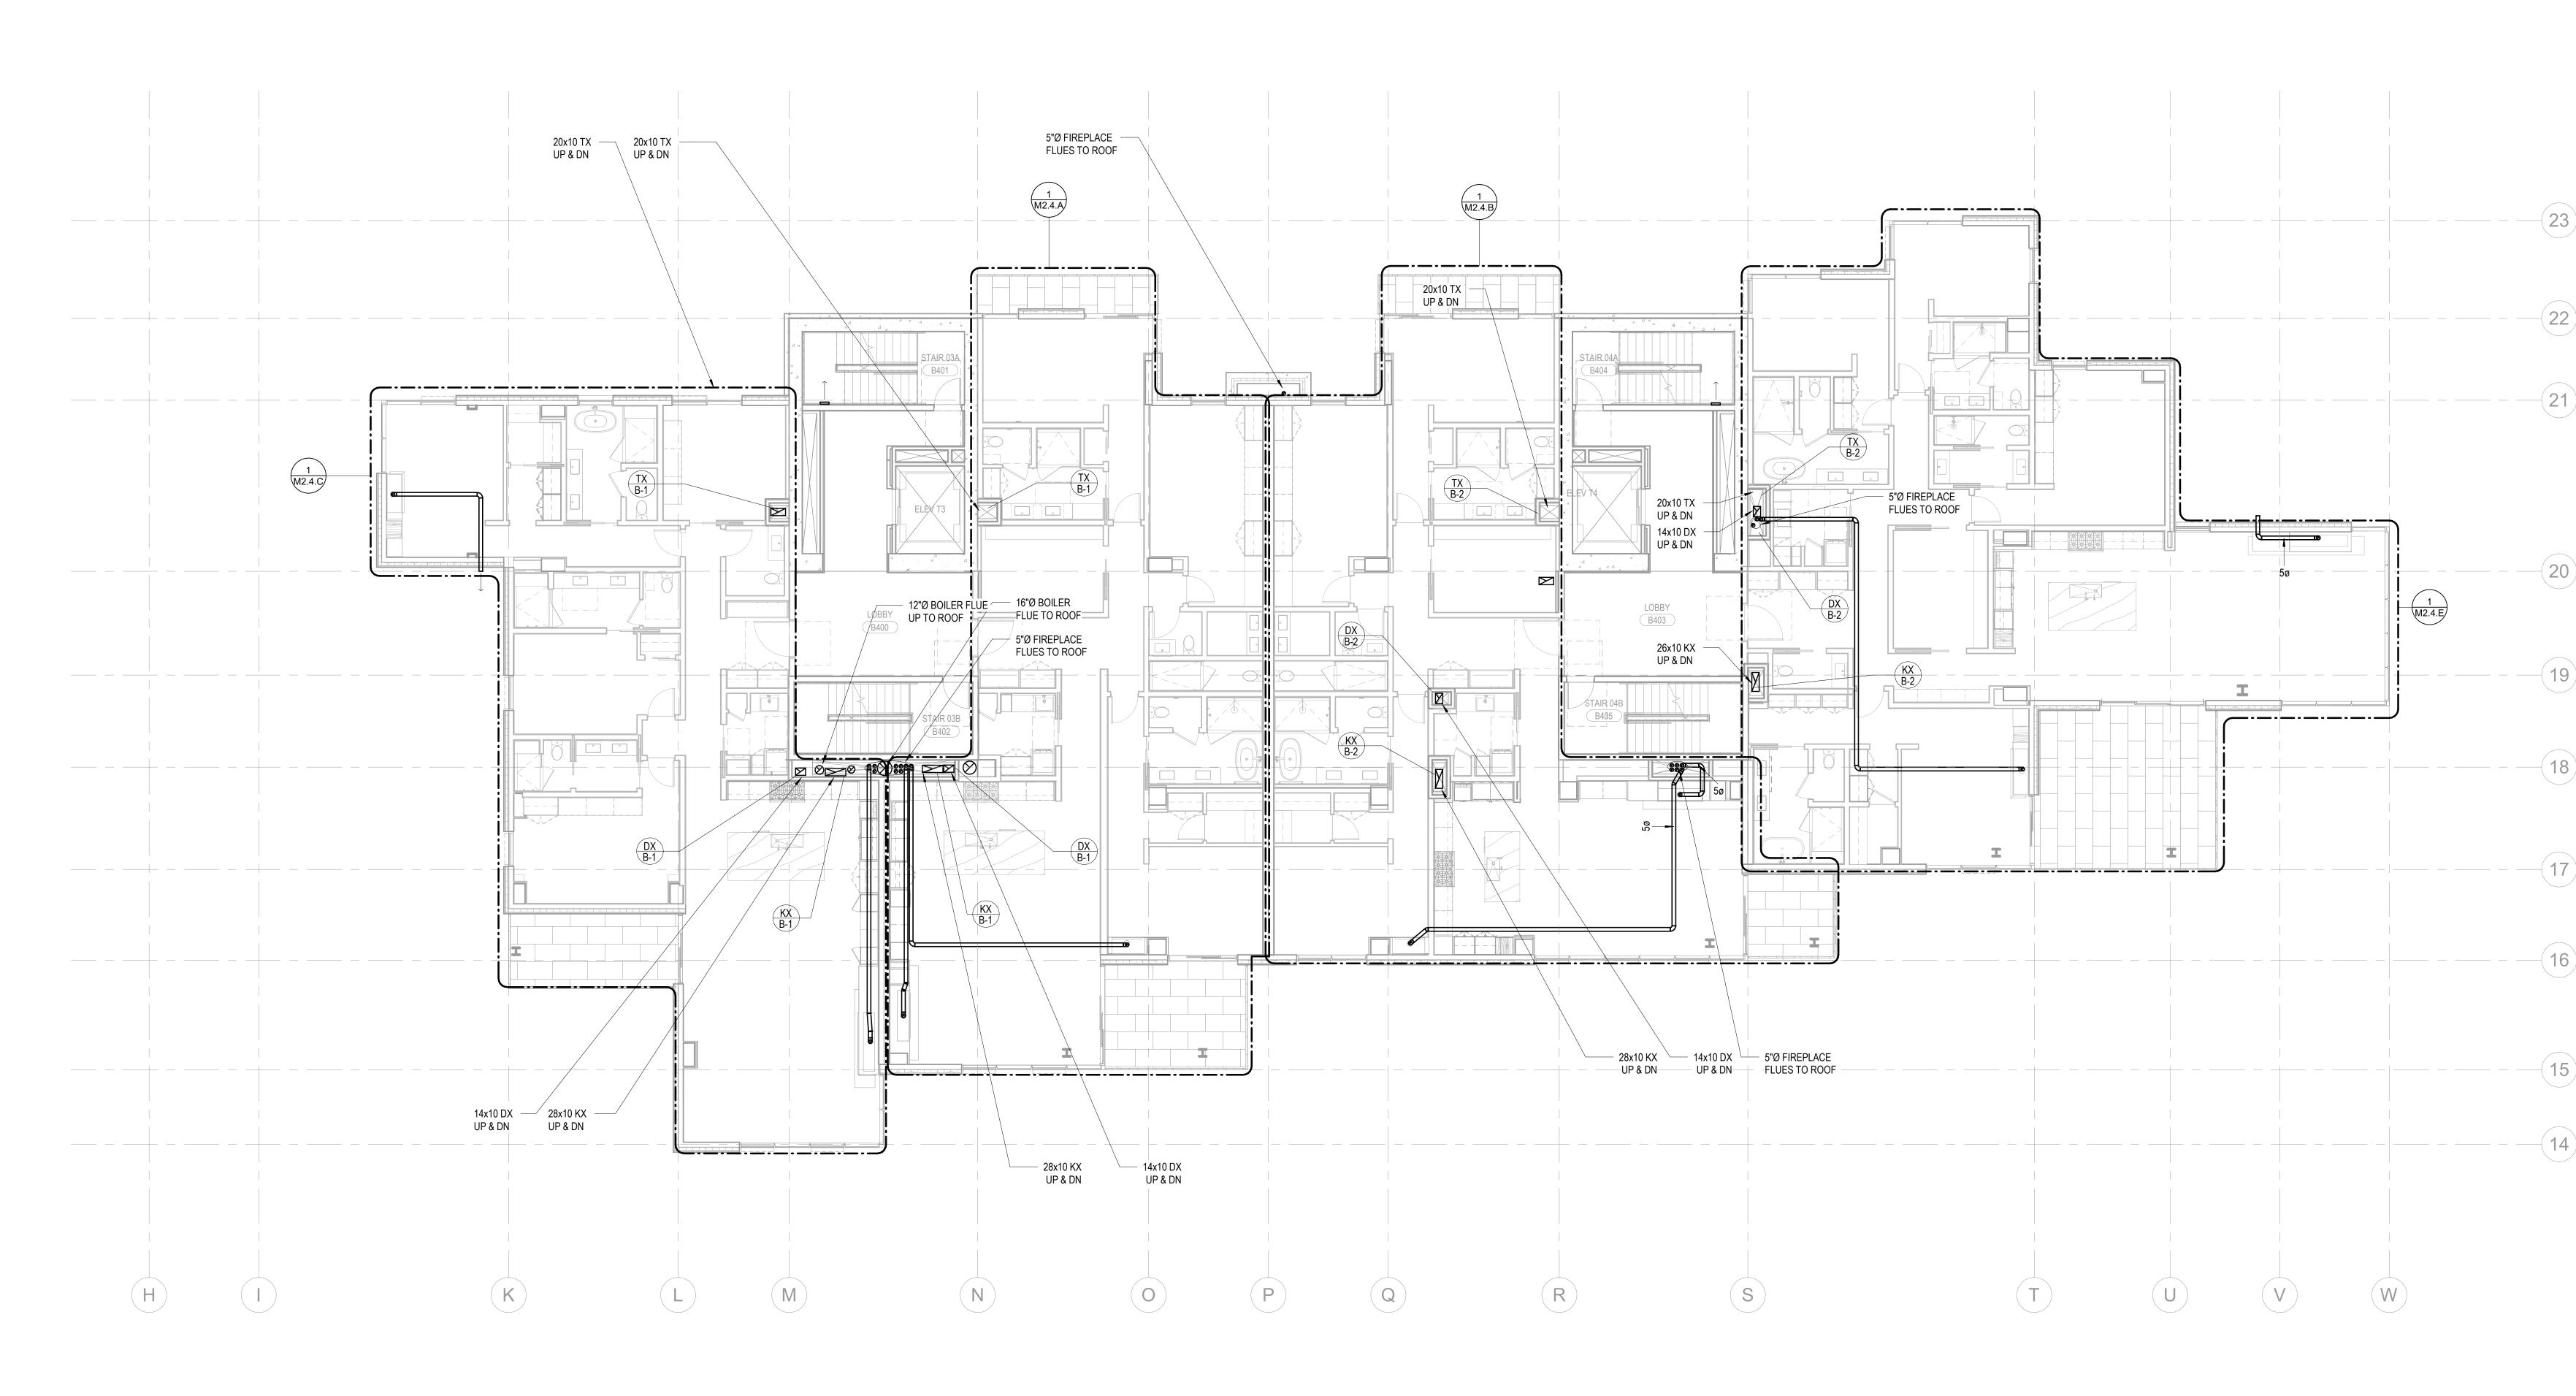
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   D. ALL RESIDENTIAL TOILET EXHAUST, DRYER EXHAUST, AND KITCHEN RANGE HOOD EXHAUST TO BE PART OF A SUB-DUCT EXHAUST SYSTEM.

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Olsouth Jackson St, Suite 600 Seattle, Washington 98104 USA +1 206 624 5670 olsonkundig.com	project: <b>SOMMET BLANC</b> 9300 Marsac Ave (B2 East Parcel) Park City, Utah 84060
ASPEN GROUP Aspen Group USA, LLC PO Box 980022 Park City, Utah 84098	
- checked by _ job no.	Drive, Suite 100
no. date	JCTION 2022 /L 3 DUCT

# 1 TOWER B - LEVEL 4 MECHANICAL DUCT PLAN SCALE: 1/8" = 1'-0"



# **SHEET NOTES:**

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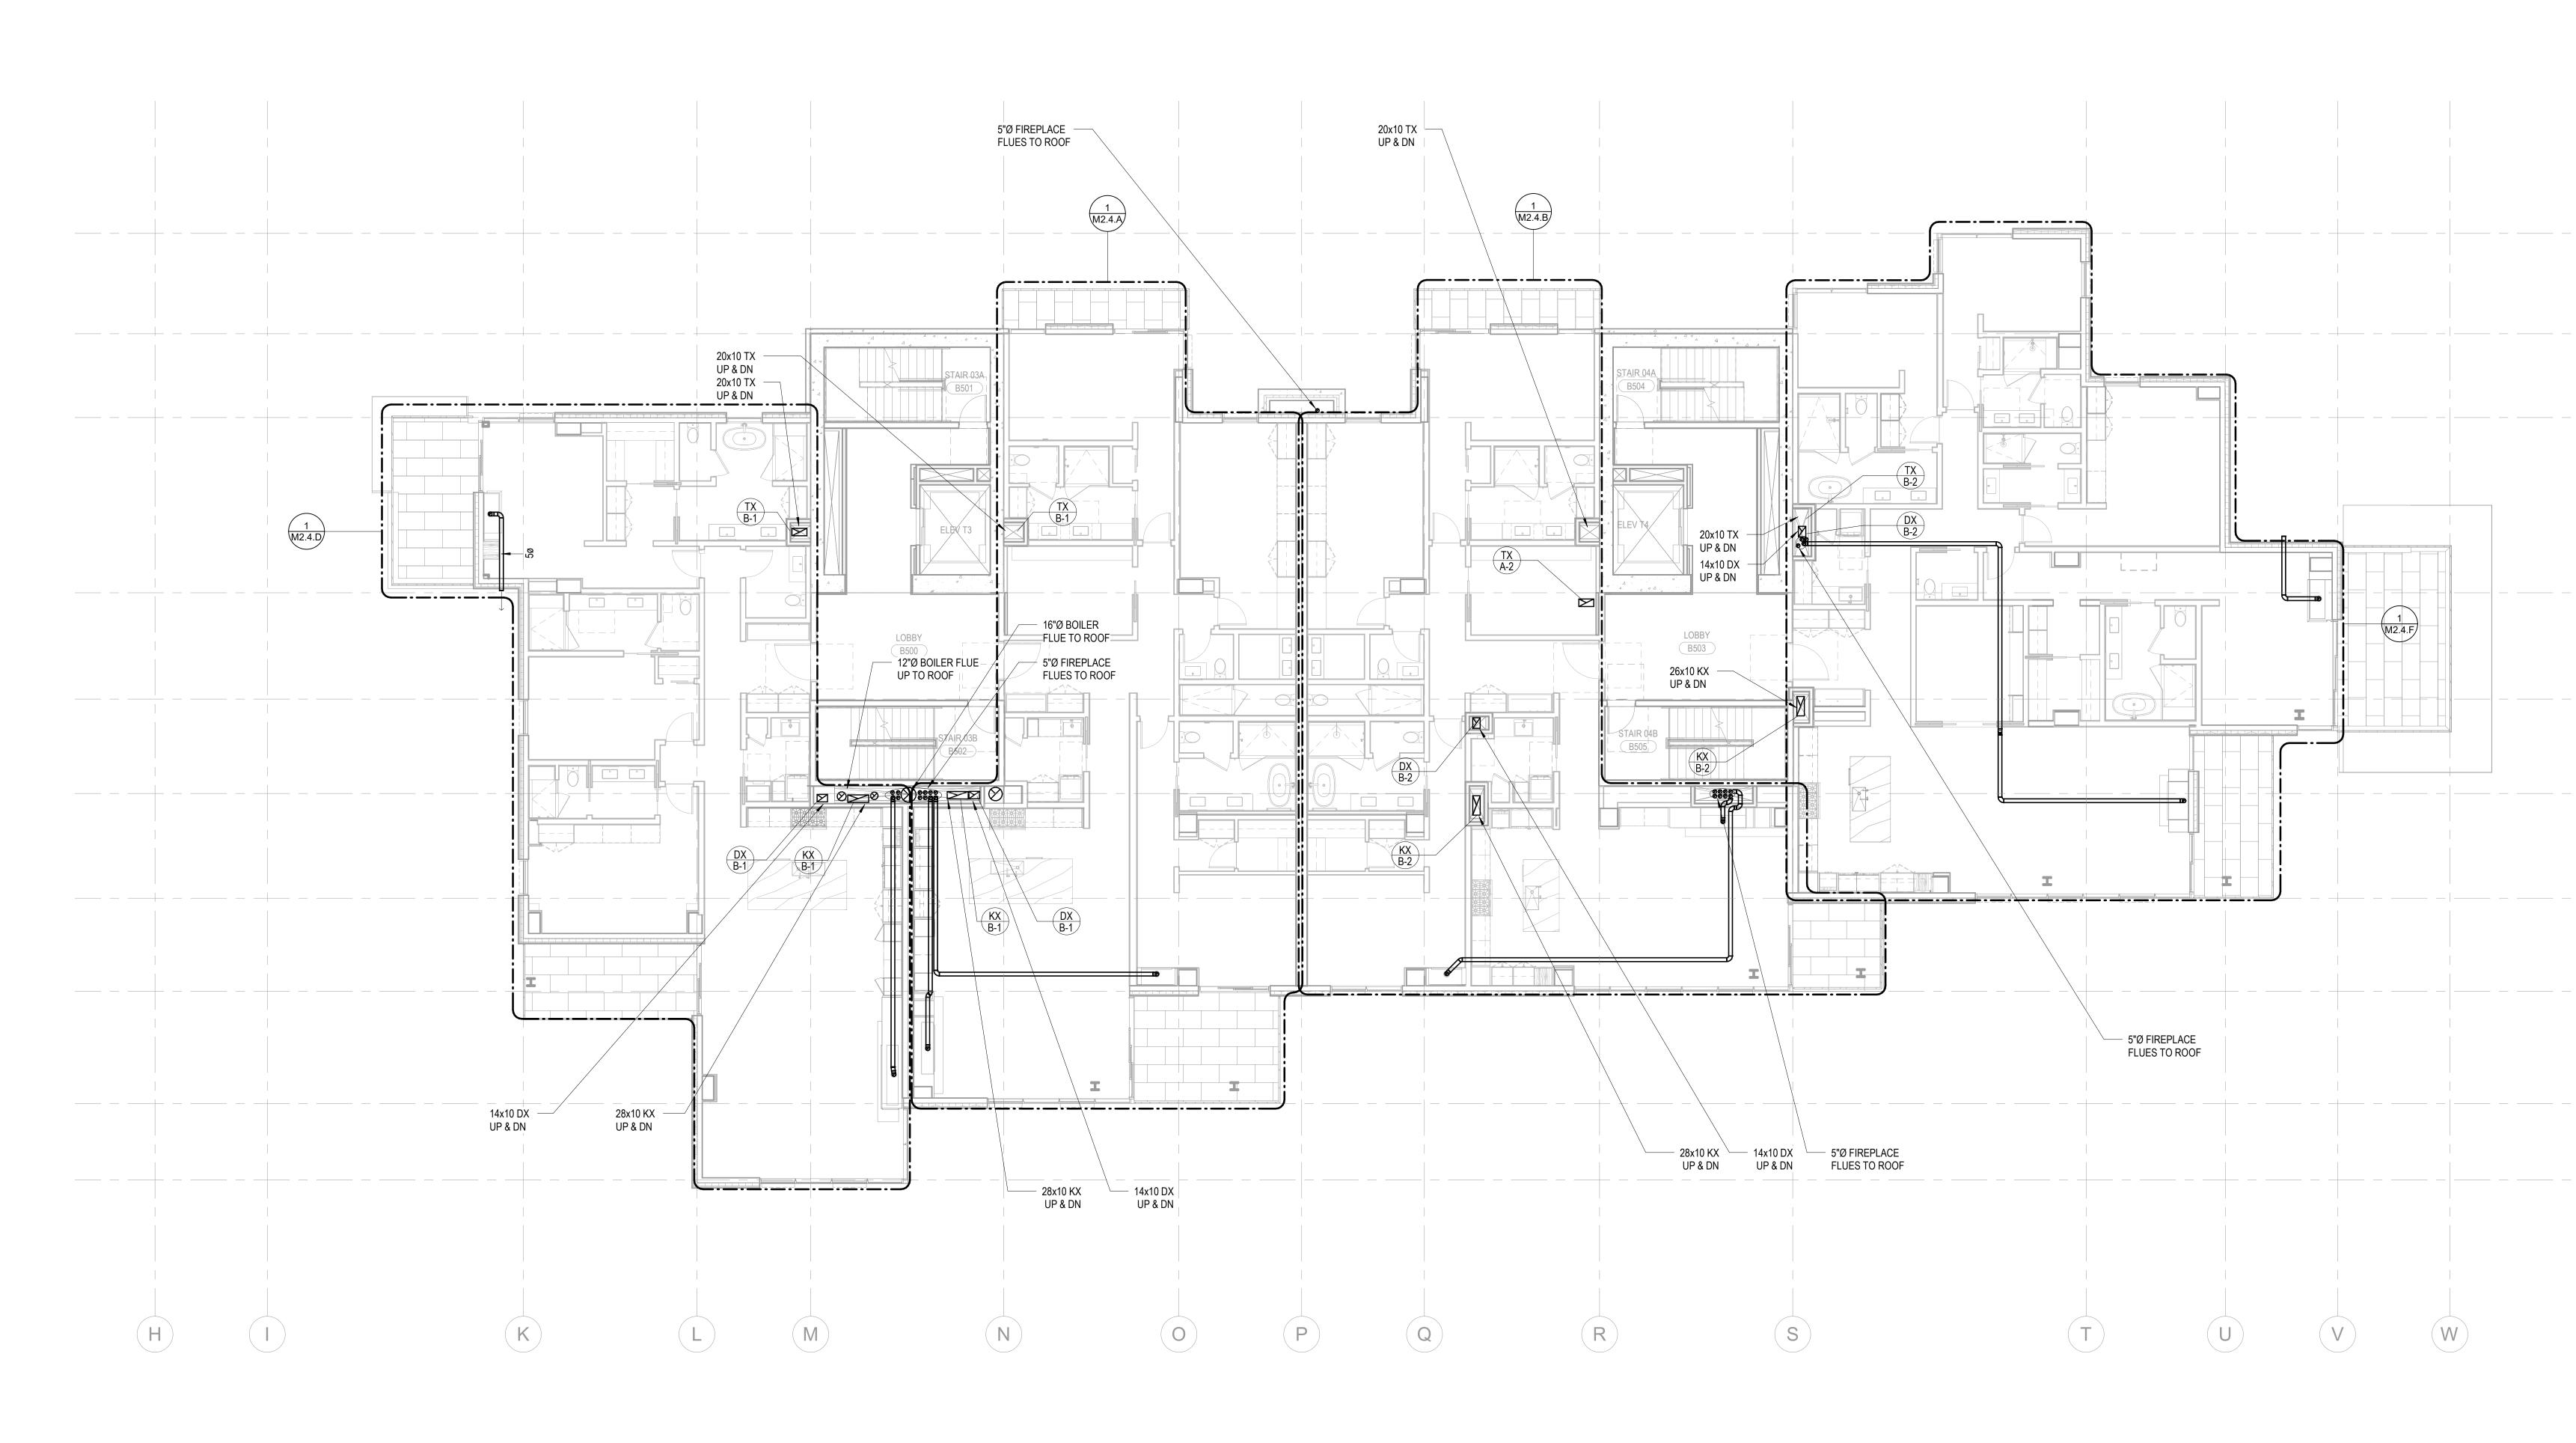
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	No. 12196777 222728 . MATTHE WILLIAM MGSINE	
Olson Kundig 159 South Jackson St, Suite 600 Seattle, Washington 98104 USA +1 206 624 5670 olsonkundig.com	project: <b>SOMMET BLANC</b> 9300 Marsac Ave (B2 East Parcel) Park City, Utah 84060	
ASPEN GROUP Aspen Group USA, LLC PO Box 980022 Park City, Utah 84098		
- checked by job no.	Drive, Suite 100 200A er Suite 305C 81 Consulatant rkway, Suite 304 ic Associates 00 sultant it Suite F e 3100	
no. date	UCTION 2022 VL 4 . DUCT	



1 TOWER B - LEVEL 5 MECHANICAL DUCT PLAN SCALE: 1/8" = 1'-0"

# SHEET NOTES:

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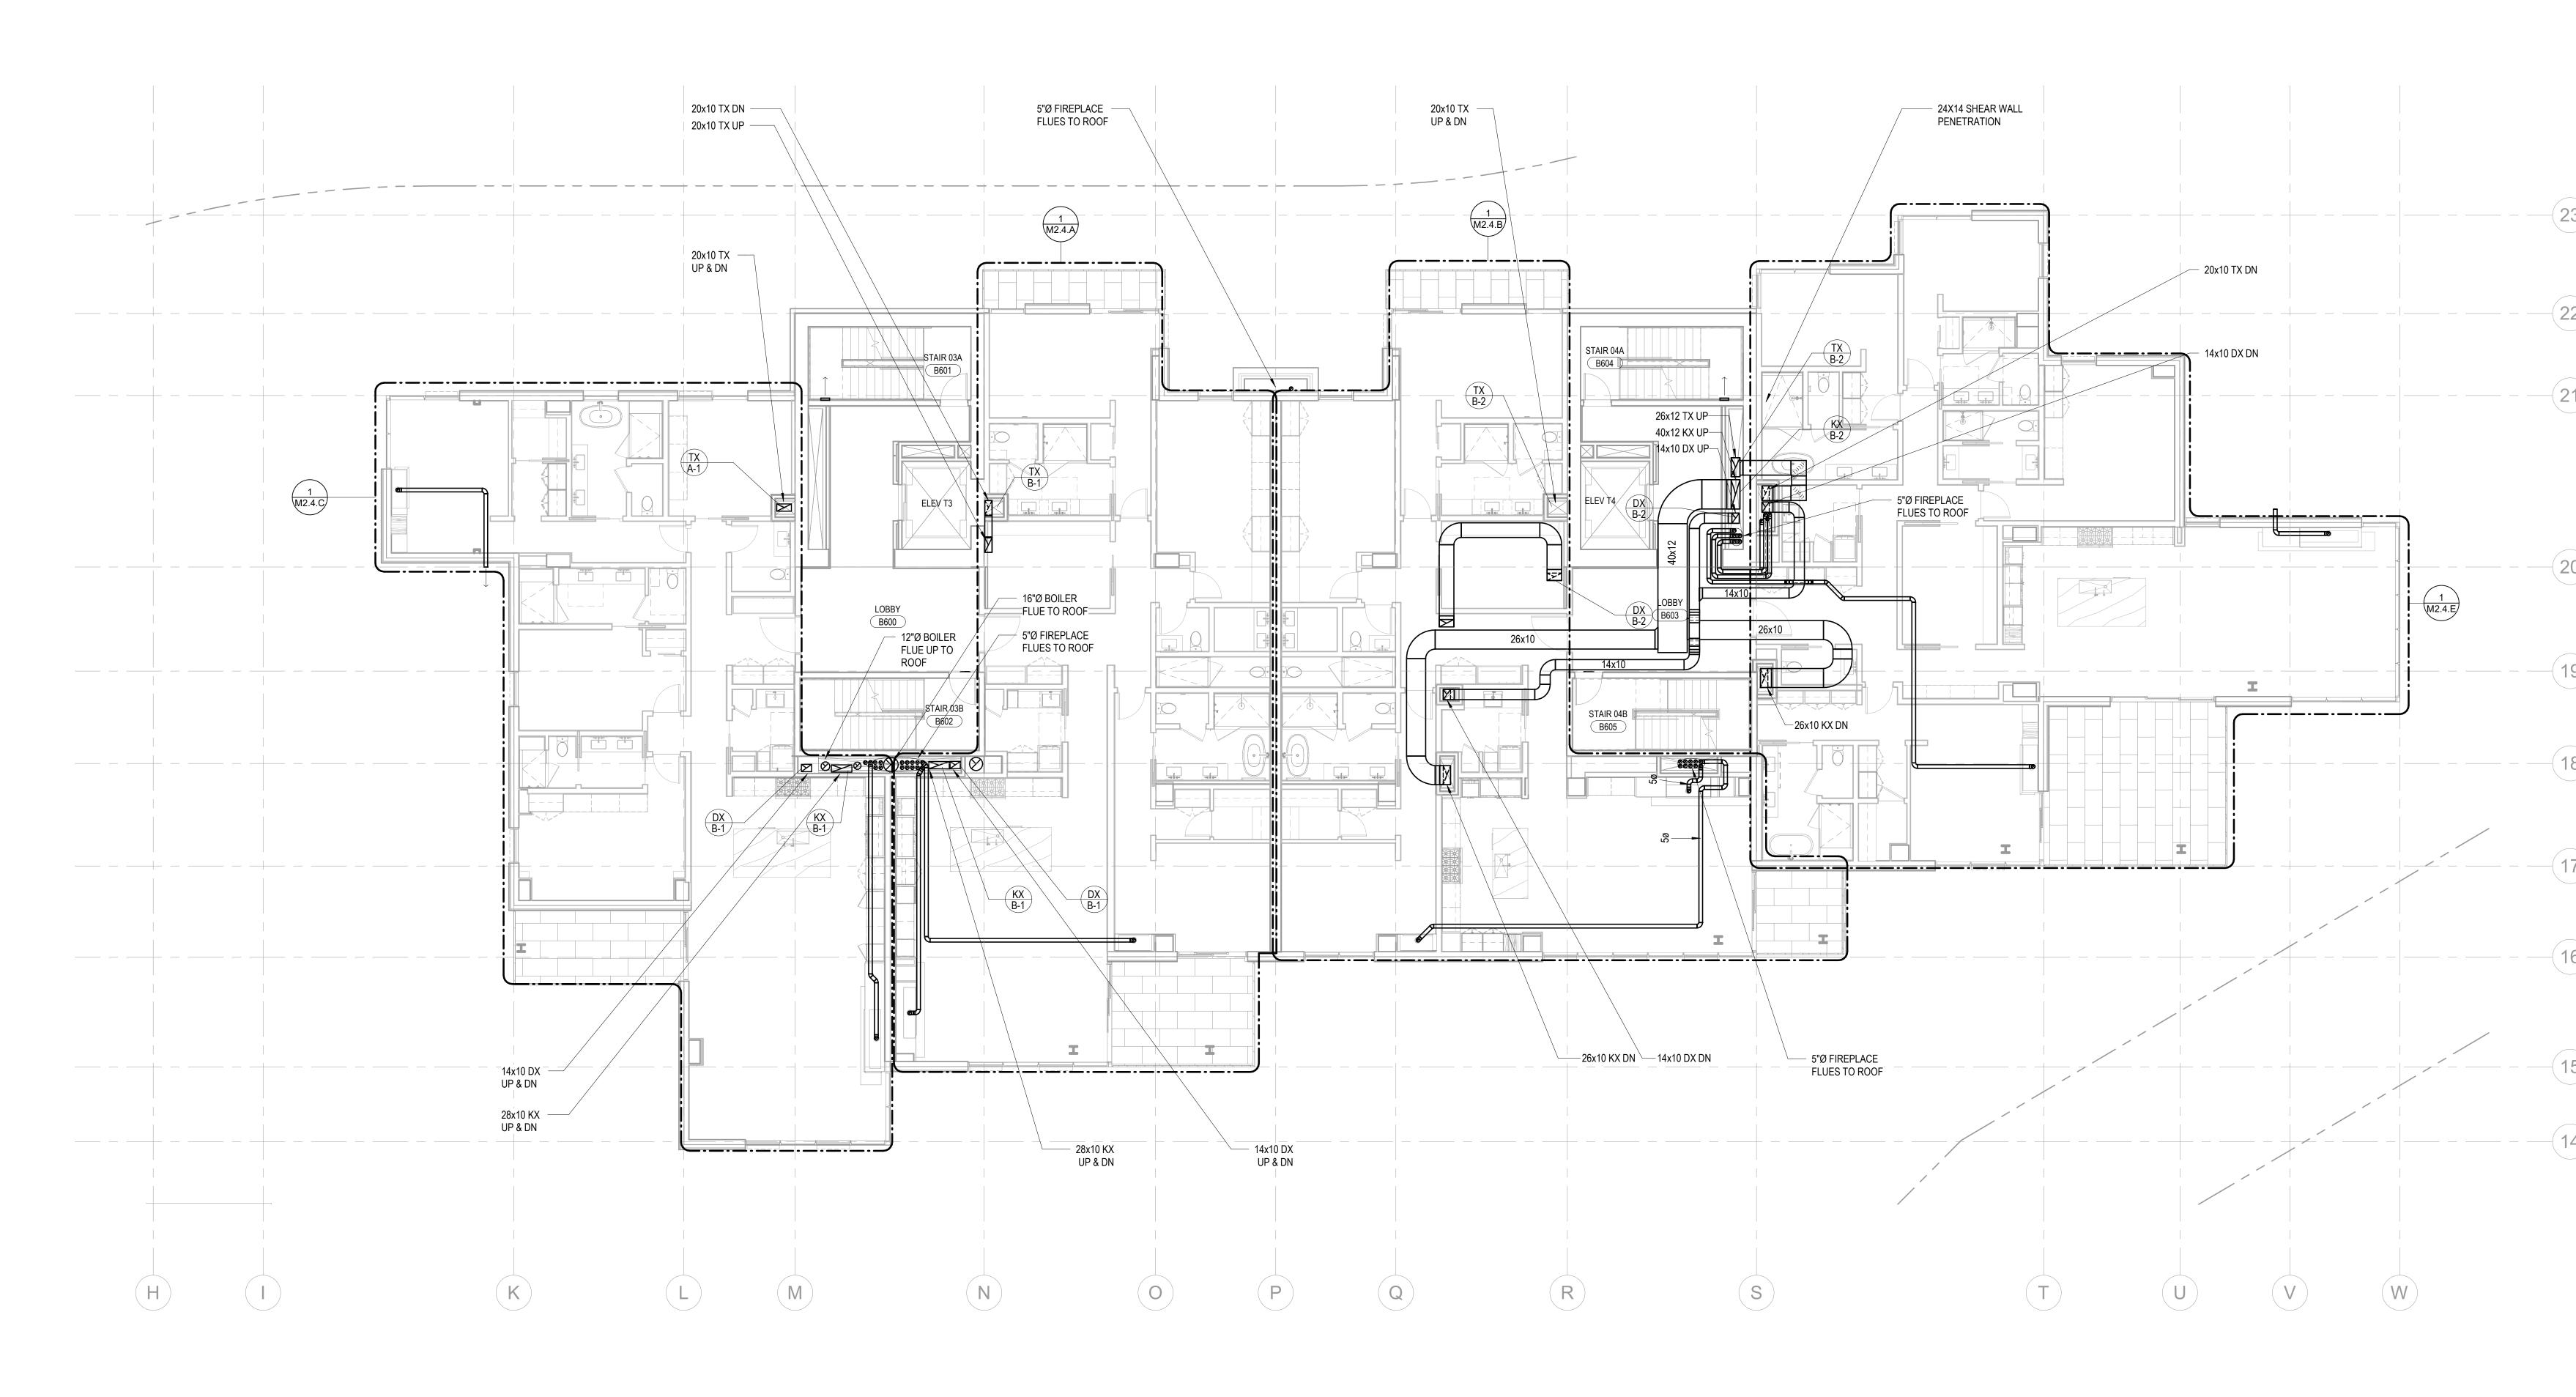
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Olson Kundig seatte, Washington 98104 USA +1 206 624 5670 olsonkundig.com	project: SOMMET BLANC 9300 Marsac Ave (B2 East Parcel) Park City, Utah 84060	
ASPER Aspen Group U PO Box 98 Park City, Uta	0022	
Pool Consultant Cloward H20 26969 University Ave, S Provo, UT 84604         Landscape Architect EPG Design 6949 South High Tech Dr Midvale, Utah 84047         Specifications Writer Friday Group 88 Mainelli Road Middlebury, VT         Code Consultant Holmes 600 1st Avenue, Suite 20 Seattle, WA 98104         Fire Protection Engineer Jensen Hughes One Research Drive, Suit Westborough, MA 01581         Vertical Transportation Cr Lerch Bates 19515 North Creek Parkw Bothell, WA 98011         Structural Engineer Magnusson Klemencic J 1301 5th Ave, Suite 3200 Seattle, WA 98101         Lighting Designer O- 1319 SE MLK Blvd, Suite Portland, Oregon 97219         Building Envelope Consu RDH 2101 N 34th St Seattle, WA 98103         Accessibility Consultant Studio Pacifica 2144 Westlake Ave N, Su Seattle, WA 98109         MEP Engineer WSP USA 1001 Fourth Ave., Suite 3 Seattle, WA 98154         principal architect project manager drawn by checked by _C job no. date1	ive, Suite 100 0A te 305C <u>onsulatant</u> vay, Suite 304 <b>Associates</b> 210 ttant ite F 100	
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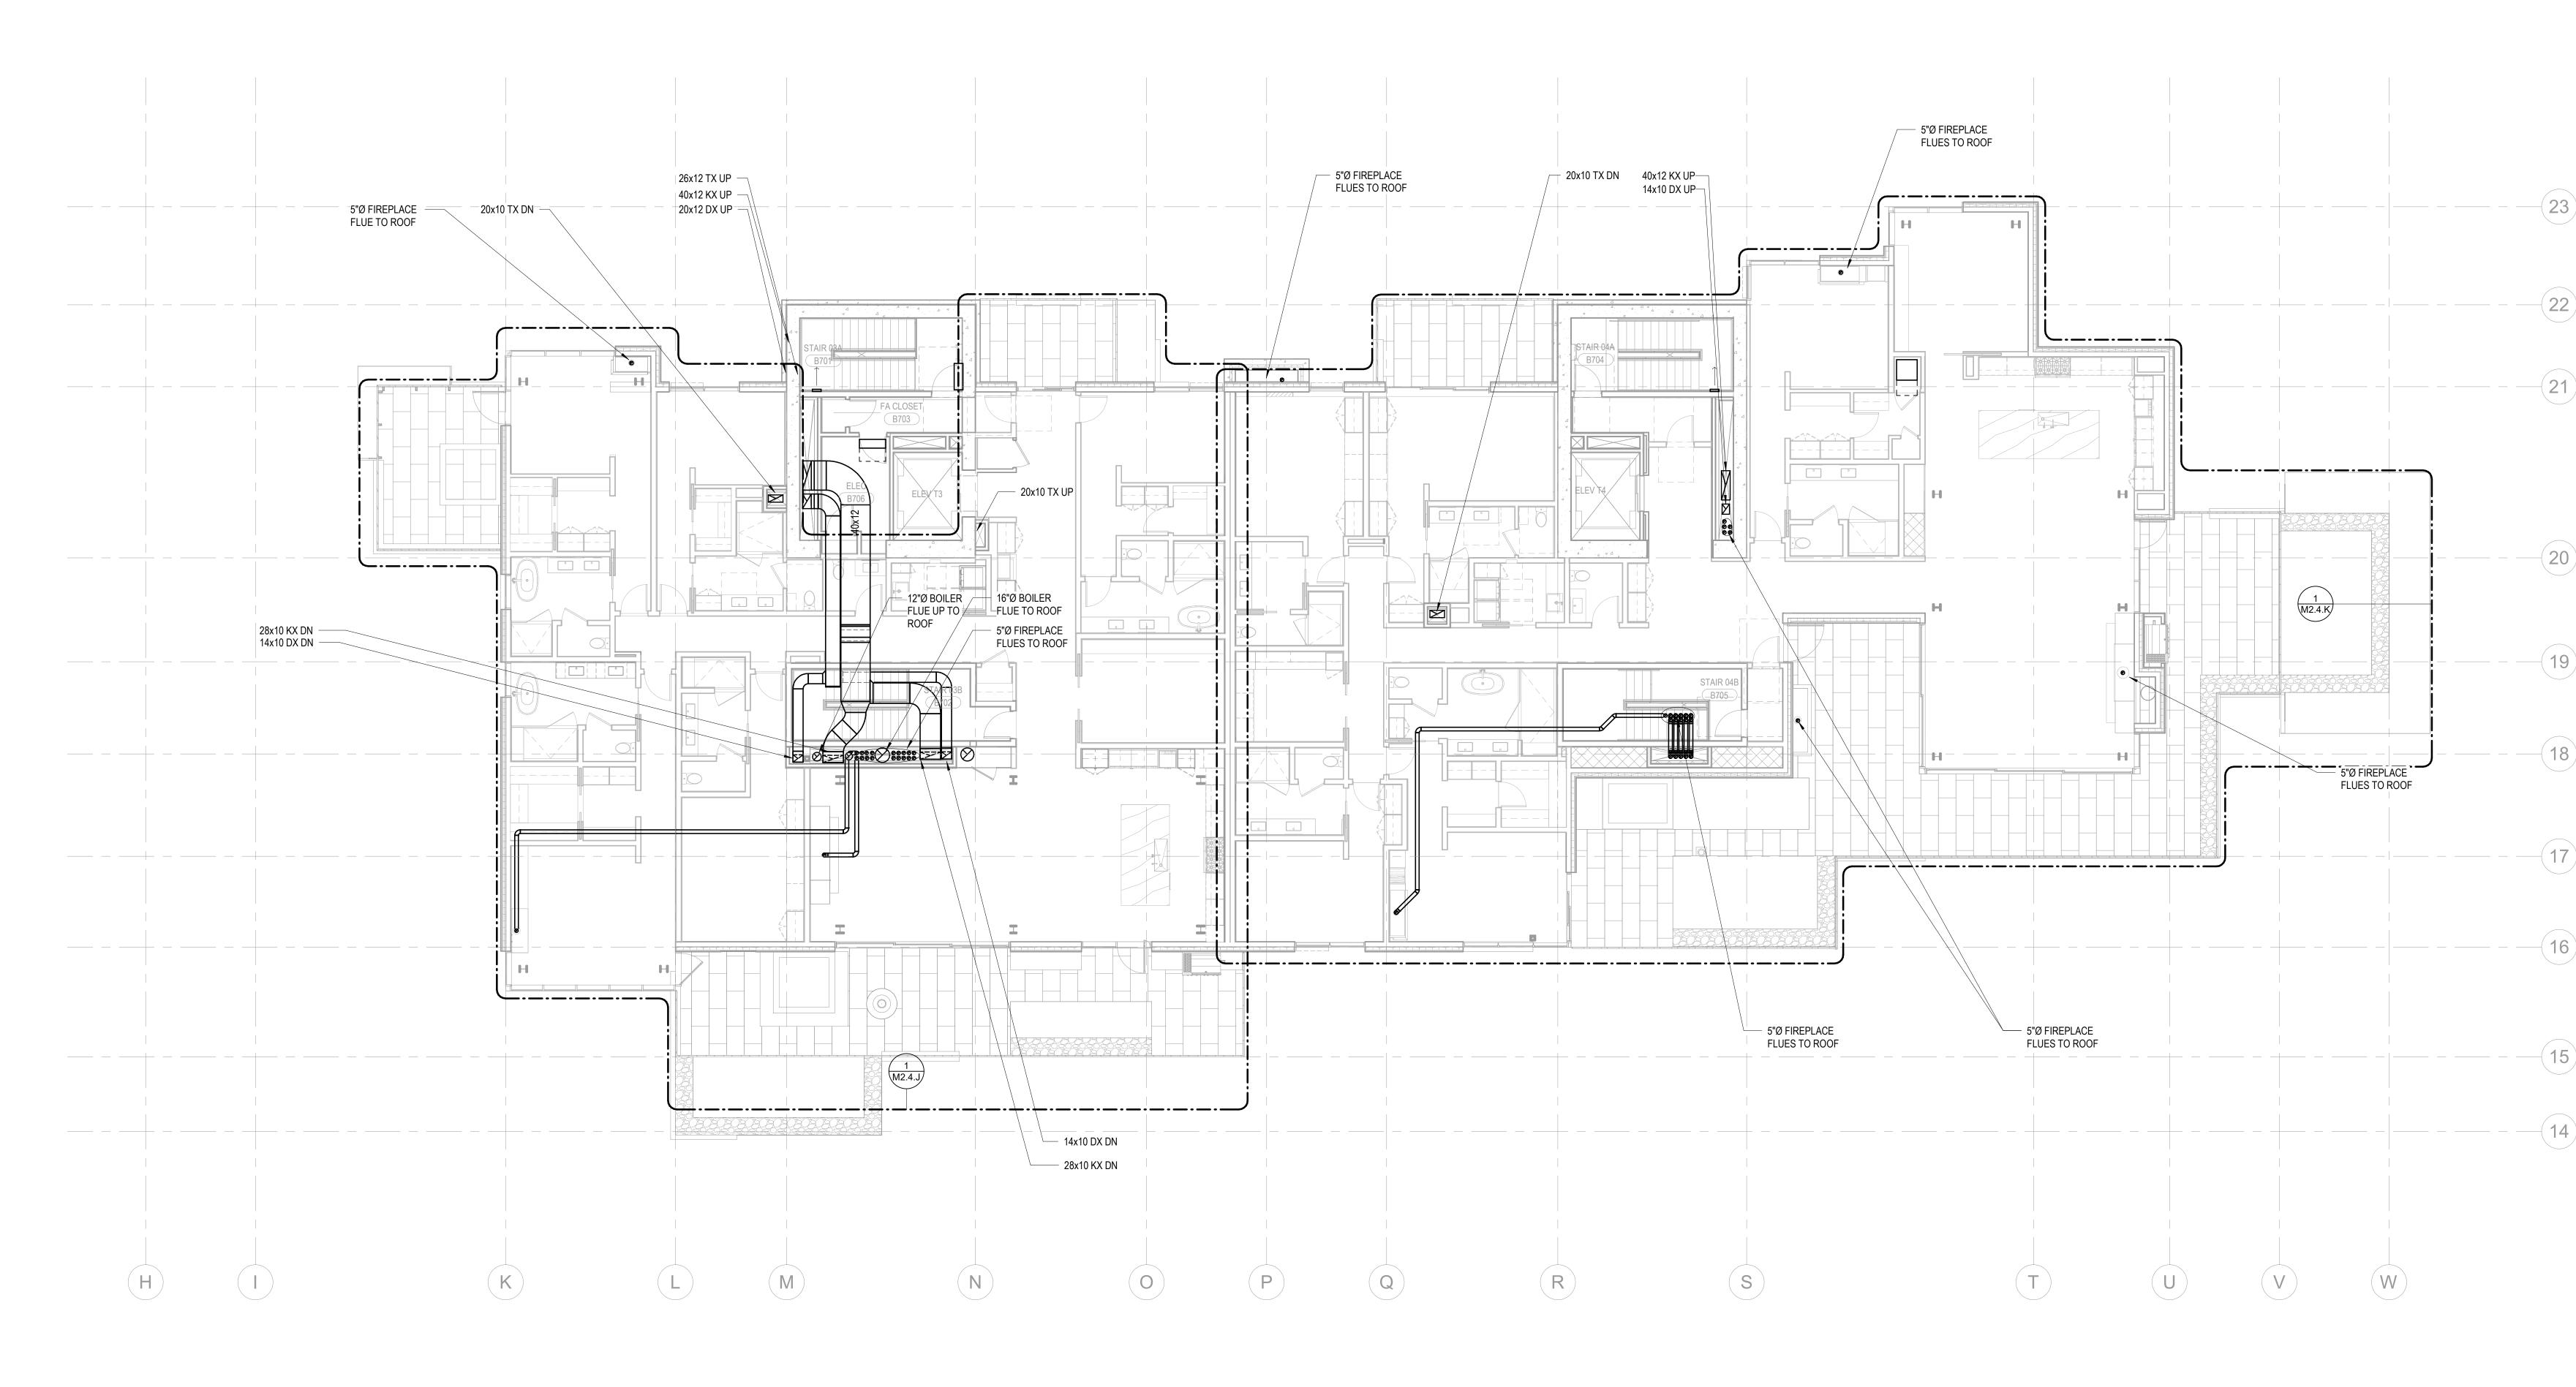


1 TOWER B - LEVEL 6 MECHANICAL DUCT PLAN SCALE: 1/8" = 1'-0"

# SHEET NOTES:

- A. REFER TO M2.4 SERIES FOR ENLARGED PLANS.
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	ASPE Aspen Group PO Box Park City, U	<b>IN GROUP</b> <b>USA, LLC</b> 980022 Itah 84098
-23		
- 22	Pool Consultant Cloward H20	
21	2696 N University Ave Provo, UT 84604 <u>Landscape Architect</u> <b>EPG Design</b> 6949 South High Tech Midvale, Utah 84047 <u>Specifications Writer</u> <b>Friday Group</b> 88 Mainelli Road Middlebury, VT	
20	<u>Code Consultant</u> <b>Holmes</b> 600 1st Avenue, Suite Seattle, WA 98104	
-(19)	Fire Protection Engine Jensen Hughes One Research Drive, S Westborough, MA 015 Vertical Transportation Lerch Bates	Suite 305C 81 <u>Consulatant</u>
	19515 North Creek Pa Bothell, WA 98011 <u>Structural Engineer</u> <b>Magnusson Klemenc</b> 1301 5th Ave, Suite 32	ic Associates
- 18	Seattle, WA 98101 <u>Lighting Designer</u> <b>O-</b> 1319 SE MLK Blvd, Su Portland, Oregon 9721	uite 210 9
-17	<u>Building Envelope Cor</u> <b>RDH</b> 2101 N 34th St Seattle, WA 98103	<u>isultant</u>
-(16)	Accessibility Consultar Studio Pacifica 2144 Westlake Ave N, Seattle, WA 98109	
	MEP Engineer WSP USA 1001 Fourth Ave., Suit Seattle, WA 98154	e 3100
- 15	principal architect project manager drawn by	
-14	job no.	Checker
	no. date	by
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	TOWER B - LY MECHANICAL PLAN M2.2	DUCT



1 TOWER B - LEVEL 7 MECHANICAL DUCT PLAN SCALE: 1/8" = 1'-0"

# **SHEET NOTES:**

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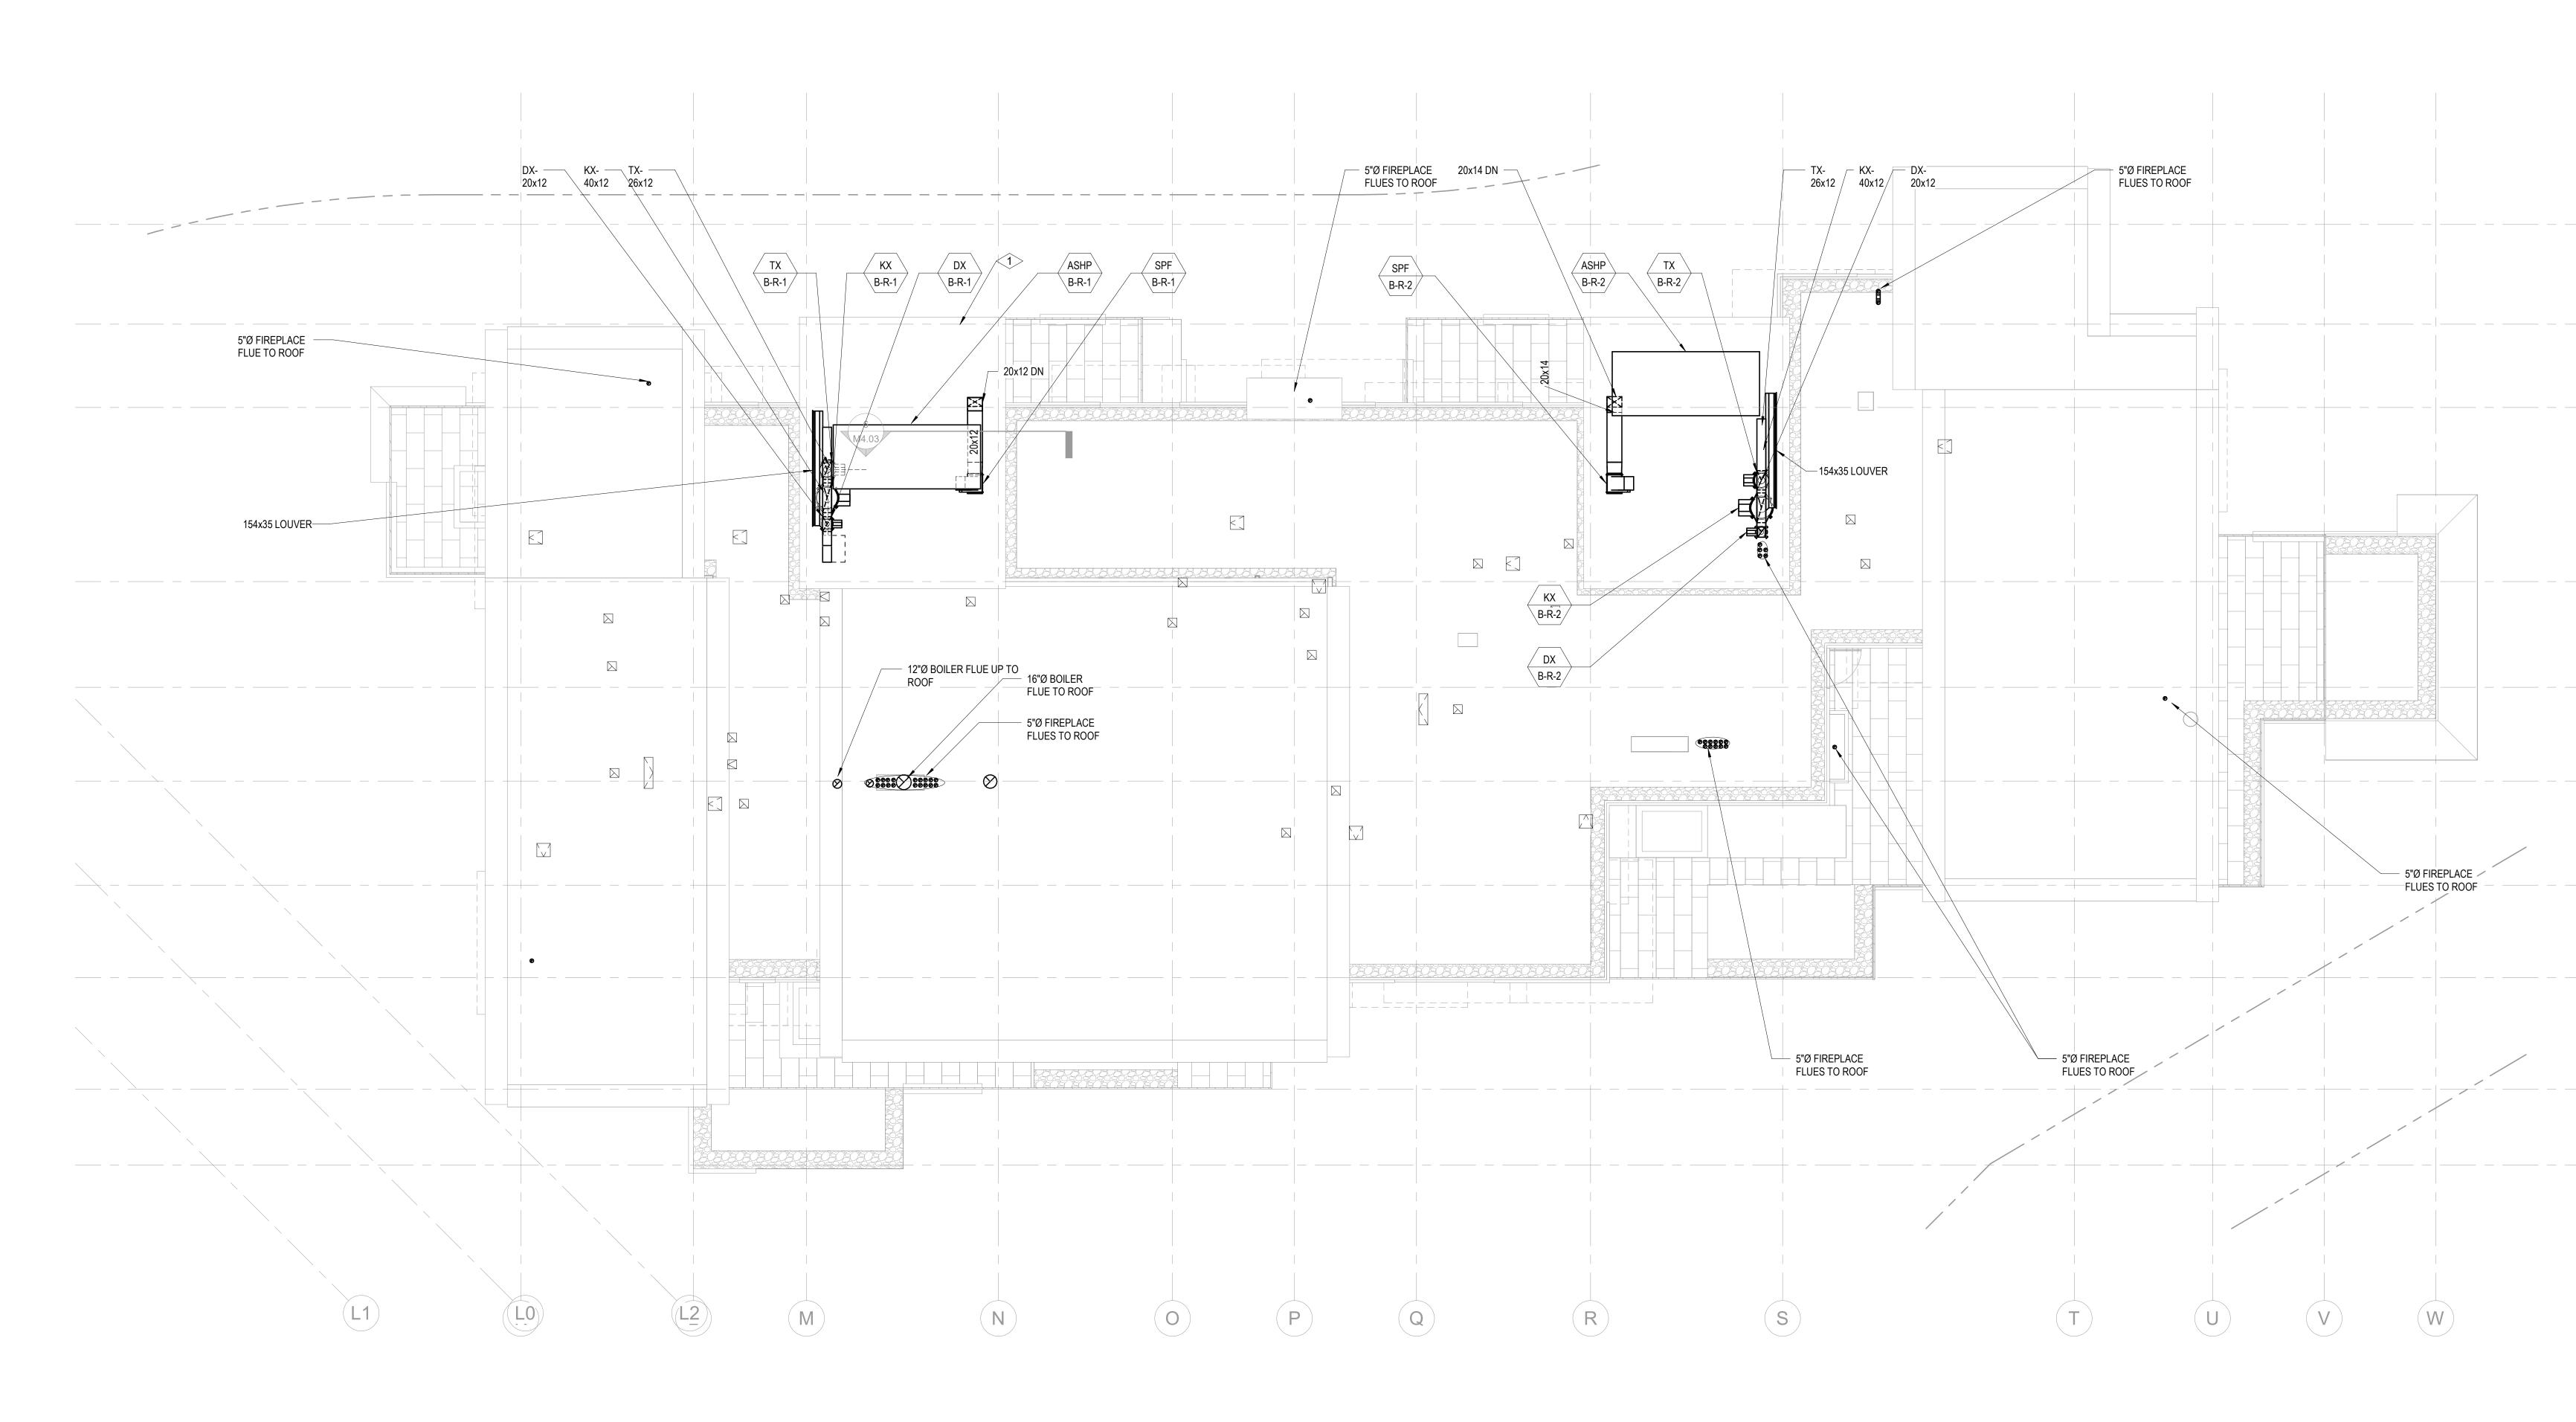
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ASPEN GROUP Aspen Group USA, LLC PO Box 980022 Park City, Utah 84098
Pool Consultant         Cloward H2D         2696 N University Ave, Suite 290         Provo, UT 84604         Landscape Architect         EPG Design         6949 South High Tech Drive, Suite 100         Midvale, Utah 84047         Specifications Writer         Friday Group         83 Mainelli Road         Middlebury, VT         Code Consultant         Holmes         00 1st Avenue, Suite 200A         Seattle, WA 98104         Fire Protection Engineer         Janson Hughes         One Research Drive, Suite 305C         Westborough, MA 01581         Vertical Transportation Consultant         Licerch Bates         19515 North Creek Parkway, Suite 304         Bothell, WA 98011         Structural Engineer         Magnusson Klemencic Associates         1301 5in Ave, Suite 3200         Seattle, WA 98103         Accessibility Consultant         Studio Pacifica         2141 Westlake Ave N, Suite F         Seattle, WA 98103         Accessibility Consultant         Studio Pacifica         2144 Westlake Ave N, Suite F         Seattle, WA 98103         Mideseatere
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1 TOWER B - ROOF MECHANICAL DUCT PLAN SCALE: 1/8" = 1'-0"

## SHEET NOTES:

- A. REFER TO M2.4 SERIES FOR ENLARGED PLANS.B. FIREPLACE FLUE ROUTING SHOWN FOR REFERENCE. REFER TO ENLARGED UNIT PLANS FOR ROUTING
- AND SIZING DETAIL. C. MECHANICAL EQUIPMENT SHOWN FOR REFERENCE. REFER TO ENLARGED UNIT PLANS FOR DETAIL.

# NUMBERED NOTES:

1 STAIR TO BE PROVIDED WITH 2-HR RATED CEILING

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Reserved for permit stamp D Ū Kur project: SOMMET BLANC 9300 Marsac Ave (B2 East P Park City, Utah 84060 Olson ASPEN GROUP **Aspen Group USA, LLC** PO Box 980022 Park City, Utah 84098 <u>Pool Consultant</u> **Cloward H20** 2696 N University Ave, Suite 290 Provo, UT 84604 <u>Landscape Architect</u> **EPG Design** 6949 South High Tech Drive, Suite 100 Midvale, Utah 84047 <u>Specifications Writer</u> **Friday Group** 88 Mainelli Road Middlebury, VT <u>Code Consultant</u> **Holmes** 600 1st Avenue, Suite 200A Seattle, WA 98104 <u>Fire Protection Engineer</u> **Jensen Hughes** One Research Drive, Suite 305C Westborough, MA 01581 <u>Vertical Transportation Consulatant</u> **Lerch Bates** 19515 North Creek Parkway, Suite 304 Bothell, WA 98011 <u>Structural Engineer</u> **Magnusson Klemencic Associates** 1301 5th Ave, Suite 3200 Seattle, WA 98101 Lighting Designer 1319 SE MLK Blvd, Suite 210 Portland, Oregon 97219 Building Envelope Consultant RDH 2101 N 34th St Seattle, WA 98103 <u>Accessibility Consultant</u> **Studio Pacifica** 2144 Westlake Ave N, Suite F Seattle, WA 98109 MEP Engineer WSP USA 1001 Fourth Ave., Suite 3100 Seattle, WA 98154 principal architect project manager\_\_\_\_\_ drawn by\_\_\_\_\_ ----checked by <u>Checker</u> job no. date 11/18/2022 revisions: \_\_\_\_\_ \_\_\_\_\_ -----\_\_\_\_\_ no. date by ISSUE FOR CONSTRUCTION 11/18/2022

TOWER B - ROOF MECHANICAL DUCT PLAN

M2.2B.R

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 2'
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