FLOOR PLAN SYMBOLS			
SYMBOL DESCRIPTION			
	PIPING ANNOTATION		
SYSTEM DESIGNATION			
(XXX)	HYDRAULIC REFERENCE POINT (NODE)		
	HYDRAULIC CALCULATION AREA		
	MISCELLANEOUS		
NS	NON-SPRINKLERED AREA		
X	KEYNOTE		
X-Y DWG	X = SYSTEM TYPE Y = RISER NUMBER DWG = DRAWING NUMBER		
SPRINKLERS			
•	PENDENT FRAME SPRINKLER		
0	UPRIGHT FRAME SPRINKLER		
∇	SIDEWALL FRAME SPRINKLER		

GENERAL
AV AUDIO/VISUAL ACT ACOUSTIC CEILING TILE AFF ABOVE FINISHED FLOOR AFG ABOVE FINISHED GRADE AHJ AUTHORITY HAVING JURISDICTION ARCH ARCHITECT BOP BOTTOM OF PIPE BOR BOTTOM OF RISER CL CENTERLINE DN DOWN DEG DEGREES DWG DRAWING ELEC ELECTRICAL ELEV ELEVATOR EX EXISTING FA FIRE ALARM FP FIRE PROTECTION FT FEET GPM GALLONS PER MINUTE GWB GYPSUM WALL BOARD INV INVERT LTG LIGHTING LV LOW VOLTAGE (AUDIO/VISUAL, SECURITY, MAX TEL/DATA) MECH MAXIMUM MEP MECHANICAL MIN MECH, ELEC, PLBG, FP, FA, LV, ETC. N/A MINIMUM NAS NOT APPLICABLE NC NO AUTOMATIC SPRINKLER NIC NORMALLY CLOSED NTS NOT IN CONTRACT OED NOT TO SCALE PLBG OPEN END DRAIN SQFT PLUMBING TEMP SQUARE FEET TOR TEMPERATURE TYP TOP OF RISER
W/ TYPICAL WITH

OVVOI	CTANDDIDE		
FDC	STANDPIPE FIRE DEPARTMENT CONNECTION		
SD	SPRINKLER DRAIN		
TH	FIRE PUMP TEST HEADER		
WST	WET-PIPE STANDPIPE		
WFM	WET-PIPE STANDPIPE WET-PIPE FEED MAN		
WFM WSP	WET-PIPE FEED MAN WET-PIPE SPRINKLER		
WSP	EQUIPMENT		
A DV			
ARV	AIR RELEASE VALVE		
BFP	BACKFLOW PREVENTOR		
BV	BUTTERFLY VALVE		
CKV	CHECK VALVE		
DCVA DV	DOUBLE CHECK VALVE ASSEMBLY DRAIN VALVE		
FHV	FIRE HOSE VALVE		
''''	FLOW METER		
FM FPU-#	FIRE PUMP		
FPC-#	FIRE PUMP CONTROLLER		
MDV	MAIN DRAIN VALVE		
OSY	OS&Y GATE VALVE		
PG	PRESSURE GAUGE		
PMP-#	PRESSURE MAINTENANCE PUMP		
PMPC-#	PRESSURE MAINTENANCE PUMP		
PREV	CONTROLLER		
PRV	PRESSURE RELIEF VALVE		
PS	PRESSURE REGULATING VALVE		
TDV	PRESSURE SWITCH		
TH	TEST & DRAIN VALVE		
TS	TEST HEADER		
ZCA	TAMPER SWITCH		
	ZONE CONTROL ASSEMBLY		
*NOT ALL ABBREVIATIONS USED FOR THIS PROJECT.			

GENERAL REQUIREMENTS THE FIRE PROTECTION ENGINEERING DRAWINGS ARE DIAGRAMMATIC IN NATURE AND NOT INTENDED TO BE ABSOLUTELY PRECISE NOR INDICATE

EVERY REQUIRED SYSTEM COMPONENT. THEY REPRESENT A SYSTEM

CONCEPT AND INDICATE THE MAIN SYSTEM COMPONENTS. PRIOR TO SUBMITTING THE BID THE INSTALLING CONTRACTOR OF THE WORK INDICATED ON THE FIRE PROTECTION ENGINEERING DRAWINGS AND ASSOCIATED TECHNICAL SPECIFICATIONS (REFERRED TO AS "THE CONTRACTOR" HEREAFTER) SHALL VISIT AND CAREFULLY EXAMINE THE SITE WITH THE ENGINEERING DRAWINGS TO REVIEW EXISTING CONDITIONS AND IDENTIFY DIFFICULTIES THAT MAY AFFECT THE SCOPE OF WORK. NO ADDITIONAL COST WILL BE ALLOWED FOR ADDITIONAL SCOPE CAUSED BY UNFAMILIARITY WITH SITE CONDITIONS THAT ARE READILY VISIBLE OR CONSTRUED BY AN EXPERIENCED OBSERVER.

THE CONTRACTOR SHALL FIELD VERIFY LOCATIONS OF ALL SYSTEM COMPONENTS, WALL LOCATIONS AND DIMENSIONS AND CEILING HEIGHTS AND COORDINATE WITH THE FIRE PROTECTION SYSTEM TECHNICIAN PRIOR TO PREPARATION OF THE WORKING PLANS / SHOP DRAWINGS. REFER TO DOCUMENT AND SUBMITTAL REQUIREMENTS ON THIS DRAWING FOR ADDITIONAL INFORMATION.

APPLICABLE DOCUMENTS BEYOND THE ENGINEERING DRAWINGS: A. CODES AND INSTALLATION STANDARDS INDICATED ON THIS ARCHITECTURAL, MEP AND FIRE ALARM DRAWINGS. PROJECT MANUAL (TECHNICAL SPECIFICATIONS).

PRODUCT MANUFACTURER'S REQUIREMENTS. THE CONTRACTOR SHALL GUARANTEE IN WRITING ALL WORK AND EQUIPMENT ASSOCIATED WITH THIS PROJECT FOR ONE (1) YEAR AFTER INSTALLATION. REFER TO THE TECHNICAL SPECIFICATION FOR ADDITIONAL WARRANTY REQUIREMENTS.

FIRE PROTECTION HYDRAULIC CALCULATIONS.

SCOPE OF WORK THE SCOPE OF WORK (REFERRED TO AS "THE WORK" HEREAFTER)

CLASS I AUTOMATIC STANDPIPE SYSTEM AND ELECTRIC-DRIVE FIRE PUMP SYSTEM AS INDICATED ON THE DRAWINGS. THE WORK INCLUDES FURNISHING AND INSTALLING ALL SPRINKLERS, PIPING, FITTINGS, HANGERS, VALVES AND OTHER ASSOCIATED COMPONENTS IN AREAS OF THE BUILDING REPRESENTED ON THE ENGINEERING DRAWINGS TO MAKE THE SYSTEMS FULLY COMPLETE AND

INCLUDES THE INSTALLATION OF AN AUTOMATIC SPRINKLER SYSTEM,

THE WORK INCLUDES FIRESTOPPING OF ALL PENETRATIONS THROUGH FIRE-RESISTANCE RATED BARRIERS.

4. THE WORK INCLUDES PREPARATION AND SUBMITTAL DOCUMENTS & SUBMITTALS INDICATED ON THIS DRAWING.

THE WORK INCLUDES PERFORMING FIELD QUALITY CONTROL AND COMMISSIONING ACTIVITIES OUTLINED IN NFPA 25. THE WORK INCLUDES TRAINING OWNER'S PERSONNEL ON THE OPERATION OF THE SYSTEM, REQUIRED MAINTENANCE TASKS AND

FREQUENCIES, AND THE LOCATIONS OF ALL SPARE TOOLS AND EQUIPMENT, VALVES, ALARM AND SUPERVISORY SWITCHES, RISERS AND EQUIPMENT NECESSARY TO MAINTAIN AND OPERATE THE SPRINKLER

DOCUMENT AND SUBMITTAL REQUIREMENTS THE FIRE PROTECTION ENGINEERING DRAWINGS ARE "PRELIMINARY PLANS" AS DEFINED BY NFPA. THE HAVE BEEN PREPARED FOR SUBMISSION TO THE AUTHORITY HAVING JURISDICTION IN ORDER TO OBTAIN A BUILDING PERMIT AND AS THE BASIS OF DESIGN FOR THE PREPARATION OF THE WORKING PLANS / SHOP DRAWINGS. THEY INCLUDE A REPRESENTATION OF HAZARDS TO BE PROTECTED, THE SYSTEM DESIGN CONCEPT, DESIGN CRITERIA AND WATER SUPPLY

CONFIGURATION. THESE DRAWINGS INCLUDE CONCEPTUAL LOCATIONS & ARRANGEMENTS OF MAJOR COMPONENTS INCLUDING BUT NOT LIMITED TO MAINS, RISERS, VALVES AND CONNECTIONS. THEY ARE NOT INTENDED TO BE USED FOR INSTALLATION OR TO OBTAIN INSTALLATION THE CONTRACTOR SHALL PREPARE AND SUBMIT FOR APPROVAL TO THE AUTHORITY HAVING JURISDICTION AND THE ENGINEER A COMPLETE

SUBMITTAL PACKAGE INCLUSIVE OF PRODUCT DATA SHEETS, WORKING PLANS / SHOP DRAWINGS AND HYDRAULIC CALCULATIONS. THE SUBMITTAL PACKAGE SHALL INCLUDE ALL INFORMATION REQUIRED BY THE TECHNICAL SPECIFICATIONS AND THE APPLICABLE NFPA STANDARDS INDICATED ON THIS DRAWING. THE WORKING PLANS AND HYDRAULIC CALCULATIONS SHALL BE PREPARED UNDER THE SUPERVISION OF A QUALIFIED ENGINEERING TECHNICIAN OR PROFESSIONAL ENGINEER. THE WORKING PLANS SHALL

INDICATE THE TECHNICIAN'S OR ENGINEER'S NAME AND THEIR

CERTIFICATION OR REGISTRATION NUMBER. WHERE THE LOCAL

RESPONSIBLE FOR RETAINING THE SERVICES OF A THIRD PARTY

BY A PROFESSIONAL ENGINEER THE CONTRACTOR SHALL BE

AUTHORITY REQUIRES THE WORKING PLANS TO BE SIGNED AND SEALED

PROFESSIONAL ENGINEER TO SIGN AND SEAL THE PACKAGE. THE CONTRACTOR SHALL PREPARE AND SUBMIT ALL ADDITIONAL FORMS AND DOCUMENTATION REQUIRED BY THE AUTHORITY HAVING JURISDICTION AND BE RESPONSIBLE FOR FEES ASSOCIATED WITH

INSTALLATION PERMIT APPLICATION.

CHANGES IN THE LOCATION OF SYSTEM COMPONENTS (INCLUDING BUT NOT LIMITED TO SPRINKLERS AND VALVES) FROM THOSE INDICATED ON THE APPROVED SHOP DRAWING SHALL BE IDENTIFIED IN WRITING TO THE AUTHORITY HAVING JURISDICTION AND JENSEN HUGHES PRIOR TO INSTALLATION. ALL CHANGES FROM THE APPROVED SHOP DRAWINGS SHALL BE APPROVED IN WRITING PRIOR TO INSTALLATION. ANY RELOCATIONS OR ADDITIONAL COMPONENTS REQUIRED FOR A FULL CODE COMPLIANT INSTALLATION (I.E. ADDITIONAL SPRINKLERS) AS A RESULT OF THE CHANGES SHALL BE FURNISHED AND INSTALLED AT THE EXPENSE OF THE CONTRACTOR.

THE CONTRACTOR SHALL BE RESPONSIBLE FOR COORDINATING WITH ANY NEW SITE SPECIFIC MODIFICATIONS THAT MAY BE MADE TO THE BUILDING DURING CONSTRUCTION SUCH AS NEW LIGHTS, DROP CEILINGS, ETC. AND UPDATING THE WORKING PLANS AS REQUIRED THROUGHOUT THE DURATION OF CONSTRUCTION.

THE CONTRACTOR SHALL PREPARE AND SUBMIT FOR APPROVAL THE FOLLOWING CLOSEOUT DOCUMENTATION: A. A COMPLETE RECORD DRAWING PACKAGE BEARING "RECORD

DRAWING", "AS-BUILT DRAWING" OR SIMILAR AND THE ASSOCIATED

DATE OF CREATION. THE RECORD DRAWING PACKAGE SHALL INCLUDE SITE SPECIFIC MODIFICATIONS RECORDED DURING CONSTRUCTION. . APPLICABLE SYSTEMS ACCEPTANCE DOCUMENTATION REQUIRED BY THE APPLICABLE NFPA STANDARDS. . COMPLETE PRODUCT DATA SUBMITTAL PACKAGE INCLUSIVE OF

D. OPERATION AND MAINTENANCE MANUALS. FIRE PROTECTION SYSTEM DESIGN REQUIREMENTS FIRE PROTECTION SYSTEM DESIGN AND INSTALLATION SHALL COMPLY

ALL INSTALLED MATERIALS.

WITH THE FOLLOWING REQUIREMENTS OF:

A. 2018 UTAH BUILDING CODE (AMENDED 2018 IBC) 2018 UTAH FIRE CODE (AMENDED 2018 IFC) 2016 NFPA 13, STANDARD FOR THE INSTALLATION OF SPRINKLER

D. 2016 NFPA 14, STANDARD FOR THE INSTALLATION OF STANDPIPE AND HOSE STYSTEMS

E. 2016 NFPA 20, STANDARD FOR THE INSTALLATION OF STATIONARY PUMPS FOR FIRE PROTECTION F. 2016 NFPA 22, STANDARD FOR WATER TANKS FOR PRIVATE FIRE PROTECTION

G. MANUFACTURER'S PUBLISHED DOCUMENTATION AT THE COMMENCEMENT OF FSYSTEM INSTALLATION.

NEW SPRINKLER SYSTEMS SHALL BE HYDRAULICALLY CALCULATED AND SIZED IN ACCORDANCE WITH THE DESIGN CRITERIA INDICATED ON THIS DRAWING AND THE REQUIREMENTS OF NFPA 13 & NFPA 14 WITH A MINIMUM SAFETY MARGIN OF 10 PSI. PIPE SIZES SHALL BE NO SMALLER THAN AS INDICATED BY THE DESIGN HYDRAULIC CALCULATIONS AND DESIGN DRAWINGS UNLESS VERIFIED THROUGH APPROVED CALCULATION SUBMITTAL.

FIRE PROTECTION SYSTEM INSTALLATION REQUIREMENTS COORDINATE INSTALLATION ACTIVITIES WITH OTHER DIVISIONS OF WORK AND EXISTING CONDITIONS. MAKE REASONABLE AND NECESSARY MODIFICATIONS IN SYSTEM INSTALLATION REQUIRED TO PREVENT CONFLICTS WITH OTHER DIVISIONS OF WORK AND IN ORDER TO MAINTAIN ALL CODE REQUIRED CLEARANCES FOR INSPECTION, TESTING

ALL COMPONENTS SHALL BE NEW UNLESS OTHERWISE NOTED AND BE UL LISTED AND FM APPROVED.

INSTALL SYSTEMS IN AN EFFICIENT AND RECTILINEAR ARRANGEMENT WITH COMPONENTS PERPENDICULAR AND PARALLEL TO BUILDING WALLS, CEILINGS, STRUCTURE AND SIMILAR ELEMENTS. UNLESS OTHERWISE INDICATED CEILING MOUNTED SYSTEM COMPONENTS SHALL

ALL CONTROL / TEST / DRAIN VALVES SHALL BE INSTALLED WITH INDICATORS VISIBLE FROM THE FLOOR BELOW AND SUCH THAT THEY ARE READILY ACCESSIBLE AND VISIBLE FOR ROUTINE INSPECTION, TESTING AND MAINTENANCE. ALL VALVES SHALL BE INSTALLED SUCH THAT THEY ARE ACCESSIBLE EITHER FROM FLOOR LEVEL OR AT A LOCATION ACCESSIBLE FROM AN 8-FT LADDER.

IDENTIFICATION (INCLUDING BUT NOT LIMITED TO VALVE TAGS, GENERAL INFORMATION SIGNS AND HYDRAULIC SIGNS) SHALL BE PROVIDED AS REQUIRED BY THE APPLICABLE NFPA STANDARDS AND LOCAL FIRE DEPARTMENT AT ALL CONTROL / TEST / DRAIN VALVES, RISERS AND EQUIPMENT. A RIGID PLASTIC SIGN INDICATING THE LOCATION OF ALL VALVES, THE AREA PROTECTED BY EACH CONTROL VALVE SHALL BE SHALL BE PROVIDED AND INSTALLED AT THE MAIN SYSTEM RISER(S).

ARRANGE PIPING TO DRAIN BACK TO MAIN DRAIN VALVES FOR EACH SYSTEM. PIPING SHALL BE INSTALLED TO MINIMIZE THE REQUIREMENT FOR AUXILIARY DRAINS. WHERE AUXILIARY DRAINS ARE REQUIRED FOR TRAPPED SECTIONS OF PIPING THEY SHALL BE INSTALLED IN LOCATIONS APPROVED BY THE OWNER.

FIRESTOPPING SYSTEMS AT ALL FLOOR / WALL PENETRATIONS AS REQUIRED BY THE TECHNICAL SPECIFICATIONS. PIPING SHALL BE SUPPORTED VIA LISTED HANGERS AND SUPPORTS ATTACHED DIRECTLY TO BUILDING STRUCTURE. ATTACHMENT SHALL

PROVIDE SLEEVES, SLEEVES SEALS, ESCUTCHEONS AND LISTED

NOT BE MADE TO METAL ROOF DECKING, NON-DIVISION 21 WORK OR NON-BUILDING STRUCTURAL ELEMENTS. THREADED HANGER RODS SHALL NOT BE FORMED OR BENT. CONTRACTOR SHALL REPLACE ANY EXISTING / NEW BENT ROD WITHIN

THE AREA OF WORK WITH NEW. AUTOMATIC SPRINKLER SYSTEM CONCENTRIC FITTINGS SHALL BE UTILIZED FOR PIPING SIZE TRANSITIONS AND SPRINKLER CONNECTIONS. BUSHINGS ARE

COORDINATE SPRINKLER TEMPERATURE RATINGS BASED UPON ANTICIPATED AMBIENT TEMPERATURE, SOURCES OF HEAT OR SPECIFIC LOCATIONS SUCH AS SKYLIGHTS AS REQUIRED BY NFPA 13. UNLESS OTHERWISE NOTED OR REQUIRED SPRINKLERS SHALL BE ORDINARY TEMPERATURE RATED.

PROVIDE LISTED GUARDS ON SPRINKLERS IN LOCATIONS PRONE TO DAMAGE SUCH AS MECHANICAL ROOMS, STORAGE ROOMS, SPRINKLERS INSTALLED LESS THAN 7 FT AFF AND SIMILAR AREAS.

PROVIDE A CABINET WITH SPARE SPRINKLERS AND A LIST OF SPARE SPRINKLERS AS REQUIRED BY NFPA 13. PROVIDE SPRINKER PROTECTION ABOVE AND BELOW WOOD CEILINGS. REFER TO ARCHITECTURAL RCPs FOR ADDITIONAL INFORMATION. STANDPIPE SYSTEM

PROVIDE AIR RELIEF VALVES AND PRESSURE GAUGES WITH THREE WAY VALVES AND DRAIN PLUGS AT THE TOP OF EACH STANDPIPE

PROVIDE DRAIN VALVES AT THE BASE OF EACH STANDPIPE AND DRAIN

SYSTEM(S) APPLICATIONS STANDARD-PRESSURE WET-PIPE FIRE SUPPRESSION. WET-PIPE SPRINKLER MAINS AND BRANCHES SUPPLYING | CPVC PIPE WITH PLAIN ENDS; SCHEDULE 40 CPVC SOCKET TYPE SPRINKLERS IN RESIDENTIAL CORRIDORS AND FITTINGS FOR NPS 1 TO NPS 1-1/2, SCHEDULE 80 CPVC SOCKET DWELLING UNITS WHERE CONCEALED ABOVE FINISHED | TYPE FITTINGS FOR NPS 2 TO NPS 3; AND SOLVENT-CEMENTED CEILINGS. AND MAINTENANCE FOR ALL BUILDING SYSTEMS AND CODE MINIMUM WET-PIPE SPRINKLER, 2" AND SMALLER STANDARD-PRESSURE WET-PIPE FIRE SUPPRESSION. SCHEDULE 40 BLACK STEEL PIPE WITH THREADED ENDS; (NON-RESIDENTIAL AREAS). UNCOATED THREADED FITTINGS; AND THREADED JOINTS. STANDARD-PRESSURE WET-PIPE FIRE SUPPRESSION. WET-PIPE SPRINKLER AND STANDPIPE PIPING 2 1/2" AND LARGER (NON-RESIDENTAL AREAS).

** REFER TO FP6.01 FOR HYDRAULIC CALCULATION NODES.

PERMISSIBLE PIPE AND FITTINGS FOR 2" AND SMALLER OR SCHEDULE 10 BLACK STEEL PIPE WITH ROLL-GROOVED ENDS; GROOVED-END FITTINGS, PIPE COUPLINGS AND HIGH-PRESSURE WET-PIPE FIRE SUPPRESSION. STANDPIPE AND DISTRIBUTION PIPING 2 1/2" SCHEDULE 10 BLACK STEEL PIPE WITH ROLL-GROOVED BE INSTALLED CONCEALED ABOVE FINISHED CEILINGS. ENDS; GROOVED-END FITTINGS, PIPE COUPLINGS AND STANDARD-PRESSURE DRY-PIPE FIRE SUPPRESSION. DRAIN PIPING 2" AND SMALLER. GALVANIZED SCHEDULE 40 STEEL PIPE WITH THREADED JOINTS; GALVANIZED THREADED FITTINGS; AND GALVANIZED THREADED STANDARD-PRESSURE DRY-PIPE FIRE SUPPRESSION. DRAIN, TEST HEADER AND FDC PIPING 2 1/2" PERMISSIBLE PIPE AND FITTINGS FOR 2" AND SMALLER OR

> SPRINKLER SCHEDULE FRAME(S) RESPONSE K-FACTOR(S) FINISH APPLICATION(S) BACK OF HOUSE SPACES WITH EXPOSED CEILINGS STANDARD-SPRAY, EXPOSED UPRIGHT, PENDENT | QUICK 5.6, 8.0* STANDARD-SPRAY, CONCEALED WITH 5.6, 8.0* SEE NOTE 1 NON-RESIDENTIAL SPACES WITH FINISHED CEILINGS FLAT COVERPLATE RESIDENTIAL DWELLING UNITS AND ADJOINING CORRIDORS RESIDENTIAL-SPRAY, CONCEALED WITH FAST

AND LARGER.

FLAT COVERPLATE

PIPING SCHEDULE

REQUIRED PIPE & FITTINGS

SCHEDULE 40 GALVANIZED STEEL PIPE WITH CUT-GROOVED ENDS;

FACTORY COATED GROOVED-END FITTINGS, PIPE COUPLINGS AND

*PROVIDE K8.0 SPRINKLERS FOR ORDINARY HAZARD GROUP 2 OCCUPANCIES.

1. PROVIDE SQUARE COVERPLATES FOR SPRINKLERS WITH WHITE FINISHES FOR GYPSUM AND ACT CEILINGS AND BLACK FOR WOOD CEILINGS. PROVIDE CUSTOM COLORED COVERPLATES FOR METAL CEILINGS IN THE OWNER'S LOUNGE OF TOWER C. 2. PROVIDE SQUARE COVERPLATES FOR SPRINKLERS WITH WHITE FINISHES FOR GYPSUM CEILINGS AND BLACK FOR WOOD CEILINGS.

SPRINKLER SYSTEM DESIGN CRITERIA - NFPA 13 APPLICABLE AREAS OCCUPANCY HAZARD MAX AREA PER DISCHARGE DENSITY AREA OF SPRINKLER HOSE STREAM SPRINKLER (SQFT) (GPM/SQFT) OPERATION (SQFT) | ALLOWANCE (GPM) | AMENITIES, CORRIDORS, BATHROOMS, OFFICES, RESTARAUNT, COMMON AEAS & SIMIILAR LIGHT HAZARD 225 0.10 1500 100 MECHANICAL, ELECTRICAL, TEL/DATA, PARKING, KITCHEN ORDINARY HAZARD GROUP 1 1500 130 0.15 250 STORAGE UNDER 12-FT ORDINARY HAZARD GROUP 2 0.20 1500 250 RESIDENTIAL DWELLING UNITS & ADJOINING CORRIDORS 256 0.10 4 SPRINKLERS 100 RESIDENTIAL GENERATOR / FUEL OIL STORAGE EXTRA HAZARD GROUP 1 100 0.30 ENTIRE ROOM 500 STANDPIPE SYSTEM DESIGN CRITERIA - NFPA 14 FDV OUTLET MAXIMUM STATIC MINIMUM STATIC TOTAL SYSTEM **OUTLET LOCATIONS** NFPA 14 CLASS NOMINAL SIZE (IN.) | PRESSURE (PSI) | PRESSURE (PSI) | DESIGN FLOW EGRESS STAIRS - MAIN LANDING CLASS I - AUTO 2 1/2 175 100 750 I 1000* * STANDPIPE SYSTEM DESIGN FOR TOWER C IS 750 GPM; TOWERS A & B IS 1,000 GPM.

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revisions:

no. date by


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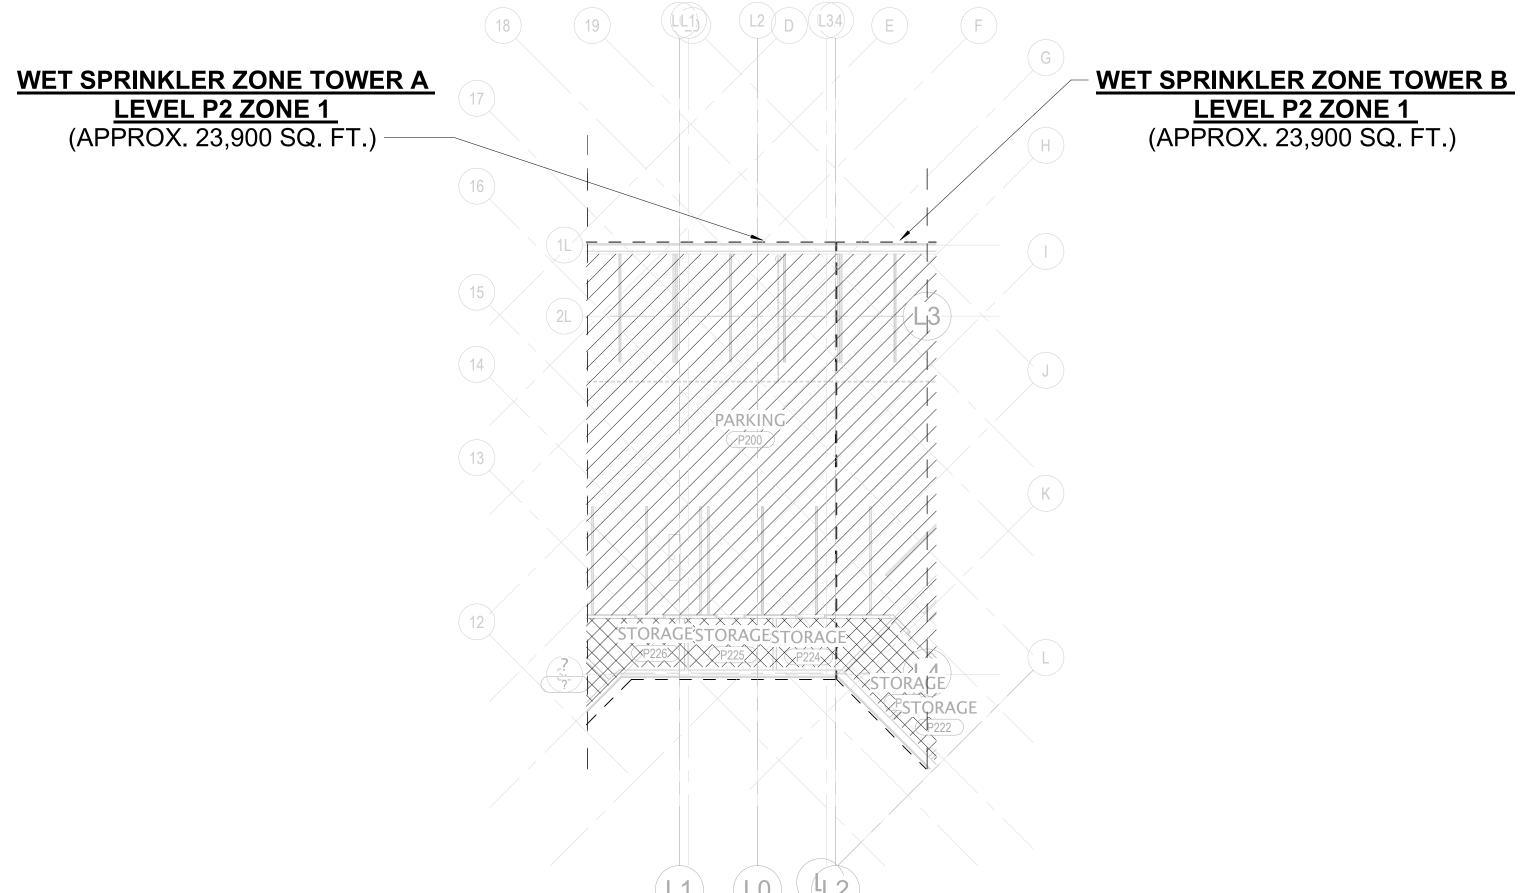
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FIRE PROTECTION NOTES, LEGEND AND

DESIGN CRITERIA


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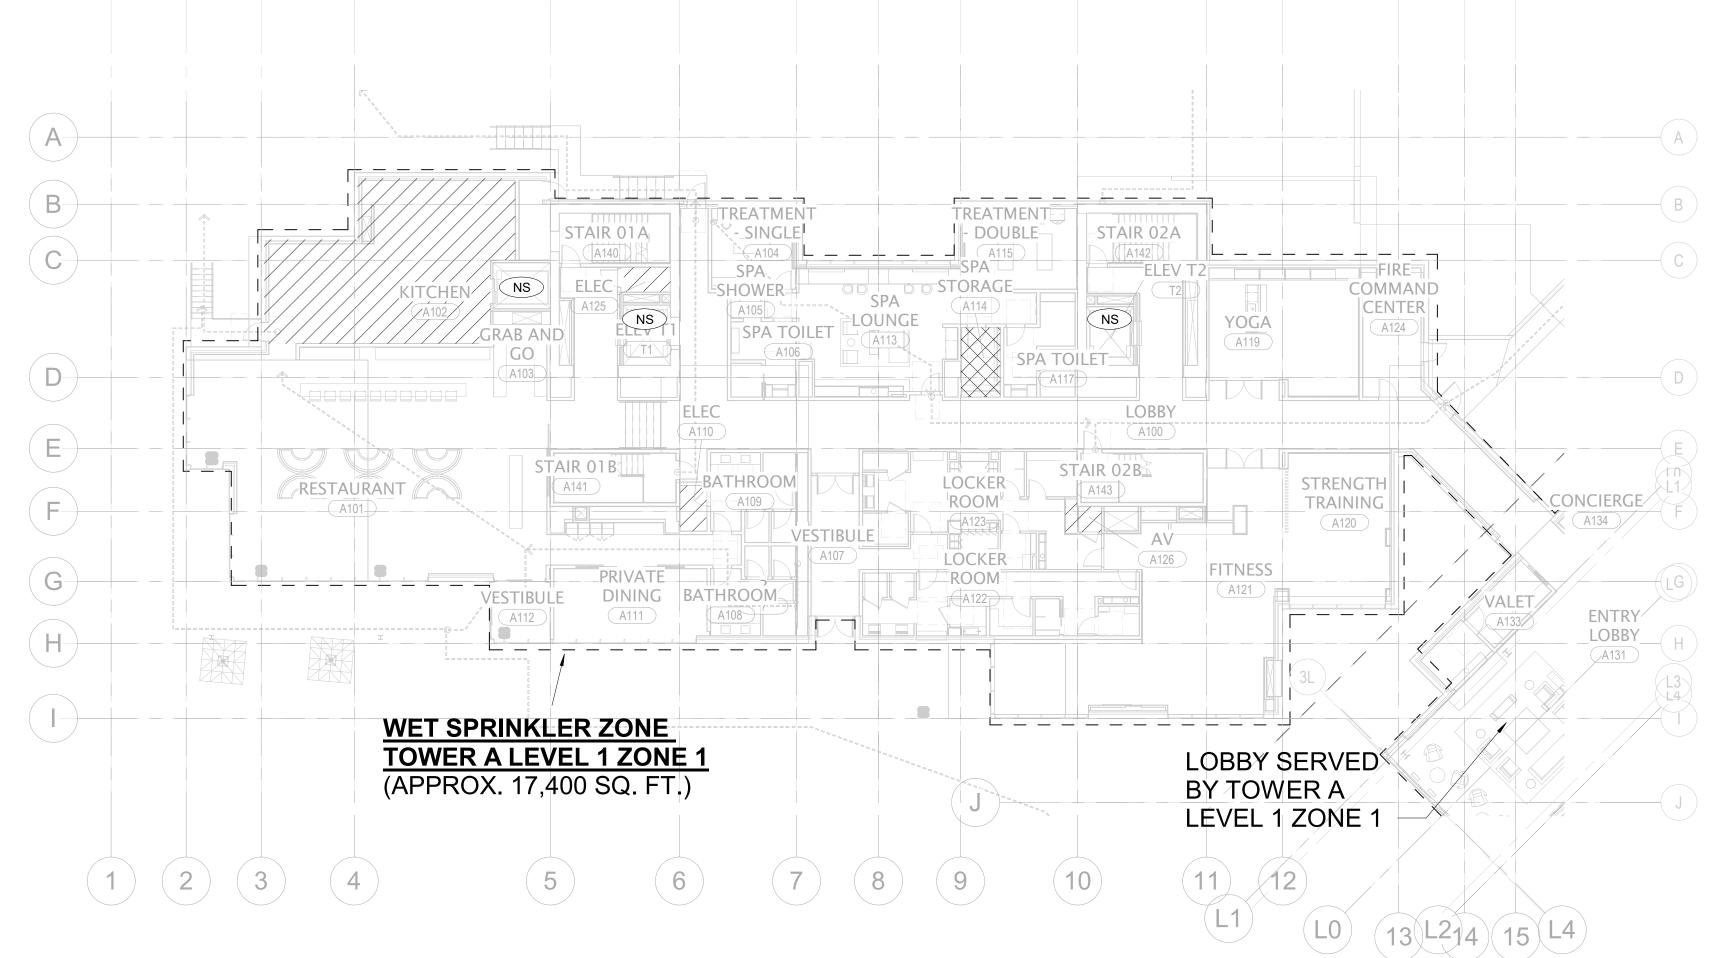




L1 L0 L2 TOWER AB LOBBY - LEVEL P2 - ZONING PLAN

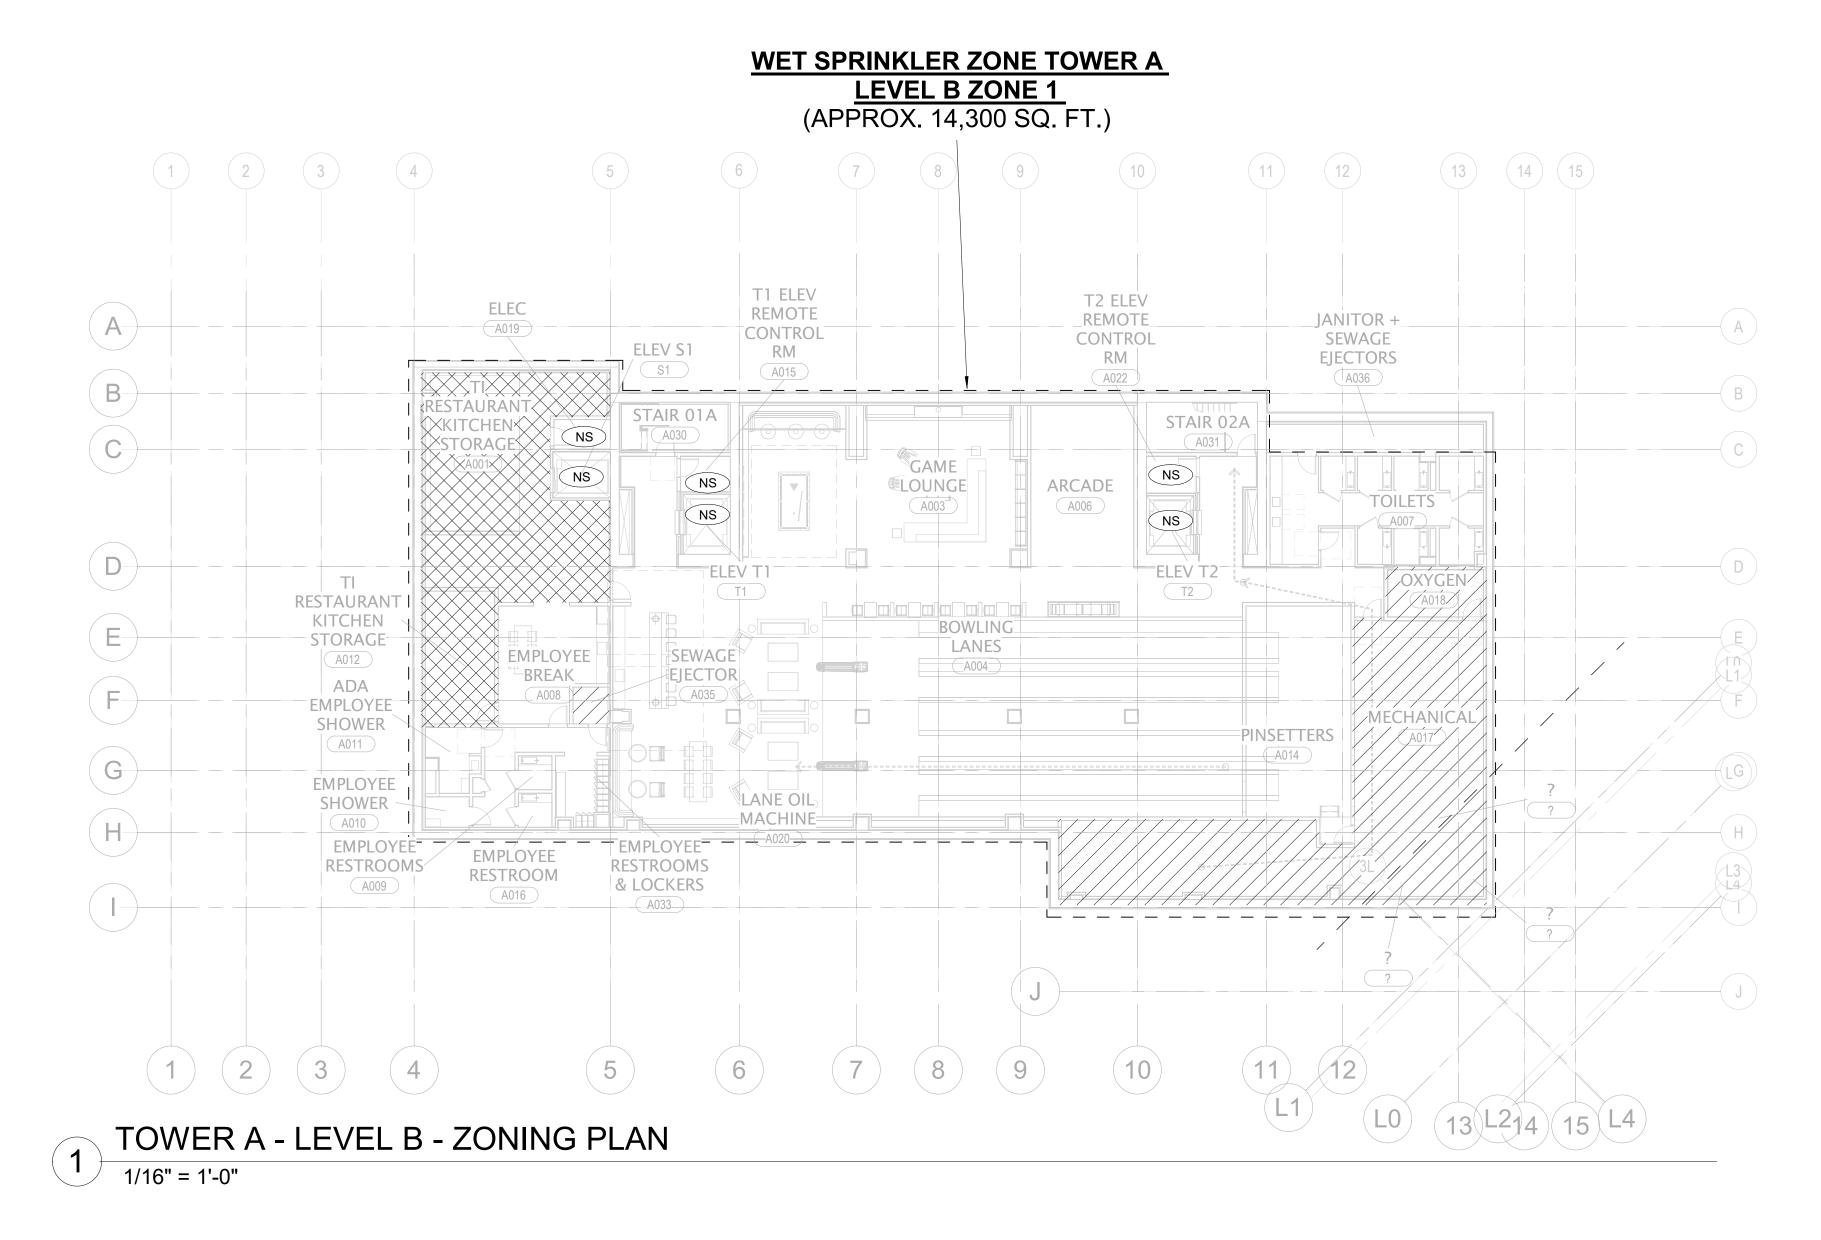1/16" = 1'-0"



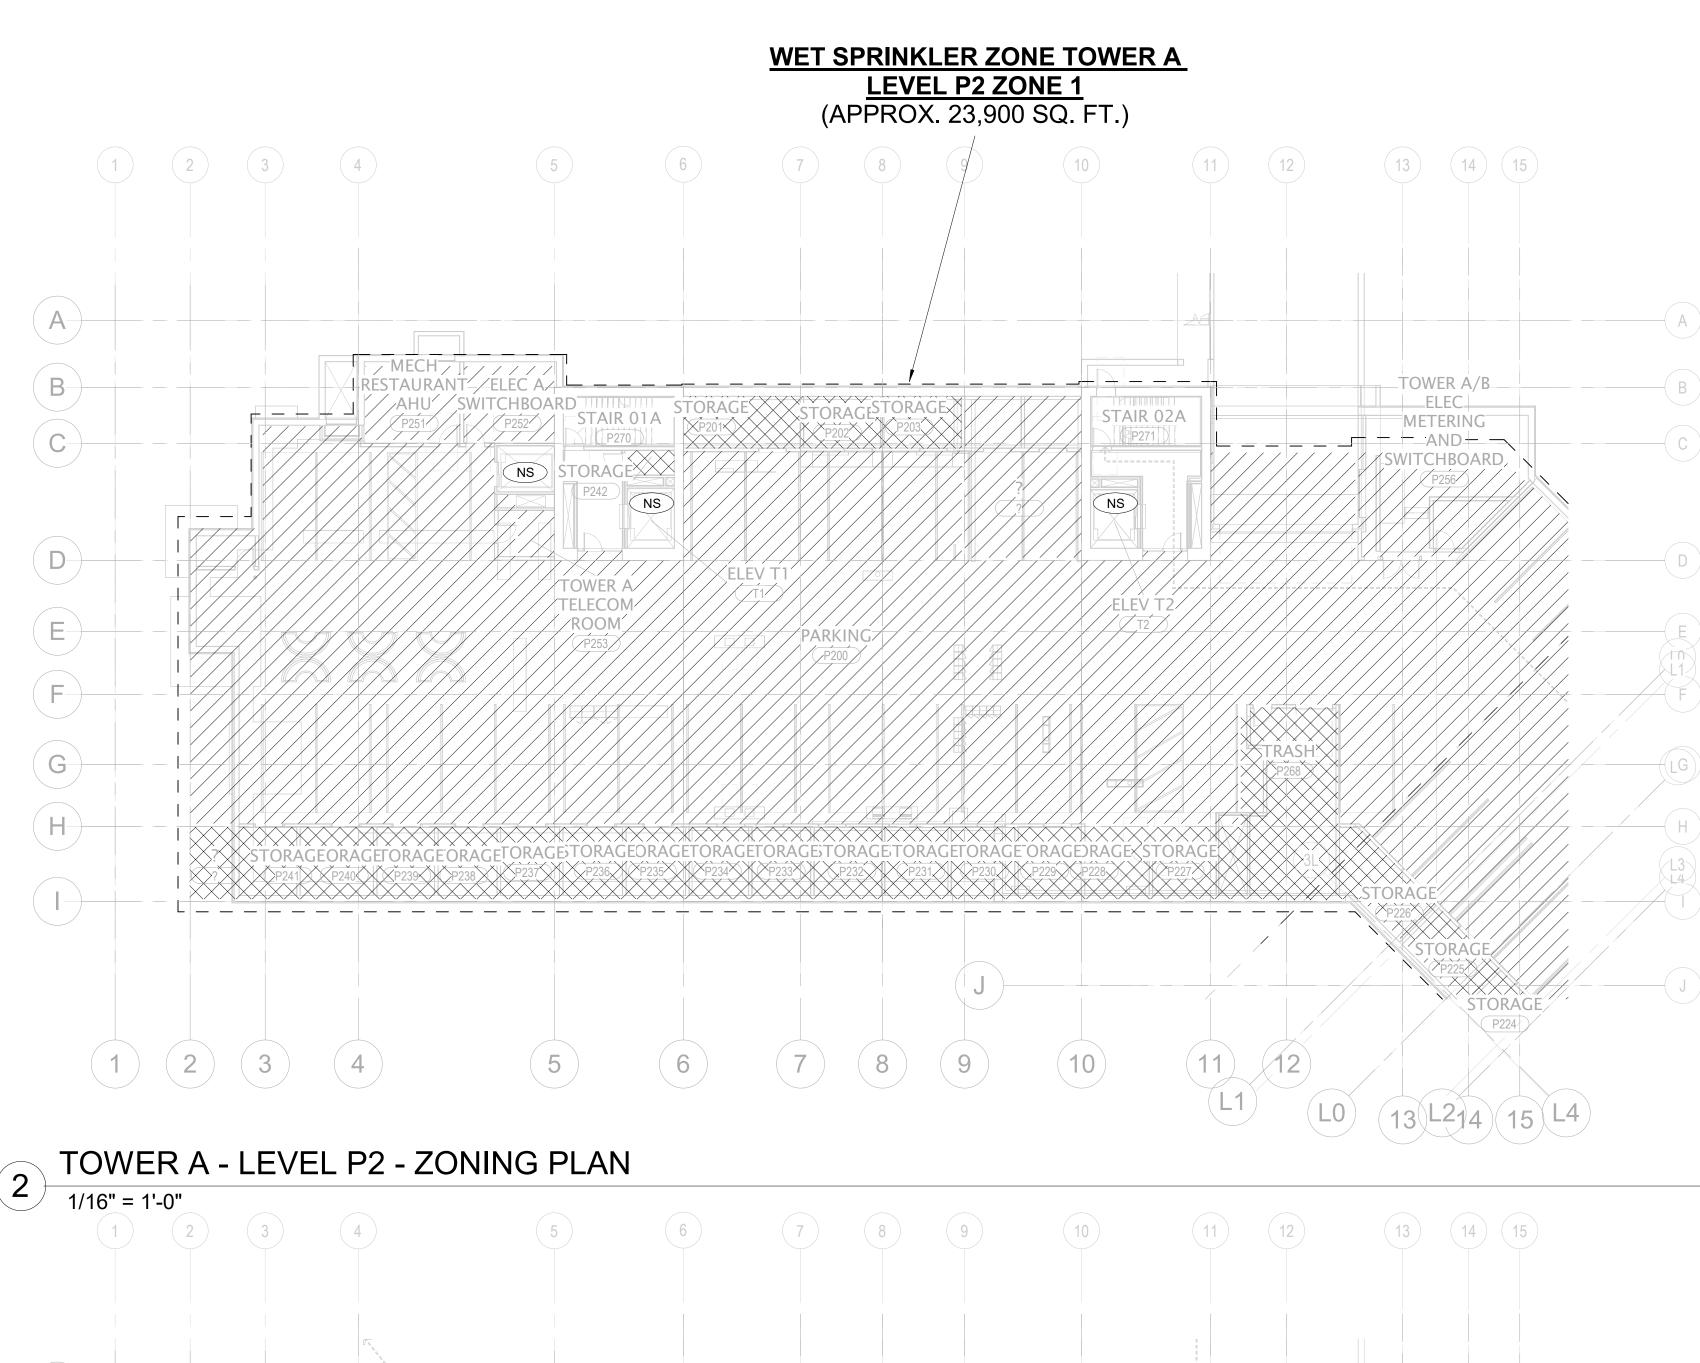

TOWER A - LEVEL 1 - ZONING PLAN

1/16" = 1'-0"

FIRE PROTECTION DESIGN HATCH LEGEND

	LH	LIGHT HAZARD; SYSTEM PROVIDING A DENSITY OF .10 GPM/SQFT. OVER DESIGN AREA OF 1,500 SQ. FT. WITH 100 GPM HOSE ALLOWANCE
	RES	RESIDENTIAL HAZARD; SYSTEM PROVIDING A DENSITY OF .10 GPM/SQFT. OVER DESIGN AREA OF 4 SPRINKLERS. WITH 100 GPM HOSE ALLOWANCE
	OH1	ORDINARY HAZARD GROUP 1; SYSTEM PROVIDING A DENSITY OF .15 GPM/SQFT. OVER DESIGN AREA OF 1,500 SQ. FT. WITH 250 GPM HOSE ALLOWANCE
	OH2	ORDINARY HAZARD GROUP 2; SYSTEM PROVIDING A DENSITY OF .20 GPM/SQFT. OVER DESIGN AREA OF 1,500 SQ. FT. WITH 250 GPM HOSE ALLOWANCE
+ + + + + + + + + + + + + + +	EX1	EXTRA HAZARD GROUP 1; SYSTEM PROVIDING A DENSITY OF .30 GPM/SQFT. OVER DESIGN AREA OF THE ENTIRE ROOM WITH 500 GPM HOSE ALLOWANCE
	NS	NON-SPRINKLERED AREA

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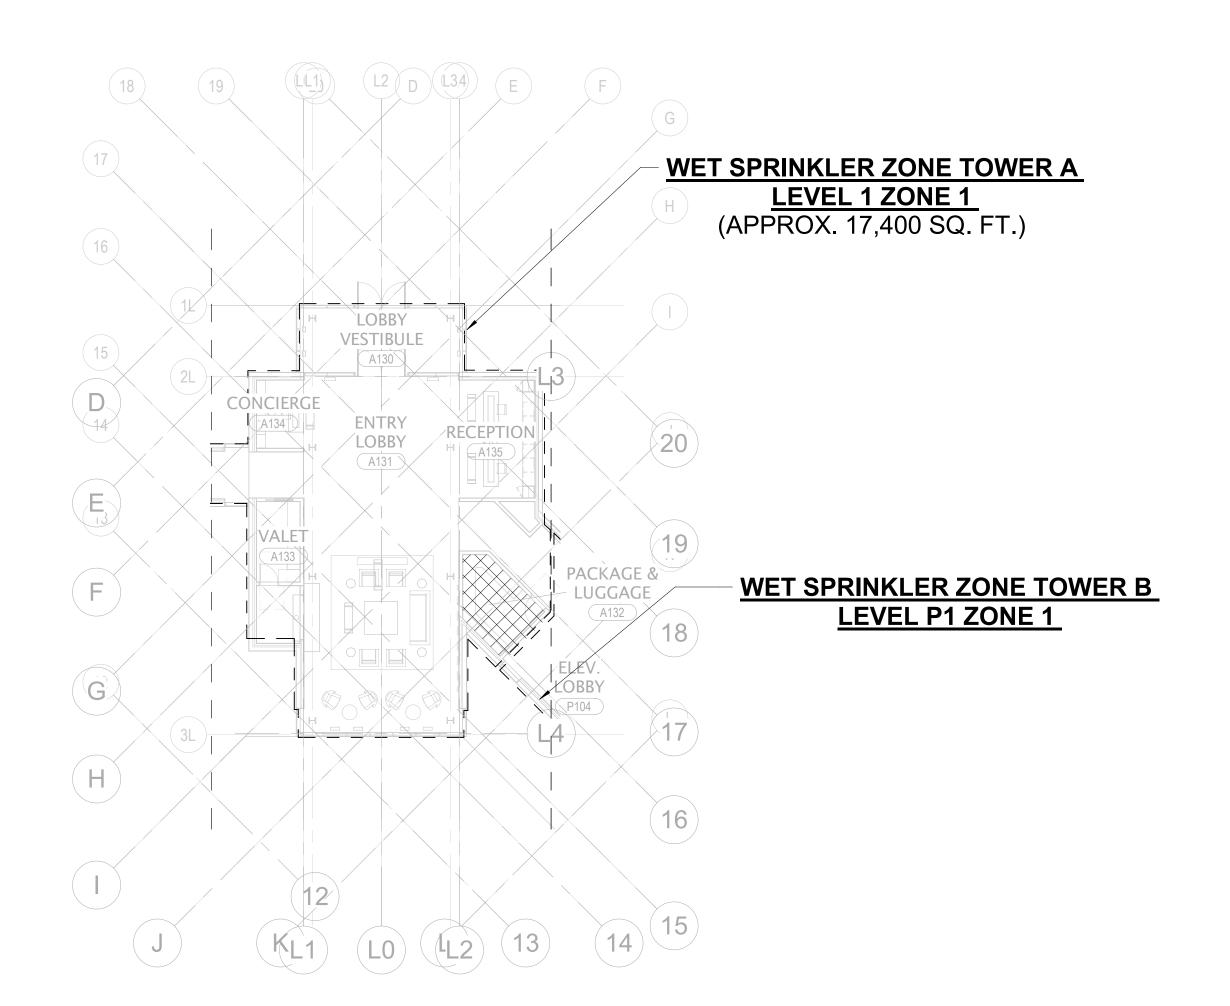
____ principal architect_____ project manager__JCC____ drawn by CRB, SMK checked by Checker

job no. 20052 date 11/18/2022

no. date

ISSUE FOR CONSTRUCTION 11/18/2022

FIRE PROTECTION -TOWER A - ZONING **PLANS**



TOWER AB LOBBY - LEVEL 1 - ZONING PLAN

TOWER A - LEVEL 3 - ZONING PLAN

1/16" = 1'-0"

WET SPRINKLER ZONE TOWER A **LEVEL 3 ZONE 1** (APPROX. 7,500 SQ. FT.) STAIR 01A PATH 3 | A301 | CLOSET CORRIDOR OF 195 CORRIDO WET SPRINKLER ZONE TOWER A **LEVEL 3 ZONE 1** (APPROX. 8,100 SQ. FT.)

WET SPRINKLER ZONE TOWER A **LEVEL 2 ZONE 2** STAIR 01A

BED 2 o c 6 BED 25 0 (A204) LIVING O DEN O O DENTRY O O O O O DENTRY O DENTRY O O O O O DENTRY O DENTRY O DENTRY O O O O O DENTRY O POWDER

STAIR 01B


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BED 1

BE OOOOO E.06 OOOO LIVING OOO BED 1 OB.04 POOE? OO LIVINGO OOO BATH OOO BATH 27 0 0 0 0 0 0 0 0 0 0 0 0 0 WET SPRINKLER ZONE TOWER A **LEVEL 2 ZONE 1** (APPROX. 8,100 SQ. FT.)

2 TOWER A - LEVEL 2 - ZONING PLAN

1/16" = 1'-0"

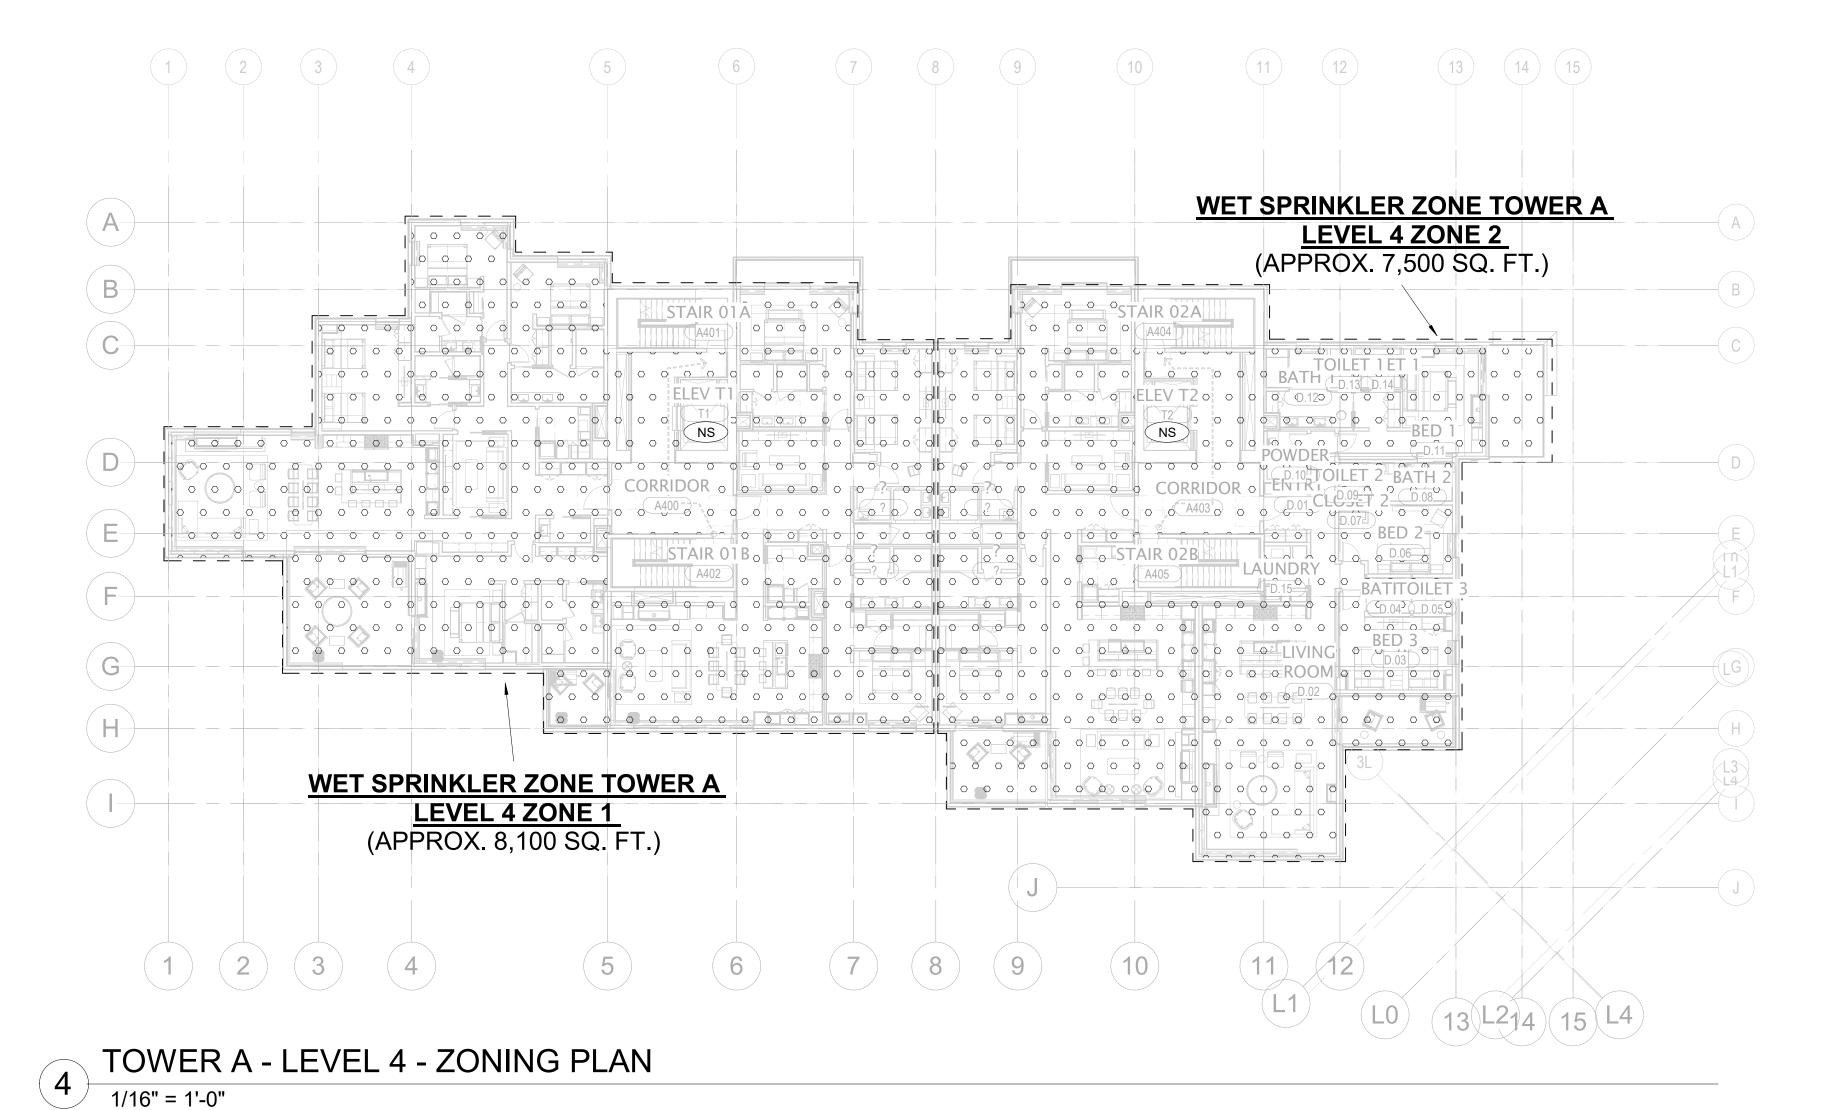

FIRE PROTECTION DESIGN HATCH LEGEND

	LH	LIGHT HAZARD; SYSTEM PROVIDING A DENSITY OF .10 GPM/SQFT. OVER DESIGN AREA OF 1,500 SQ. FT. WITH 100 GPM HOSE ALLOWANCE
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	OH2	ORDINARY HAZARD GROUP 2; SYSTEM PROVIDING A DENSITY OF .20 GPM/SQFT. OVER DESIGN AREA OF 1,500 SQ. FT. WITH 250 GPM HOSE ALLOWANCE
+ + + + + + + + + + + + + + + + + + + +	EX1	EXTRA HAZARD GROUP 1; SYSTEM PROVIDING A DENSITY OF .30 GPM/SQFT. OVER DESIGN AREA OF THE ENTIRE ROOM WITH 500 GPM HOSE ALLOWANCE
	NS	NON-SPRINKLERED AREA

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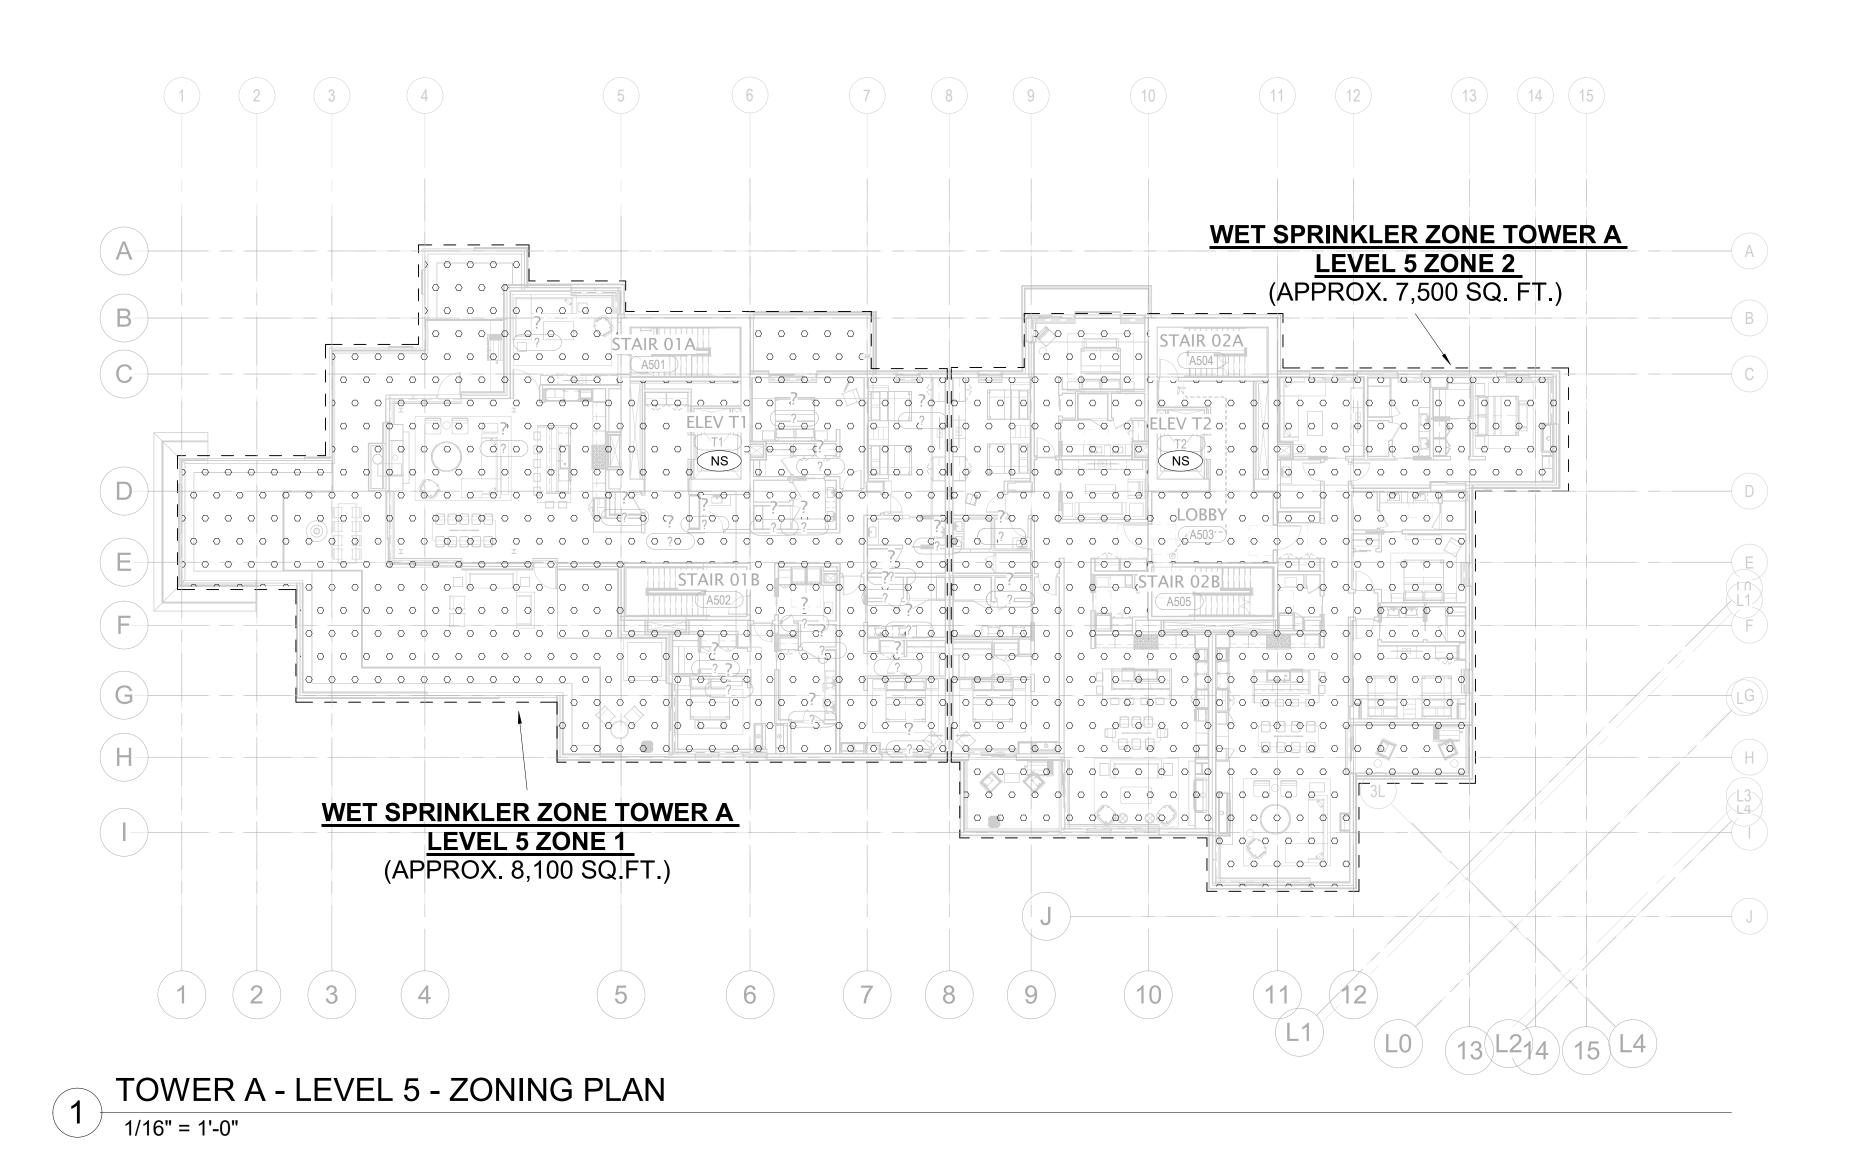
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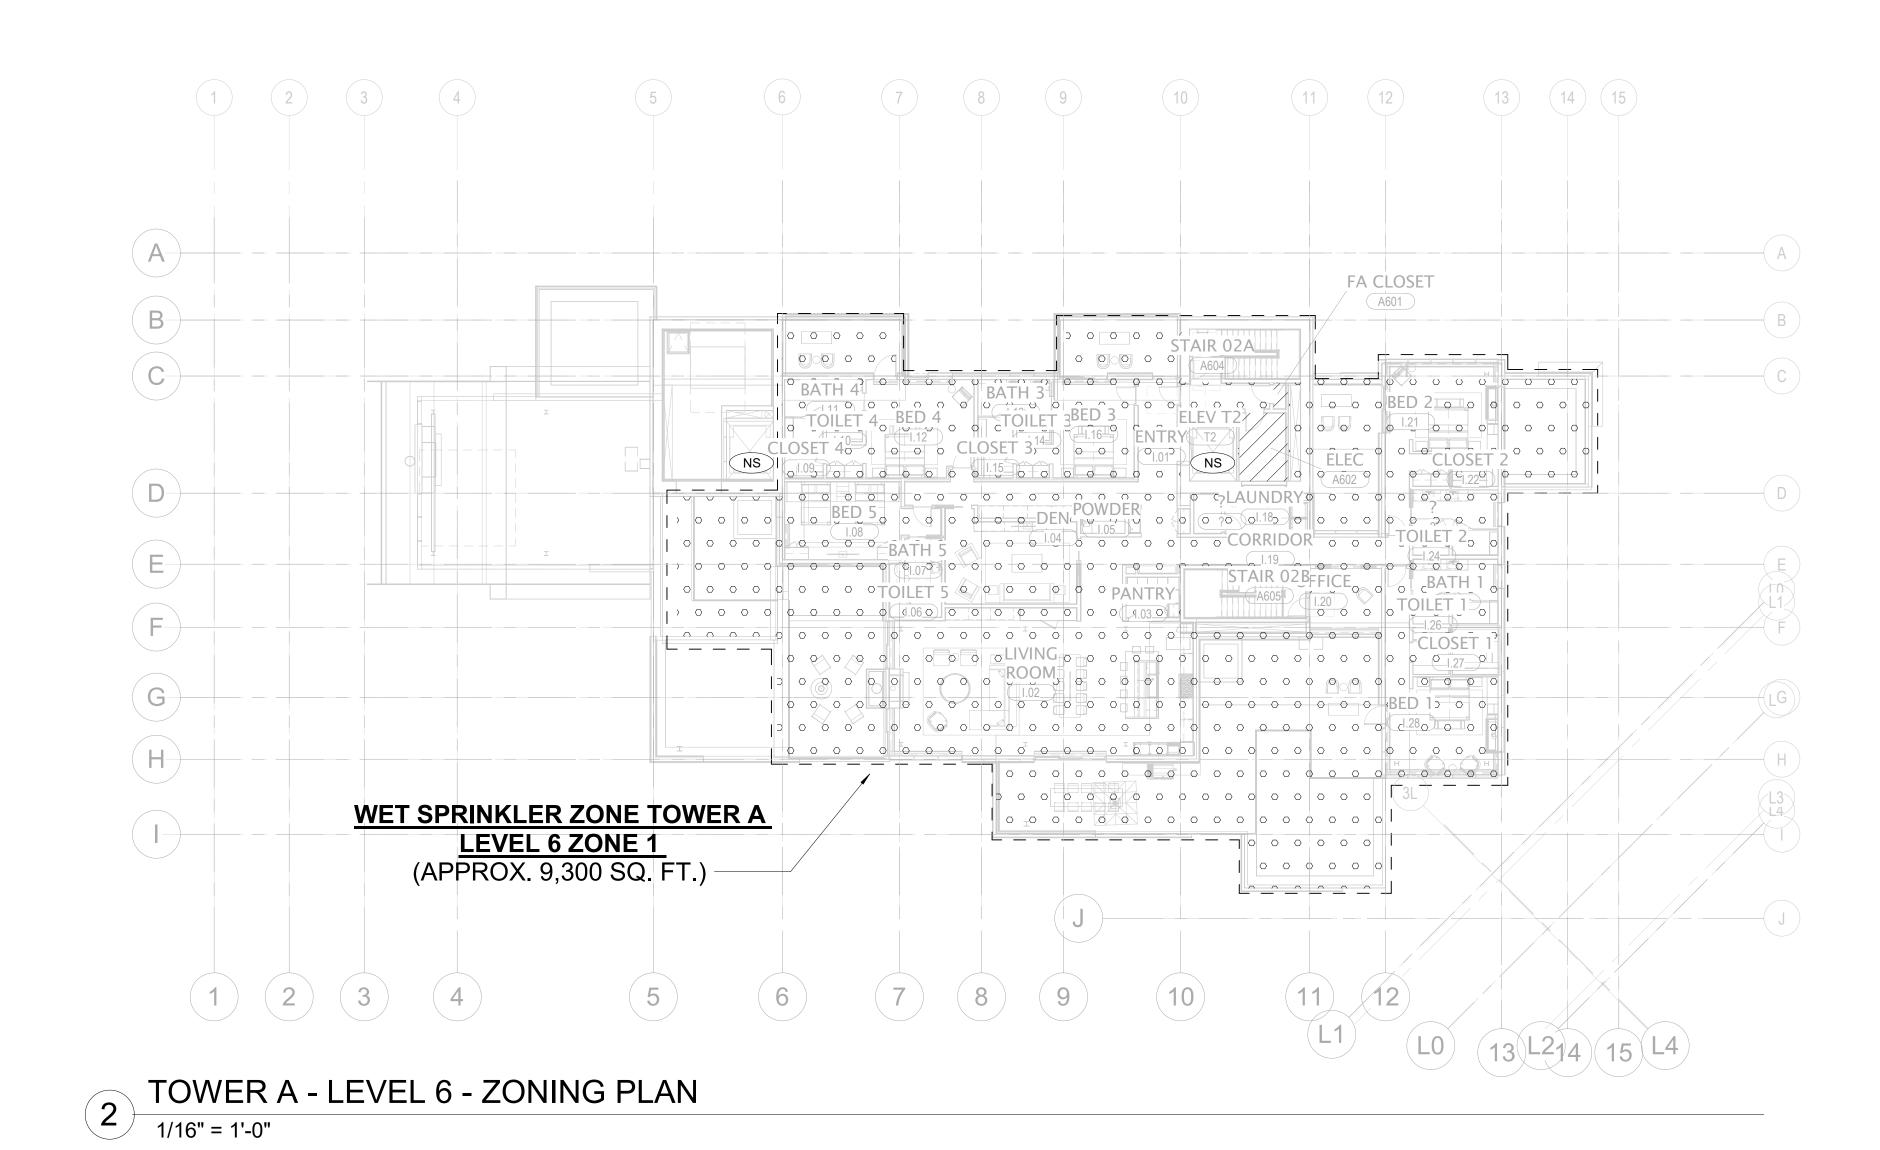
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no. date

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FIRE PROTECTION TOWER A - ZONING **PLANS**





Middlebury, VT Code Consultant Holmes

FIRE PROTECTION DESIGN HATCH LEGEND

	LH	LIGHT HAZARD; SYSTEM PROVIDING A DENSITY OF .10 GPM/SQI OVER DESIGN AREA OF 1,500 SQ. FT. WITH 100 GPM HOSE ALLOWANCE
	RES	RESIDENTIAL HAZARD; SYSTEM PROVIDING A DENSITY OF .10 GPM/SQFT. OVER DESIGN AREA OF 4 SPRINKLERS. WITH 100 GF HOSE ALLOWANCE
	OH1	ORDINARY HAZARD GROUP 1; SYSTEM PROVIDING A DENSITY OF .15 GPM/SQFT. OVER DESIGN AREA OF 1,500 SQ. FT. WITH 25 GPM HOSE ALLOWANCE
	OH2	ORDINARY HAZARD GROUP 2; SYSTEM PROVIDING A DENSITY OF .20 GPM/SQFT. OVER DESIGN AREA OF 1,500 SQ. FT. WITH 25 GPM HOSE ALLOWANCE
+ + + + + + + + + + + + + + + + + + + +	EX1	EXTRA HAZARD GROUP 1; SYSTEM PROVIDING A DENSITY OF .3 GPM/SQFT. OVER DESIGN AREA OF THE ENTIRE ROOM WITH 50 GPM HOSE ALLOWANCE
	NS	NON-SPRINKLERED AREA

Kundig

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Cloward H20

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Building Envelope Consultant 2101 N 34th St Seattle, WA 98103 Accessibility Consultant
Studio Pacifica



_____ principal architect_____ project manager__JCC____ drawn by CRB, SMK ____ checked by Checker job no. 20052


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FIRE PROTECTION -**TOWER A - ZONING PLANS**



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WSP USA

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principal architect
project manager_JCC

checked by Checker
job no. 20052
drawn by CRB, SMK

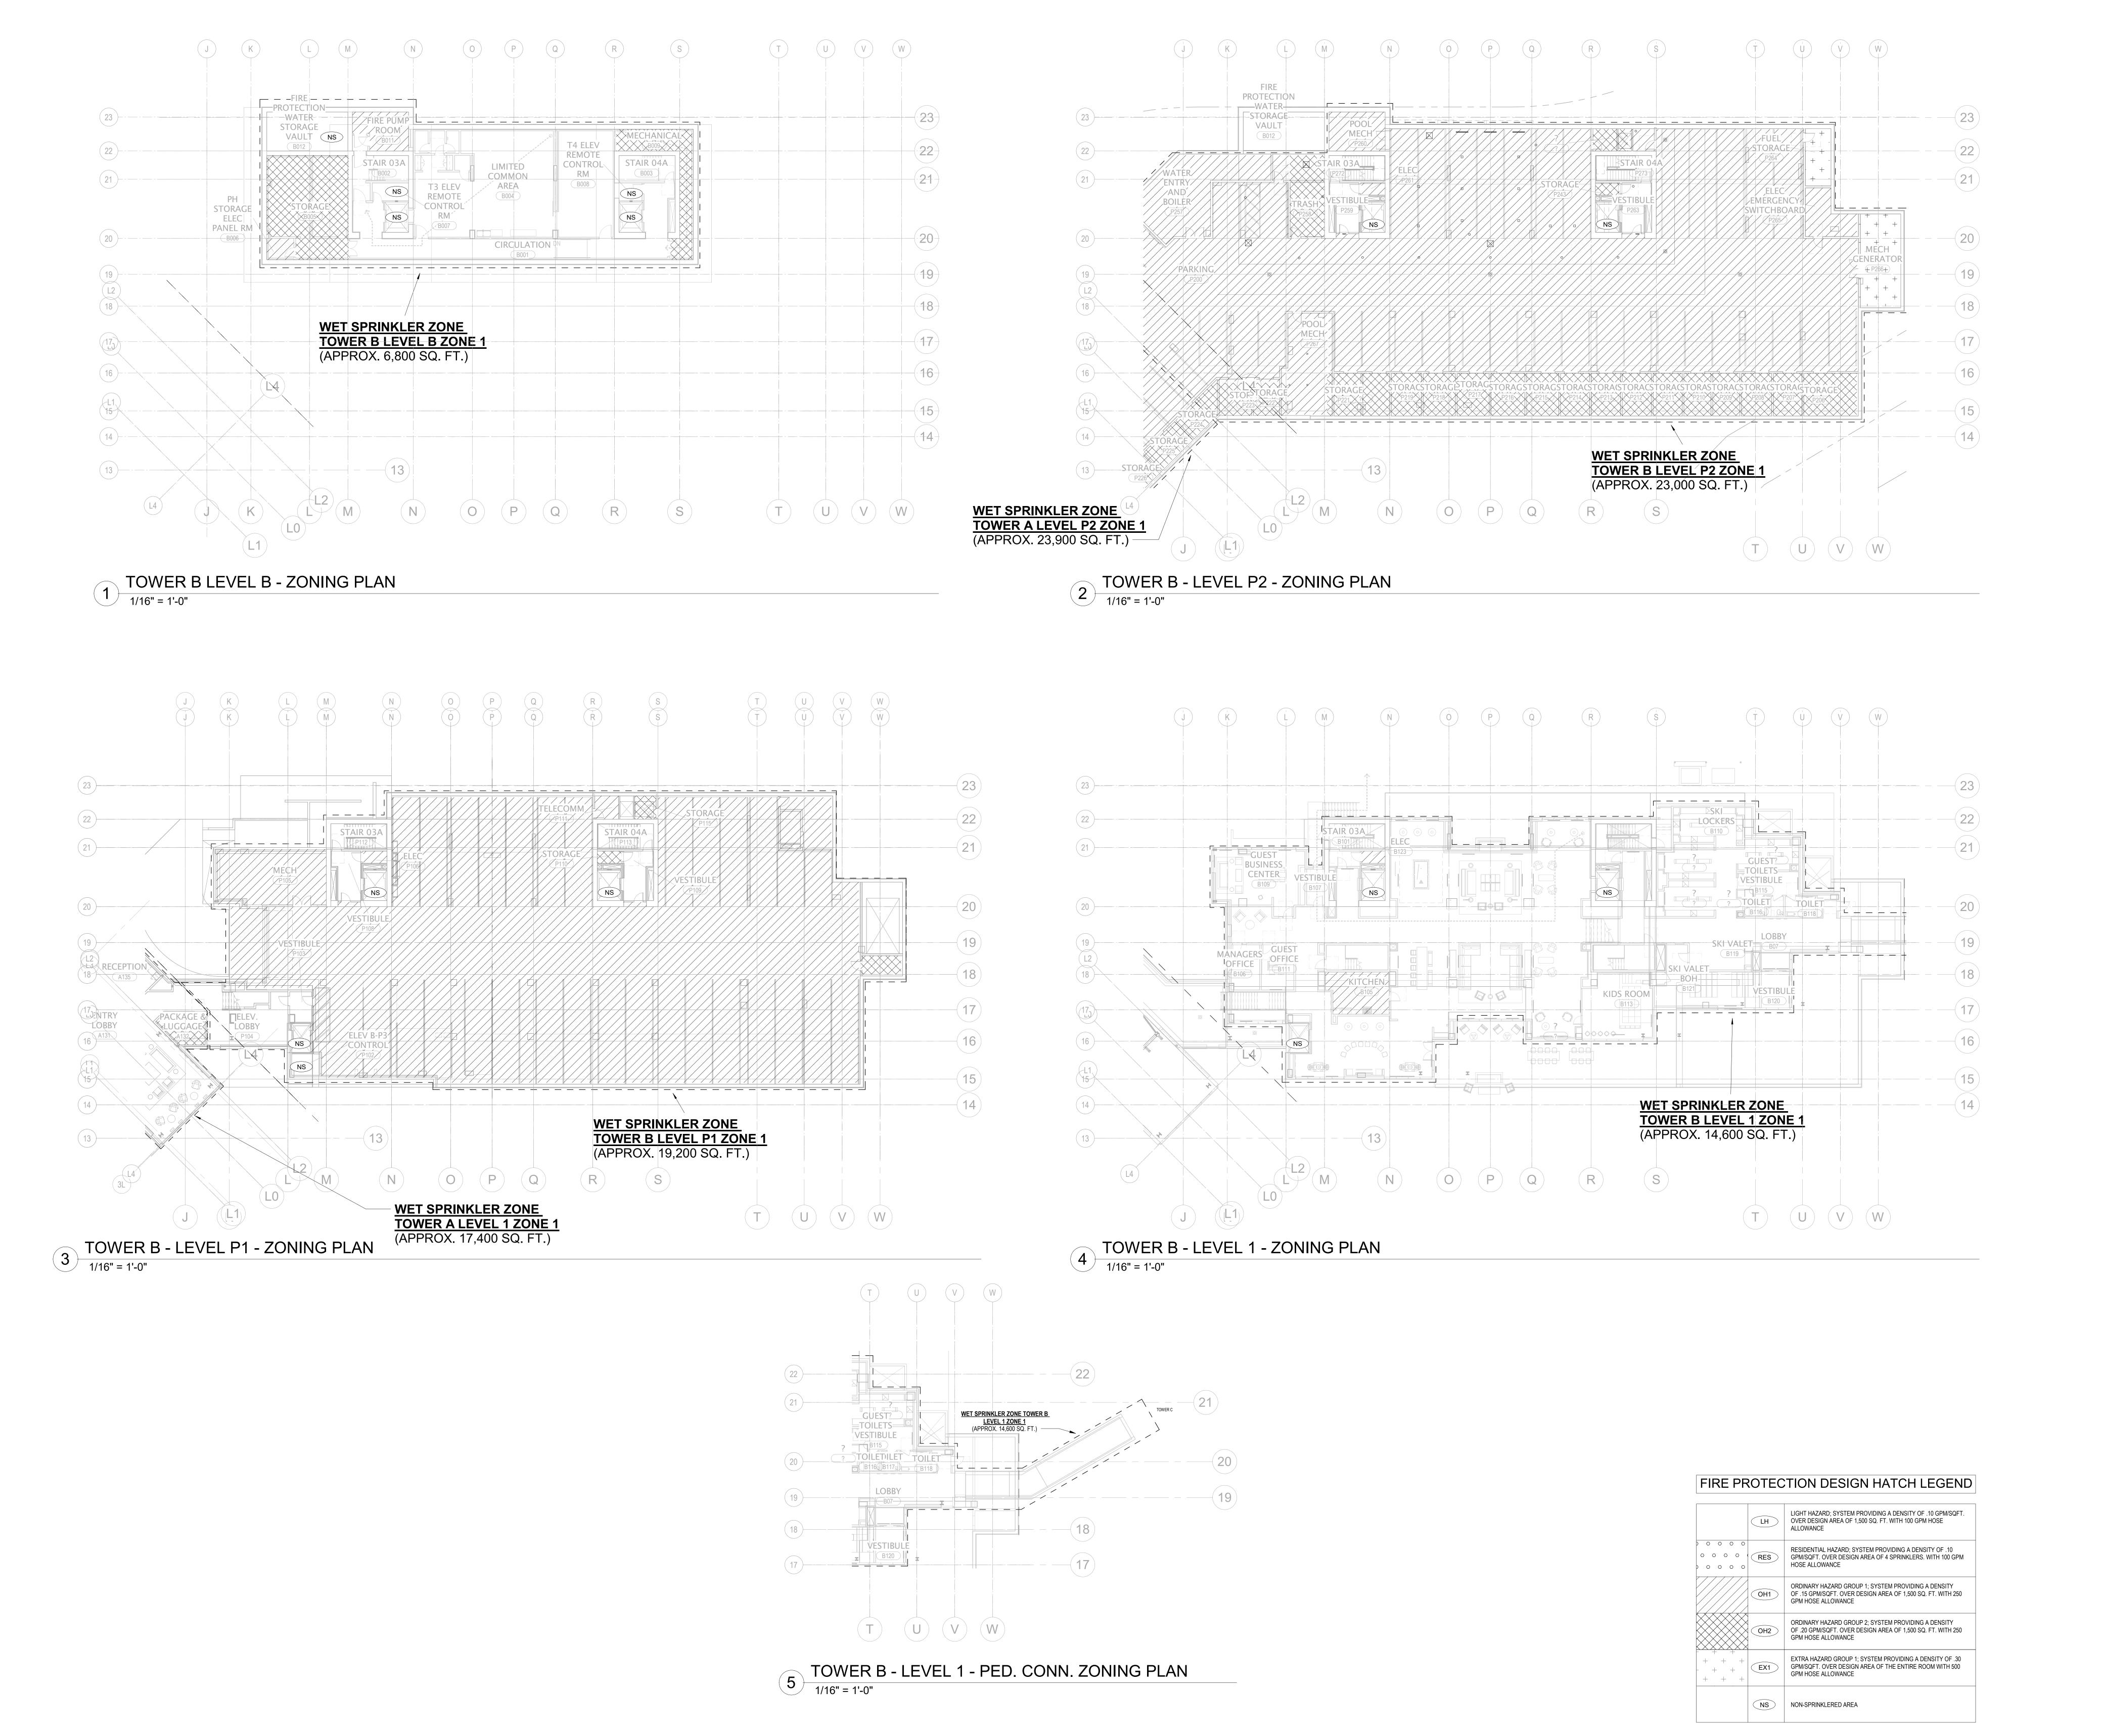
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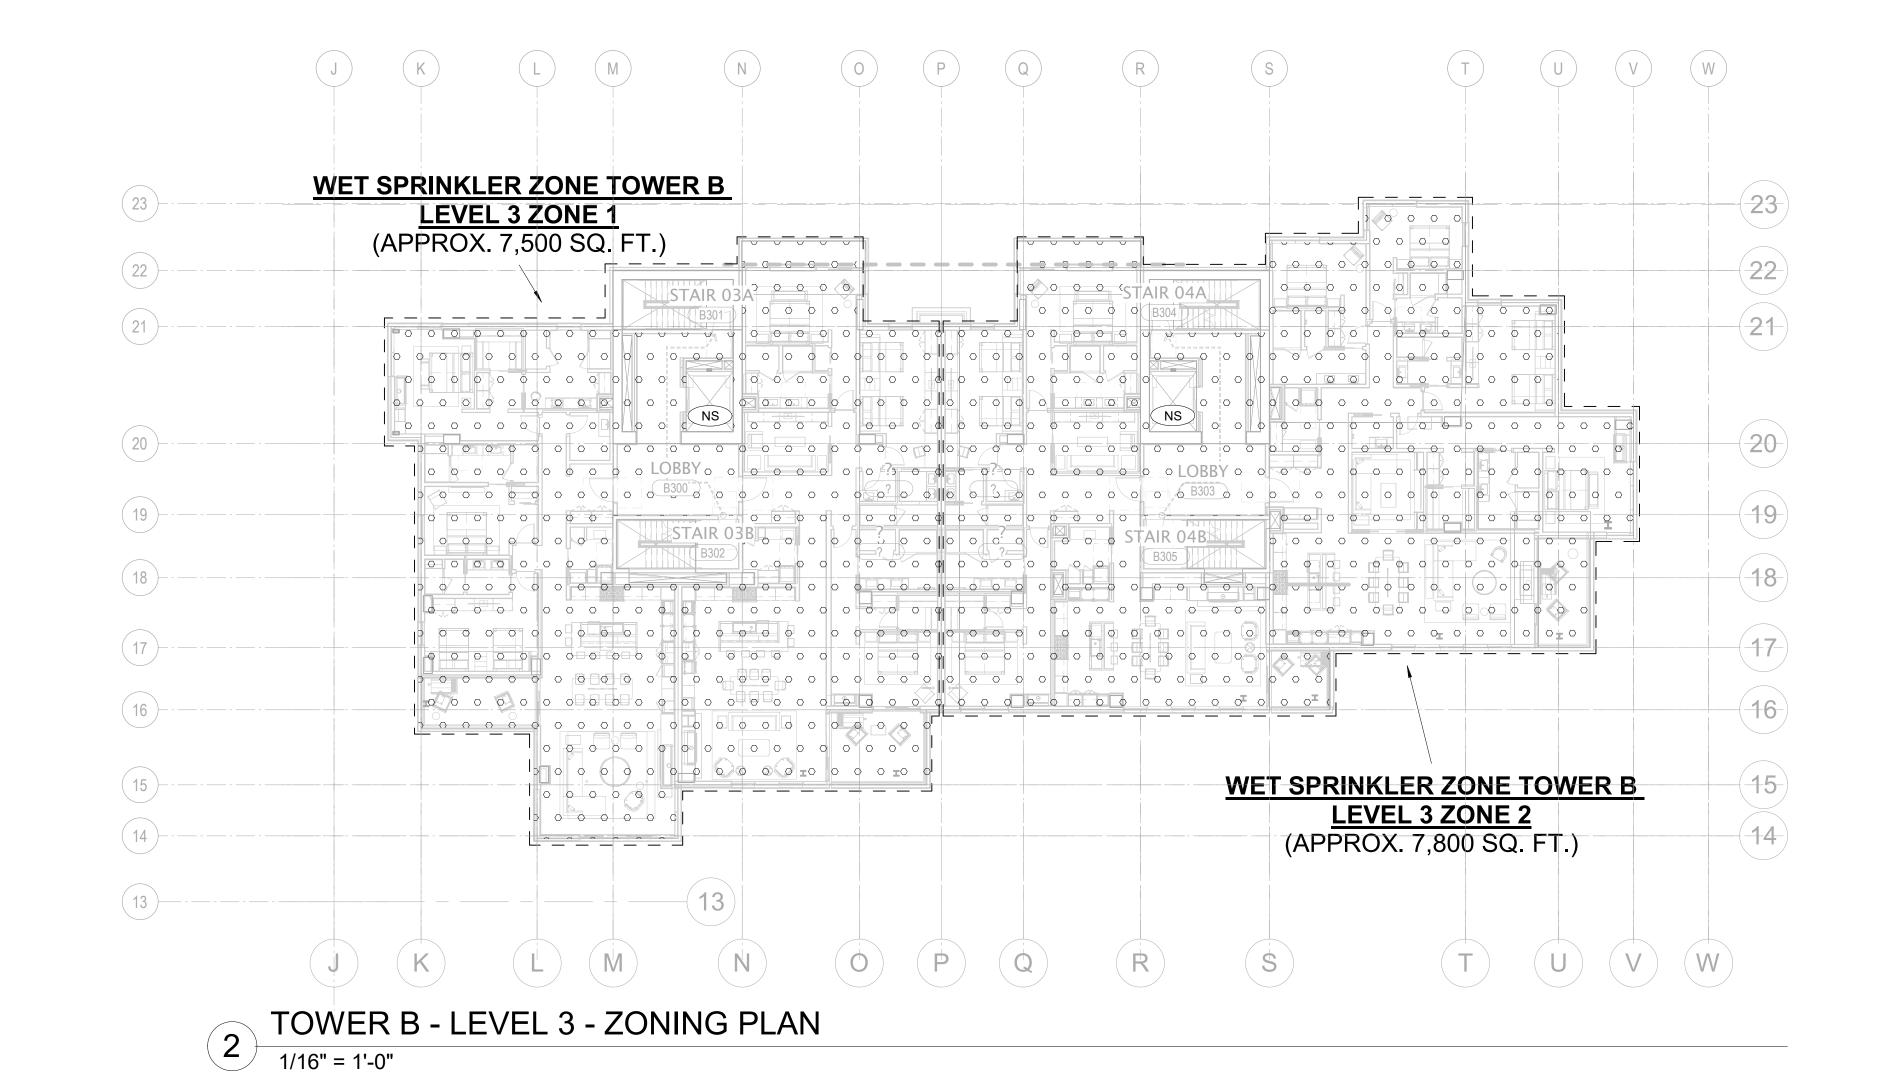
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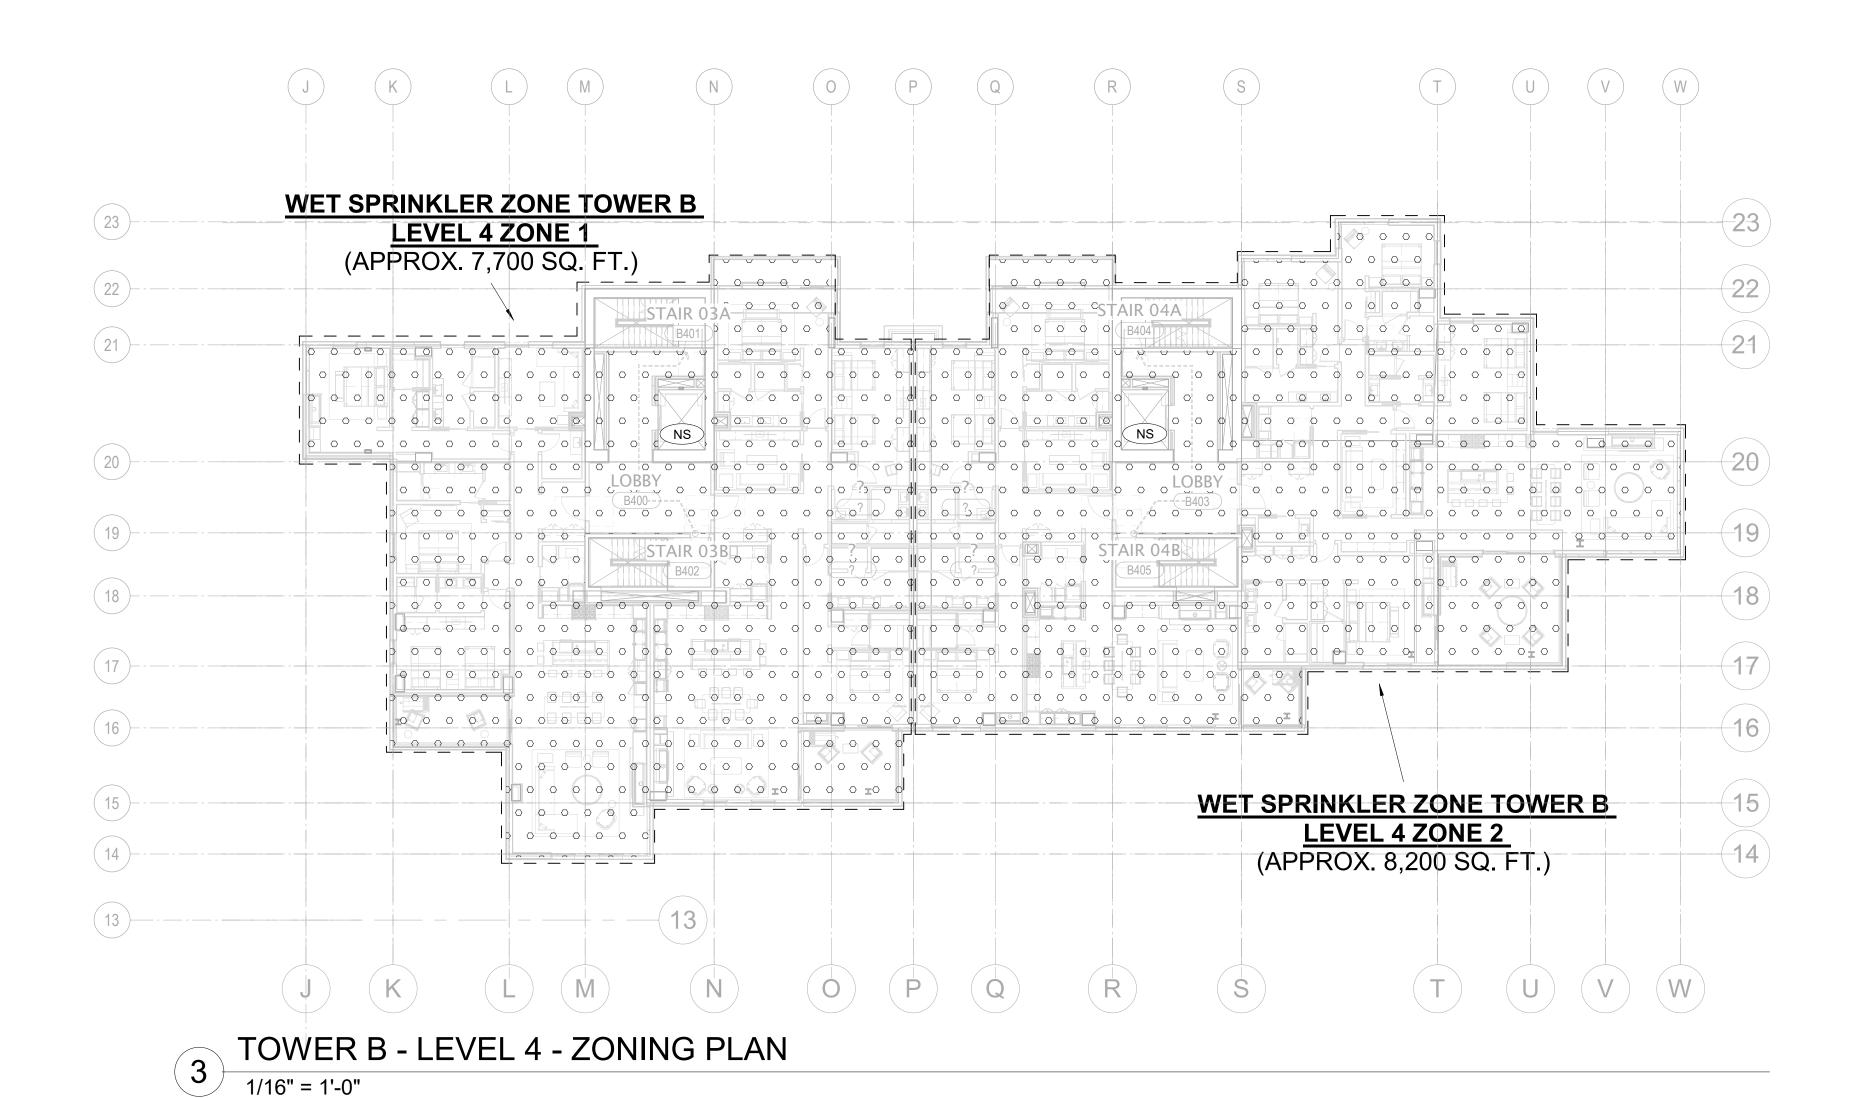
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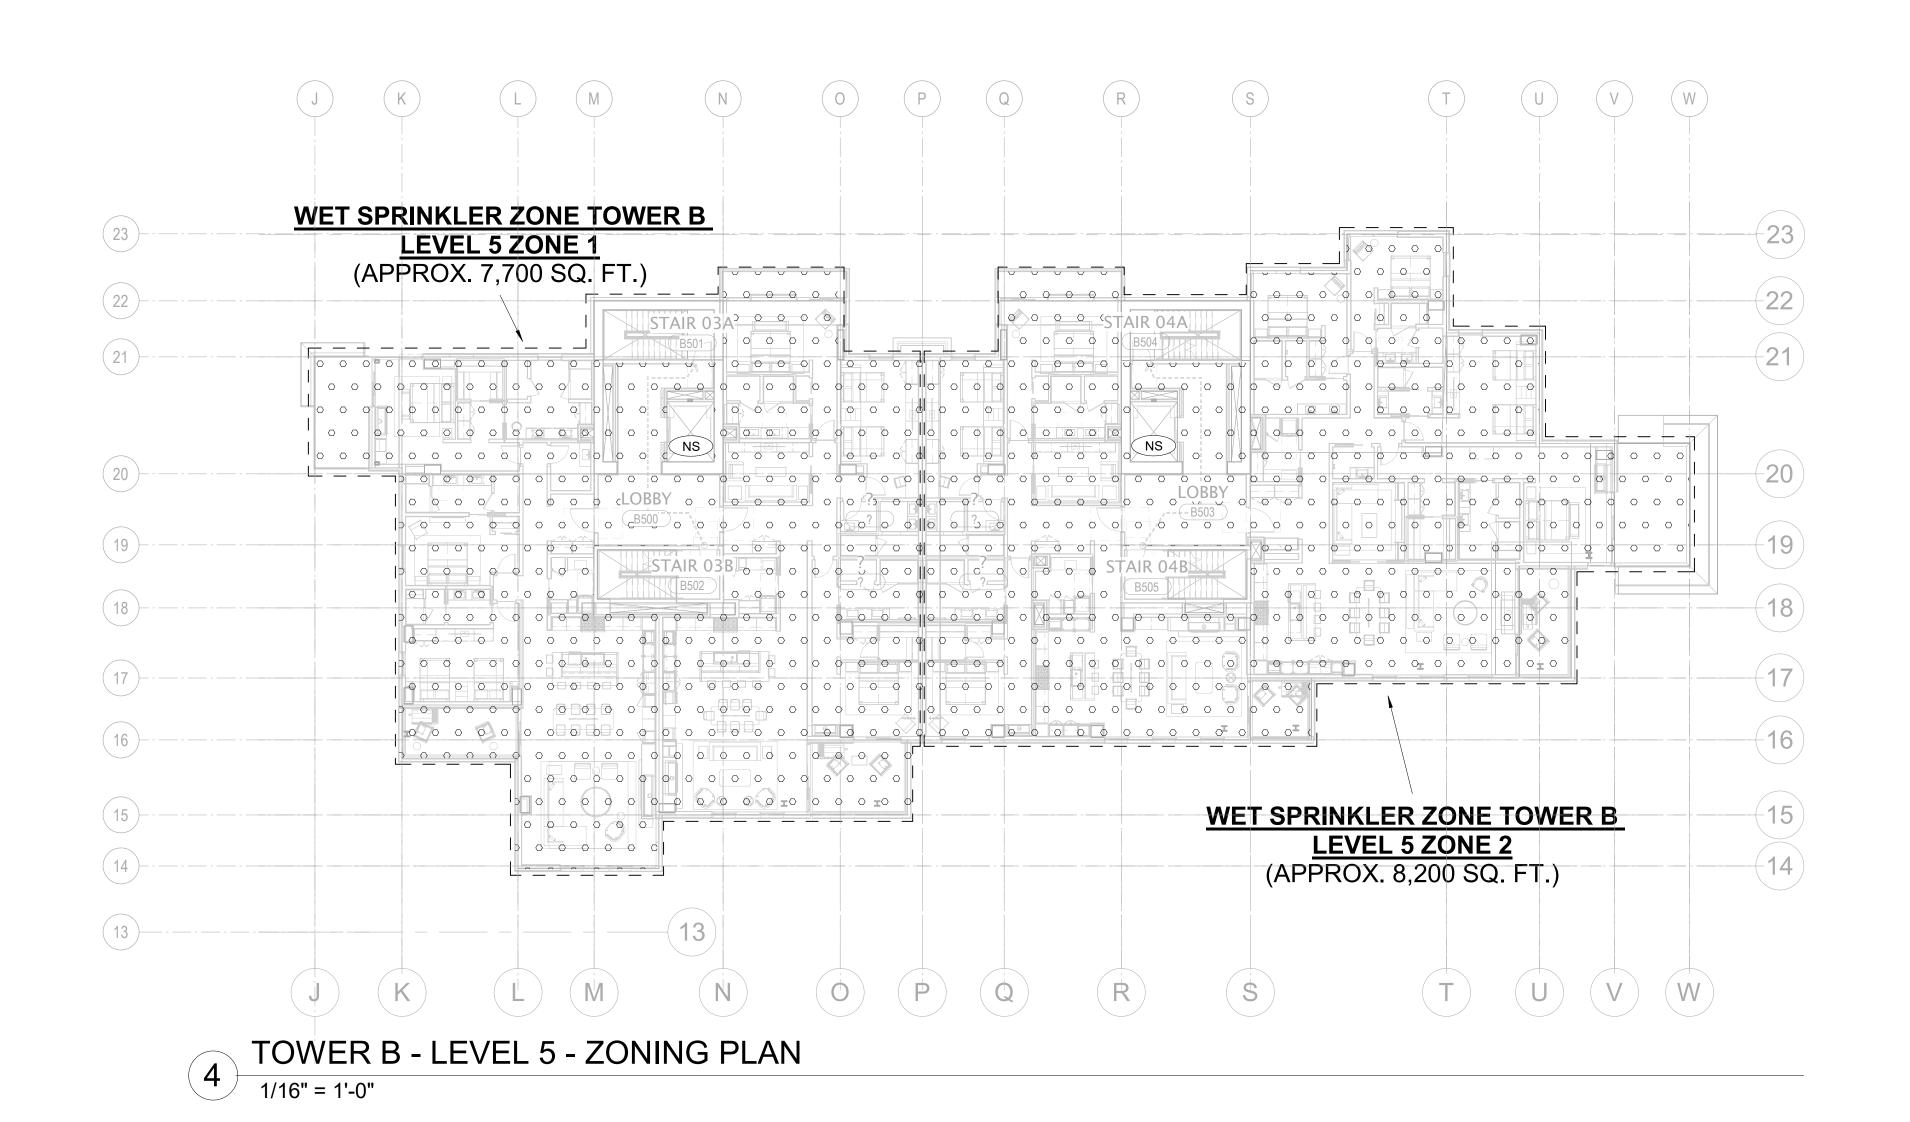
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FIRE PROTECTION -TOWER B - ZONING PLANS







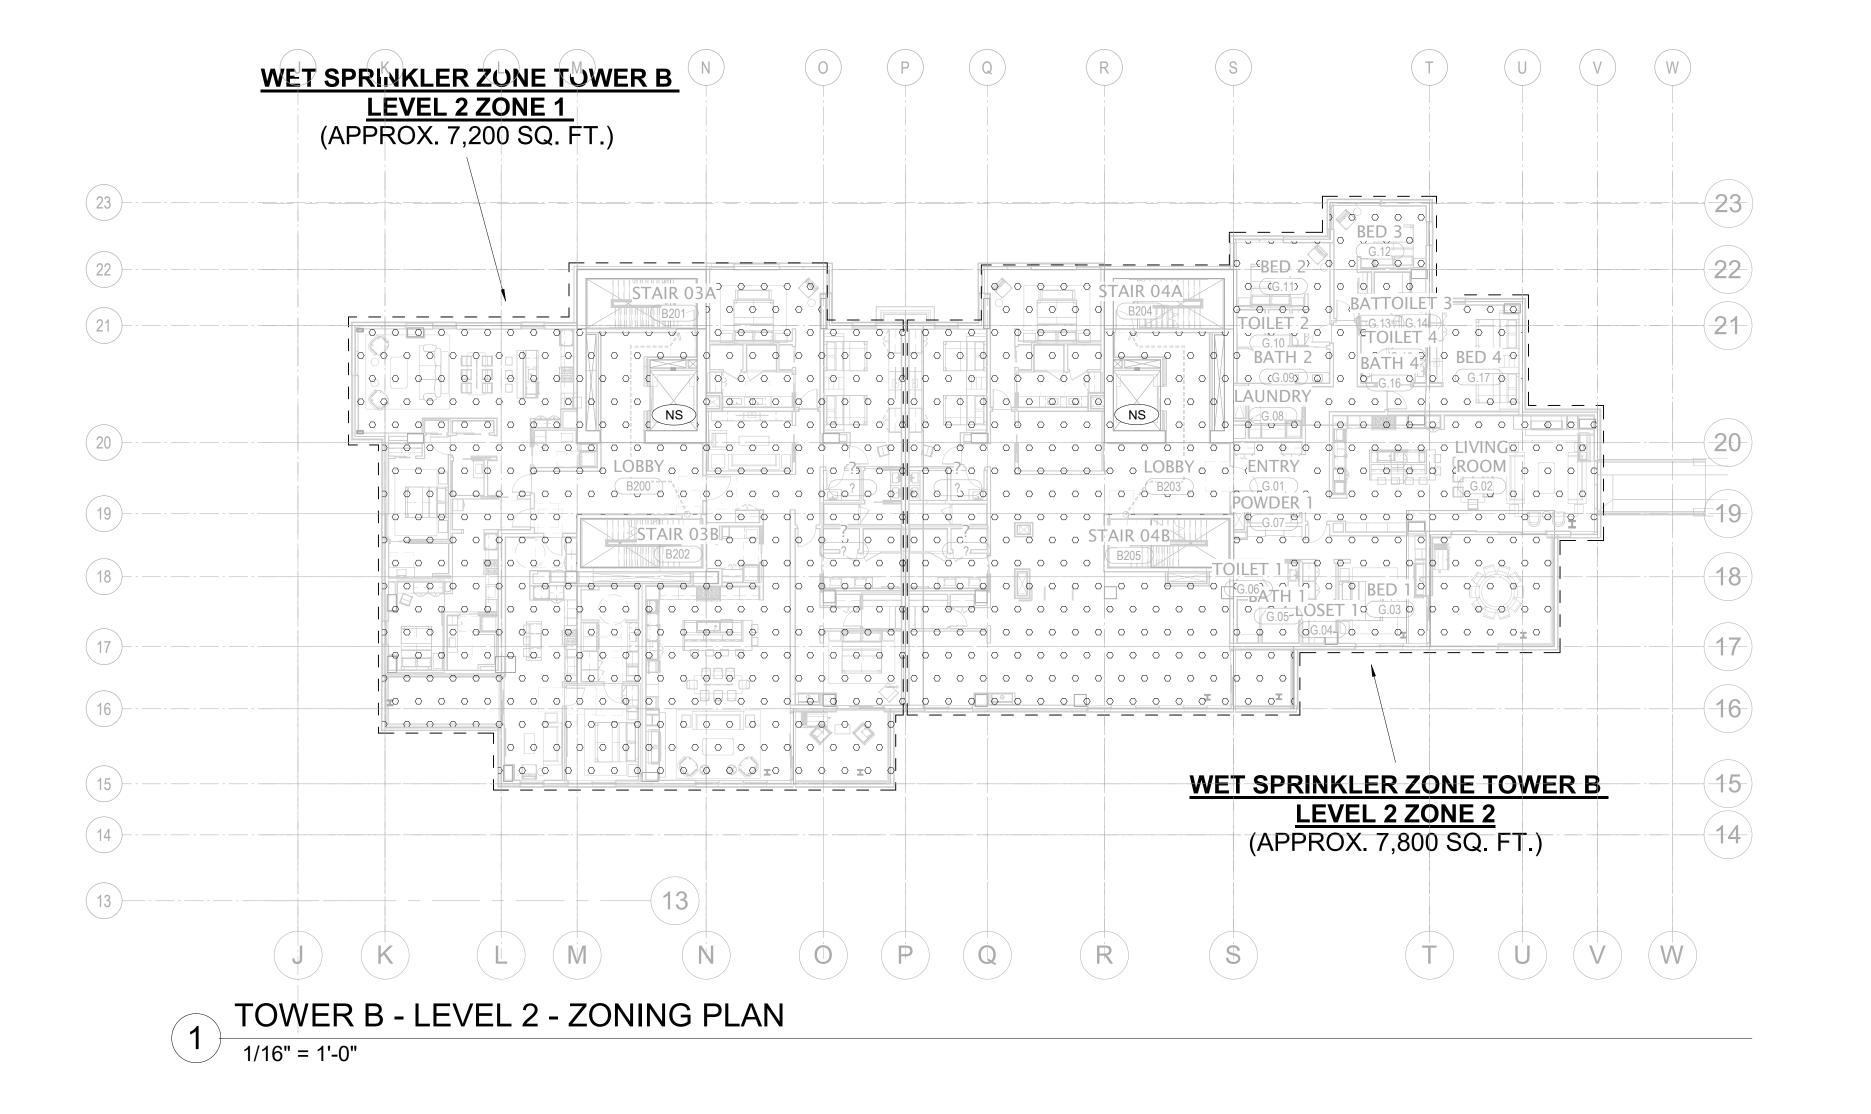

FIRE PR	OTEC	TION DESIGN HATCH LEGEND
	LH	LIGHT HAZARD; SYSTEM PROVIDING A DENSITY OF .10 GPM/SQFT. OVER DESIGN AREA OF 1,500 SQ. FT. WITH 100 GPM HOSE ALLOWANCE
	RES	RESIDENTIAL HAZARD; SYSTEM PROVIDING A DENSITY OF .10 GPM/SQFT. OVER DESIGN AREA OF 4 SPRINKLERS. WITH 100 GPM HOSE ALLOWANCE
	OH1	ORDINARY HAZARD GROUP 1; SYSTEM PROVIDING A DENSITY OF .15 GPM/SQFT. OVER DESIGN AREA OF 1,500 SQ. FT. WITH 250 GPM HOSE ALLOWANCE
	OH2	ORDINARY HAZARD GROUP 2; SYSTEM PROVIDING A DENSITY OF .20 GPM/SQFT. OVER DESIGN AREA OF 1,500 SQ. FT. WITH 250 GPM HOSE ALLOWANCE
+ + + + + + + + + + + + + + + +	EX1	EXTRA HAZARD GROUP 1; SYSTEM PROVIDING A DENSITY OF .30 GPM/SQFT. OVER DESIGN AREA OF THE ENTIRE ROOM WITH 500 GPM HOSE ALLOWANCE
	NS	NON-SPRINKI FRED AREA

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principal architectproject managerJC drawn byCF checked byCF job no. 20 date 11	RB, SMK


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project manager_	JCC
drawn by_	CRB, SMK
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checked by_	Checker
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FIRE PROTECTION -TOWER B - ZONING PLANS

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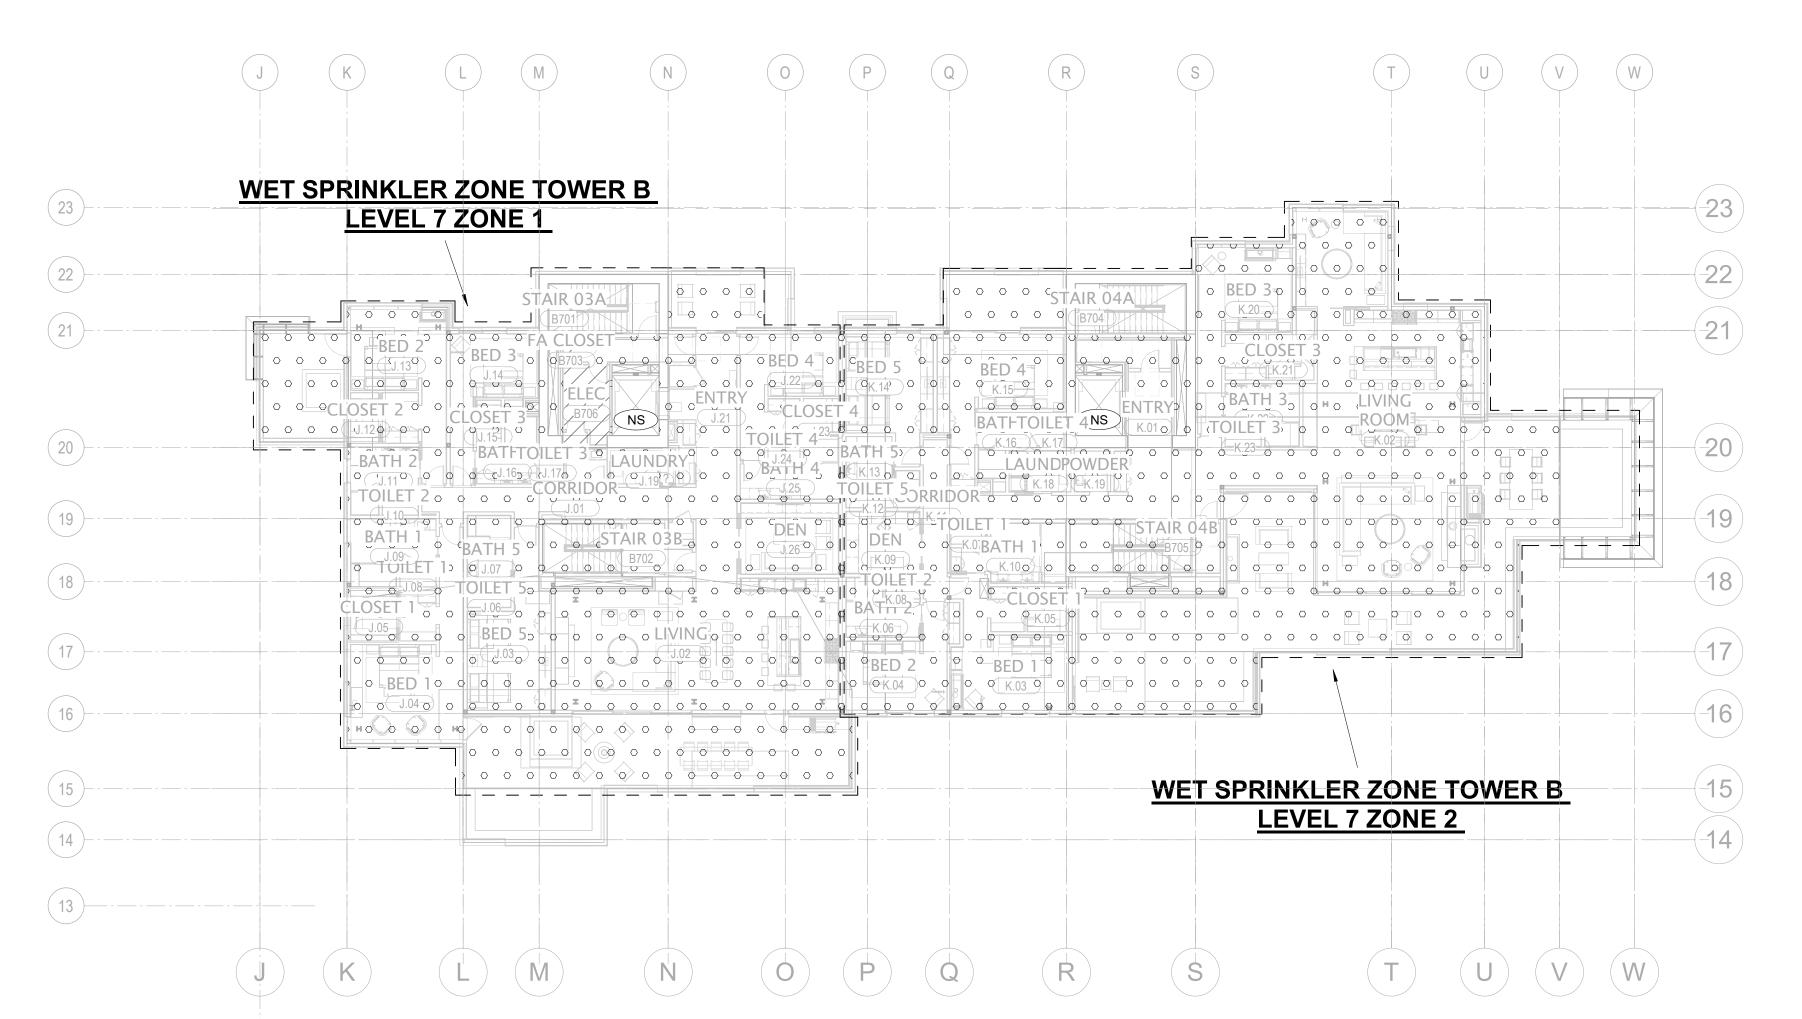
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11/18/2022



TOWER B - LEVEL 6 - ZONING PLAN

1/16" = 1'-0"

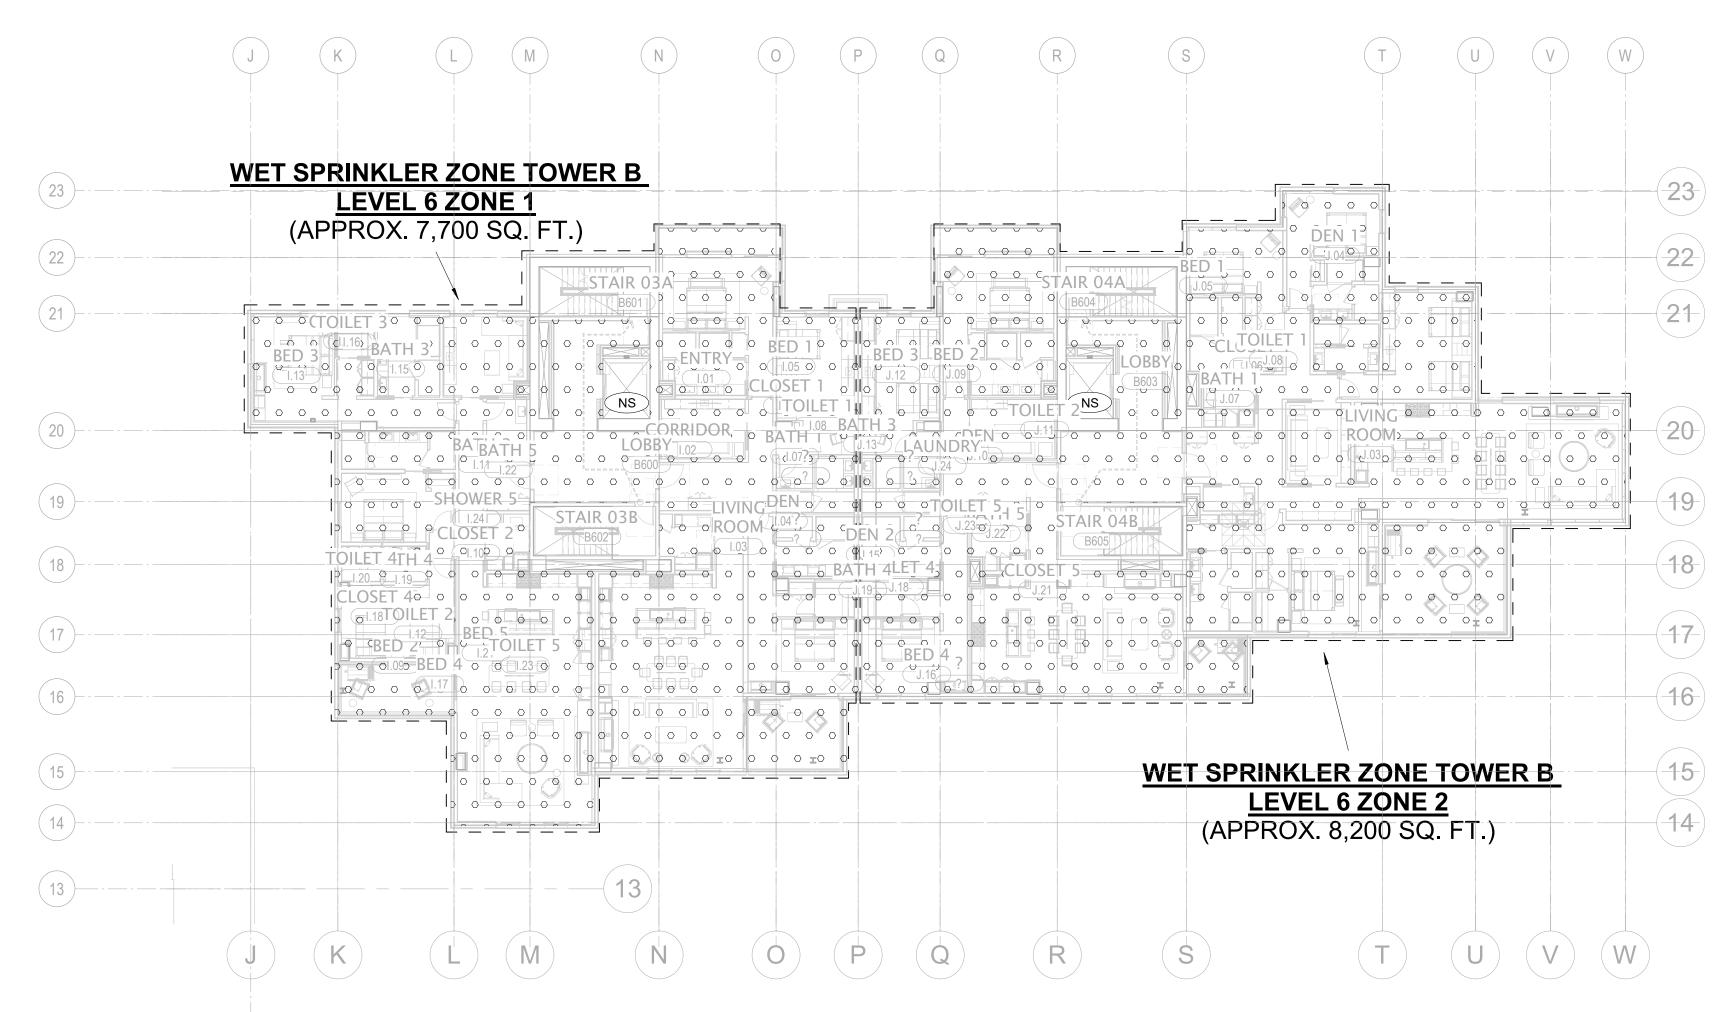

TOWER B - LEVEL 7 - ZONING PLAN

1/16" = 1'-0"


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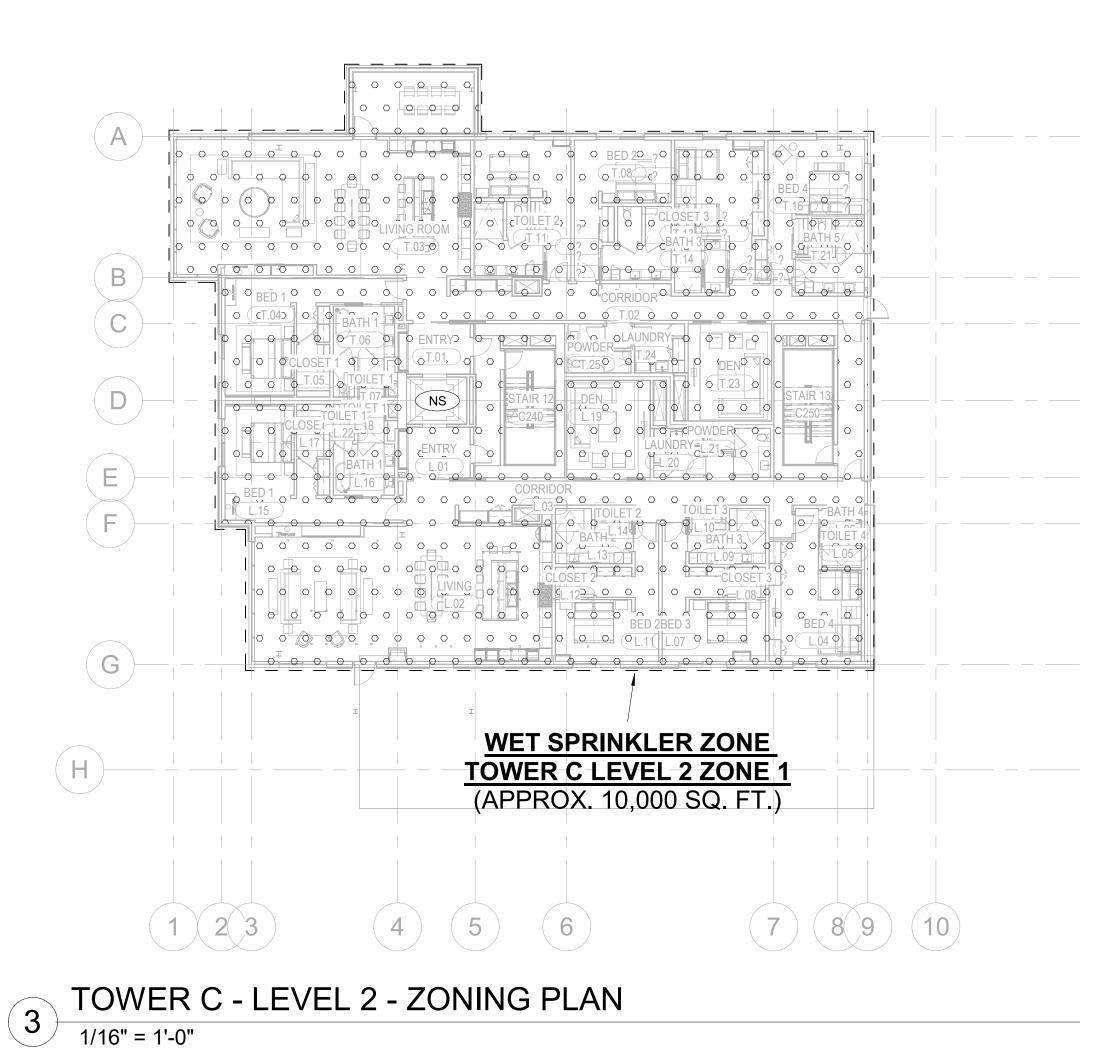
	LH	LIGHT HAZARD; SYSTEM PROVIDING A DENSITY OF .10 GPM/SO OVER DESIGN AREA OF 1,500 SQ. FT. WITH 100 GPM HOSE ALLOWANCE
	RES	RESIDENTIAL HAZARD; SYSTEM PROVIDING A DENSITY OF .10 GPM/SQFT. OVER DESIGN AREA OF 4 SPRINKLERS. WITH 100 C HOSE ALLOWANCE
	OH1	ORDINARY HAZARD GROUP 1; SYSTEM PROVIDING A DENSITY OF .15 GPM/SQFT. OVER DESIGN AREA OF 1,500 SQ. FT. WITH SECOND HOSE ALLOWANCE
	OH2	ORDINARY HAZARD GROUP 2; SYSTEM PROVIDING A DENSITY OF .20 GPM/SQFT. OVER DESIGN AREA OF 1,500 SQ. FT. WITH SECOND HOSE ALLOWANCE
+ + + + + + + + + + + + + + +	EX1	EXTRA HAZARD GROUP 1; SYSTEM PROVIDING A DENSITY OF GPM/SQFT. OVER DESIGN AREA OF THE ENTIRE ROOM WITH 5 GPM HOSE ALLOWANCE
	NS	NON-SPRINKLERED AREA


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principal architect— project manager—JC drawn by—CF checked by—Cr job no. 20 date 11 revisions:	RB, SMKecker


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project manager_	JCC
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FIRE PROTECTION -TOWER B - ZONING





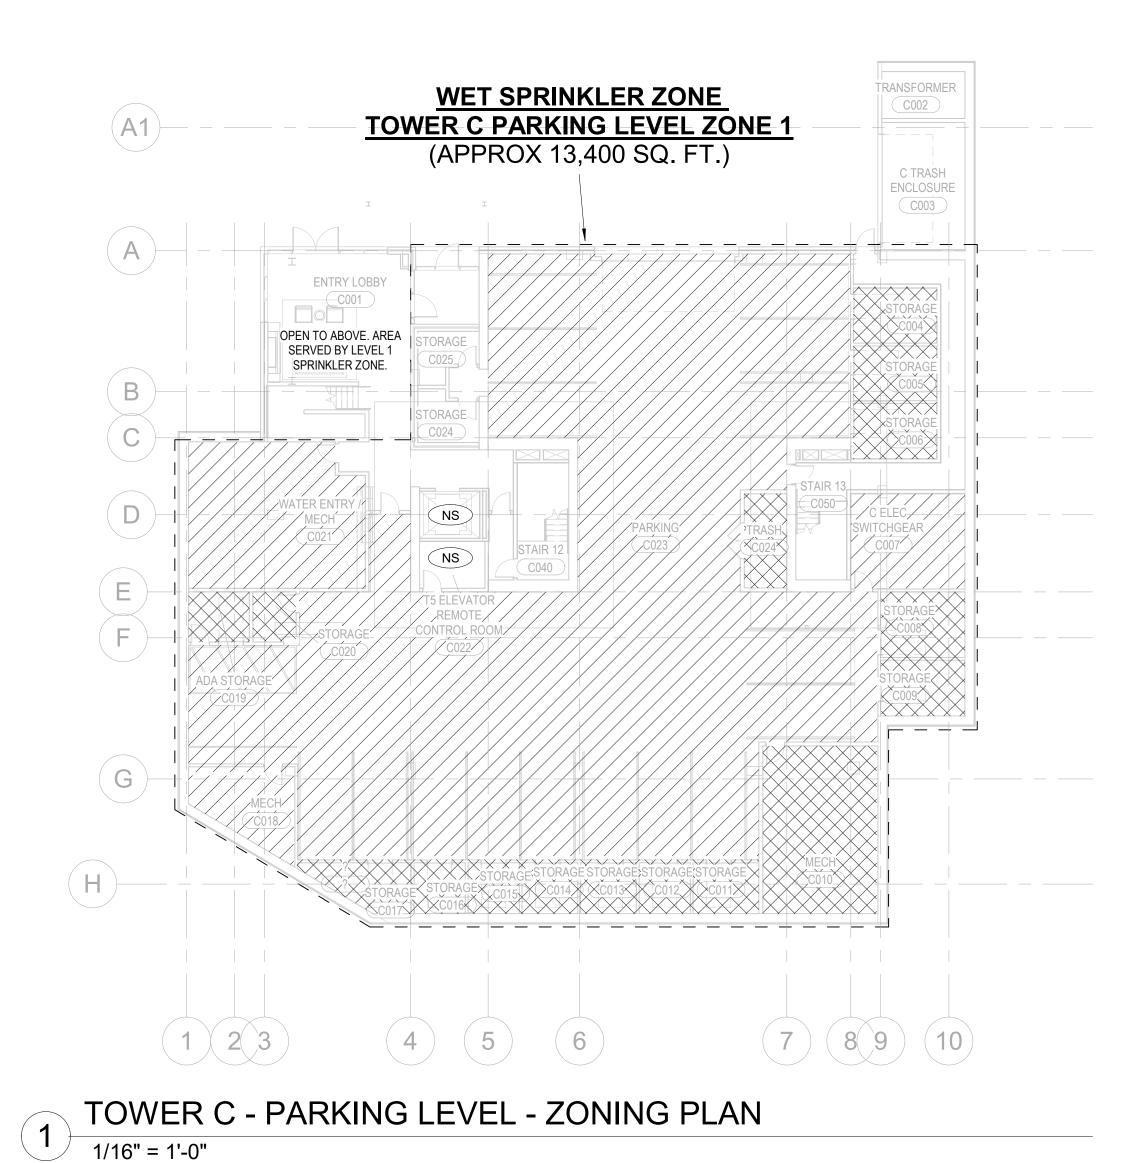

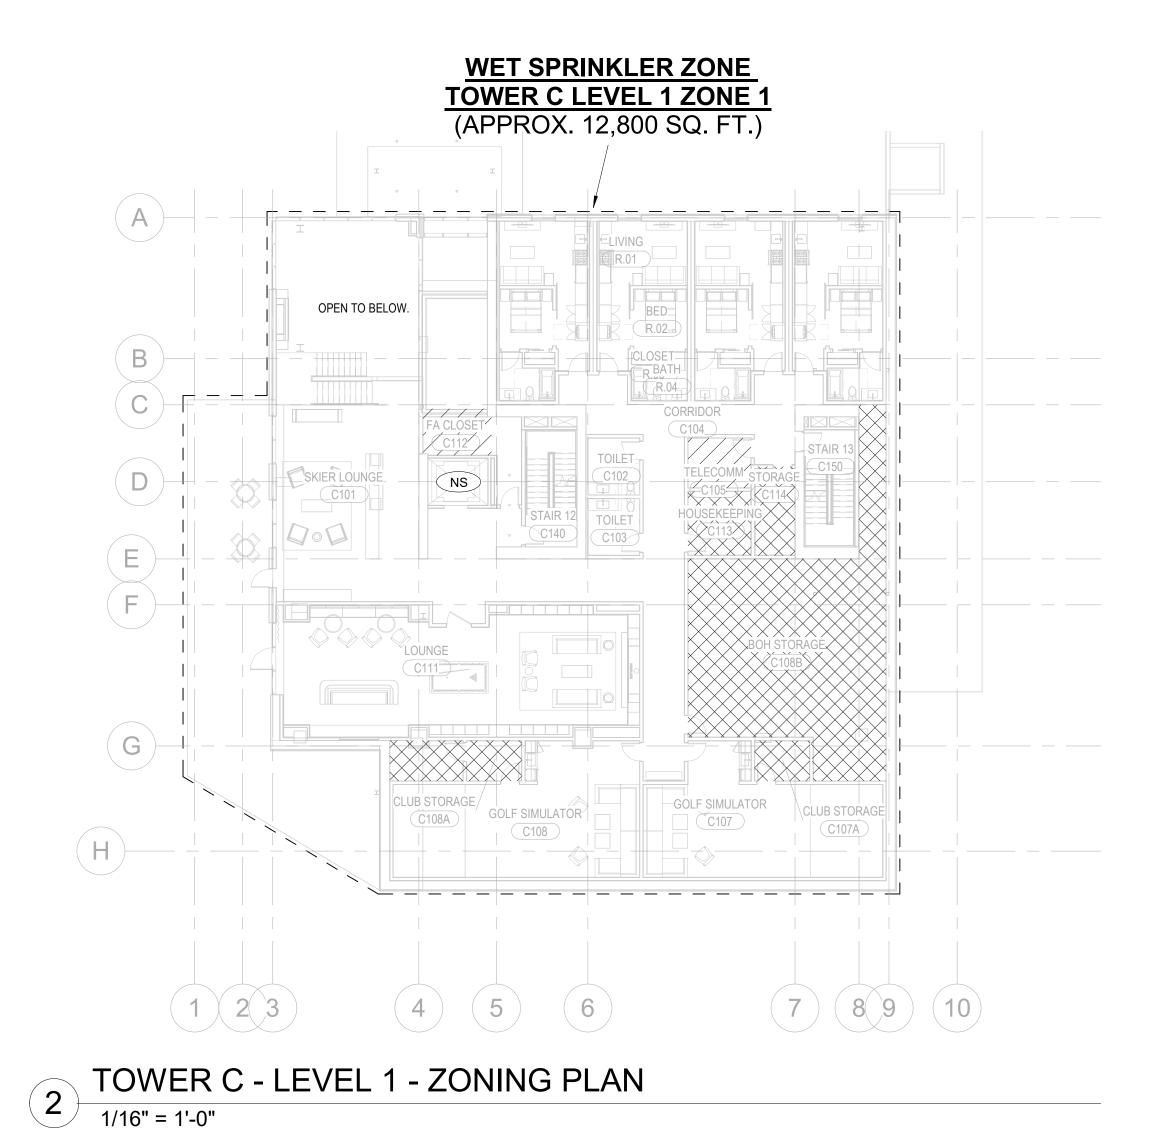

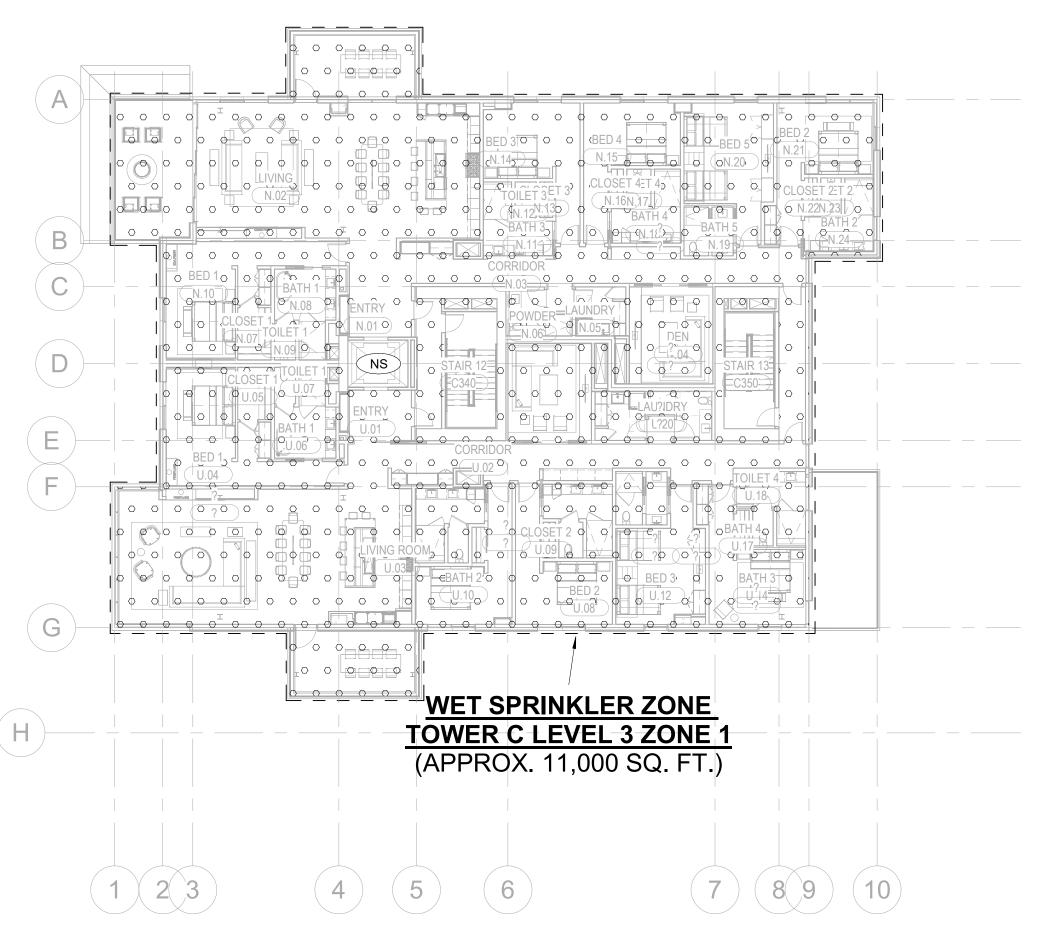TOWER C - LEVEL 3 - ZONING PLAN 1/16" = 1'-0"

FIRE PROTECTION DESIGN HATCH LEGEND LIGHT HAZARD; SYSTEM PROVIDING A DENSITY OF .10 GPM/SQFT. OVER DESIGN AREA OF 1,500 SQ. FT. WITH 100 GPM HOSE no. date by RESIDENTIAL HAZARD; SYSTEM PROVIDING A DENSITY OF .10 * * * * * * GPM/SQFT. OVER DESIGN AREA OF 4 SPRINKLERS. WITH 100 GPM HOSE ALLOWANCE 0 0 0 0 ORDINARY HAZARD GROUP 1; SYSTEM PROVIDING A DENSITY OF .15 GPM/SQFT. OVER DESIGN AREA OF 1,500 SQ. FT. WITH 250 ORDINARY HAZARD GROUP 2; SYSTEM PROVIDING A DENSITY OF .20 GPM/SQFT. OVER DESIGN AREA OF 1,500 SQ. FT. WITH 250 GPM HOSE ALLOWANCE FIRE PROTECTION -EXTRA HAZARD GROUP 1; SYSTEM PROVIDING A DENSITY OF .30 GPM/SQFT. OVER DESIGN AREA OF THE ENTIRE ROOM WITH 500 GPM HOSE ALLOWANCE + + + NS NON-SPRINKLERED AREA

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Structural Engineer

Building Envelope Consultant 2101 N 34th St Seattle, WA 98103 Accessibility Consultant
Studio Pacifica


Seattle, WA 98109 MEP Engineer WSP USA 1001 Fourth Ave., Suite 3100 Seattle, WA 98154


2144 Westlake Ave N, Suite F


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TOWER C - ZONING **PLANS**






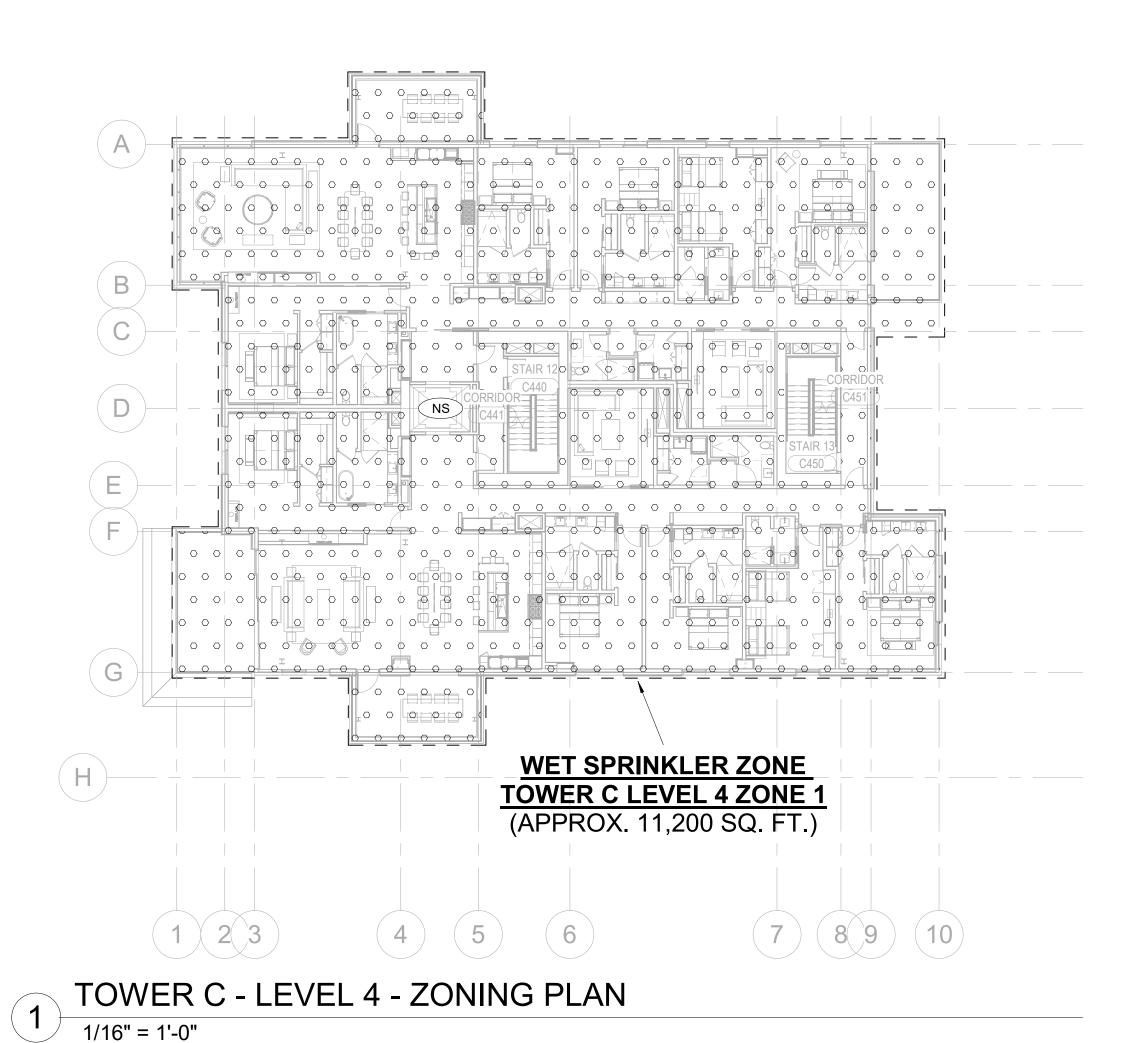

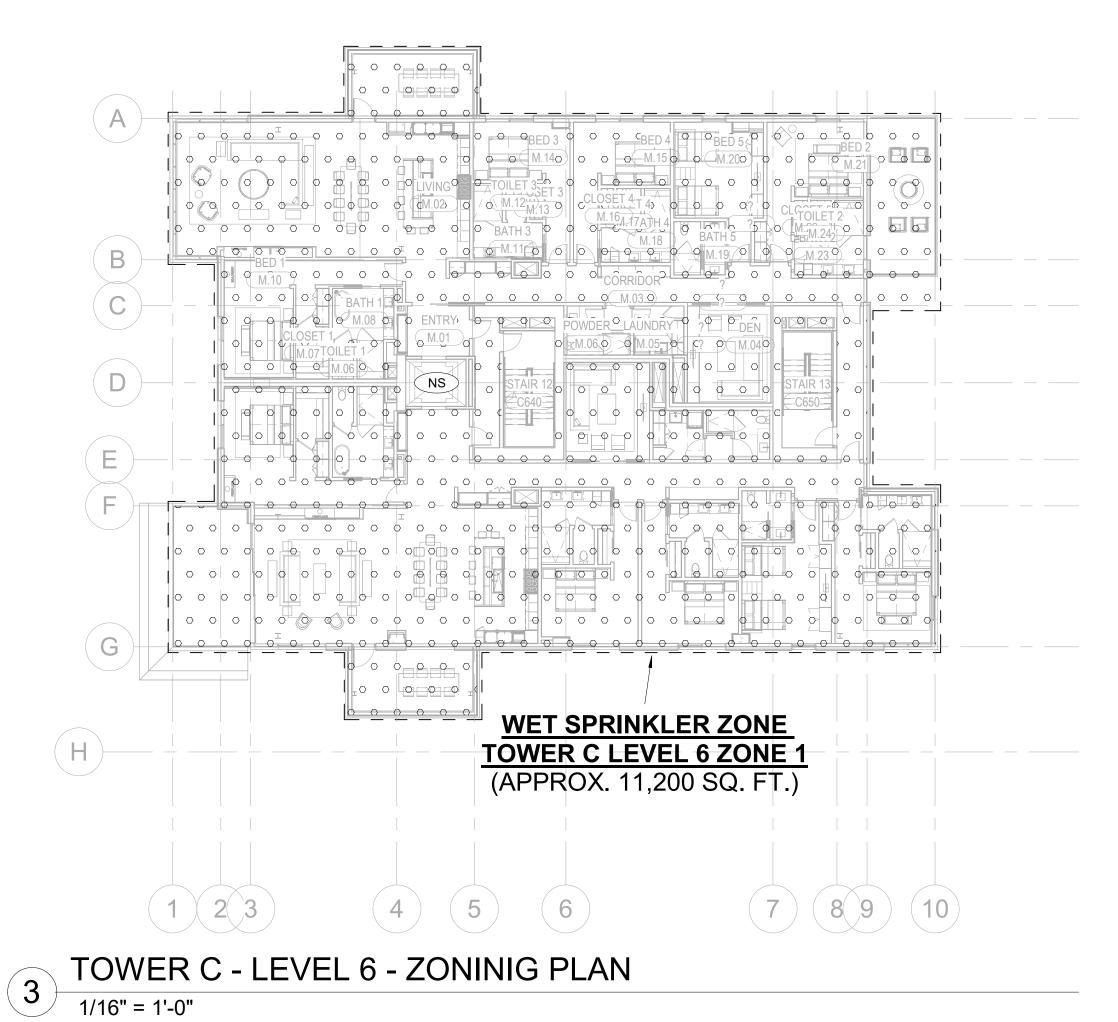TOWER C - LEVEL 5 - ZONING PLAN

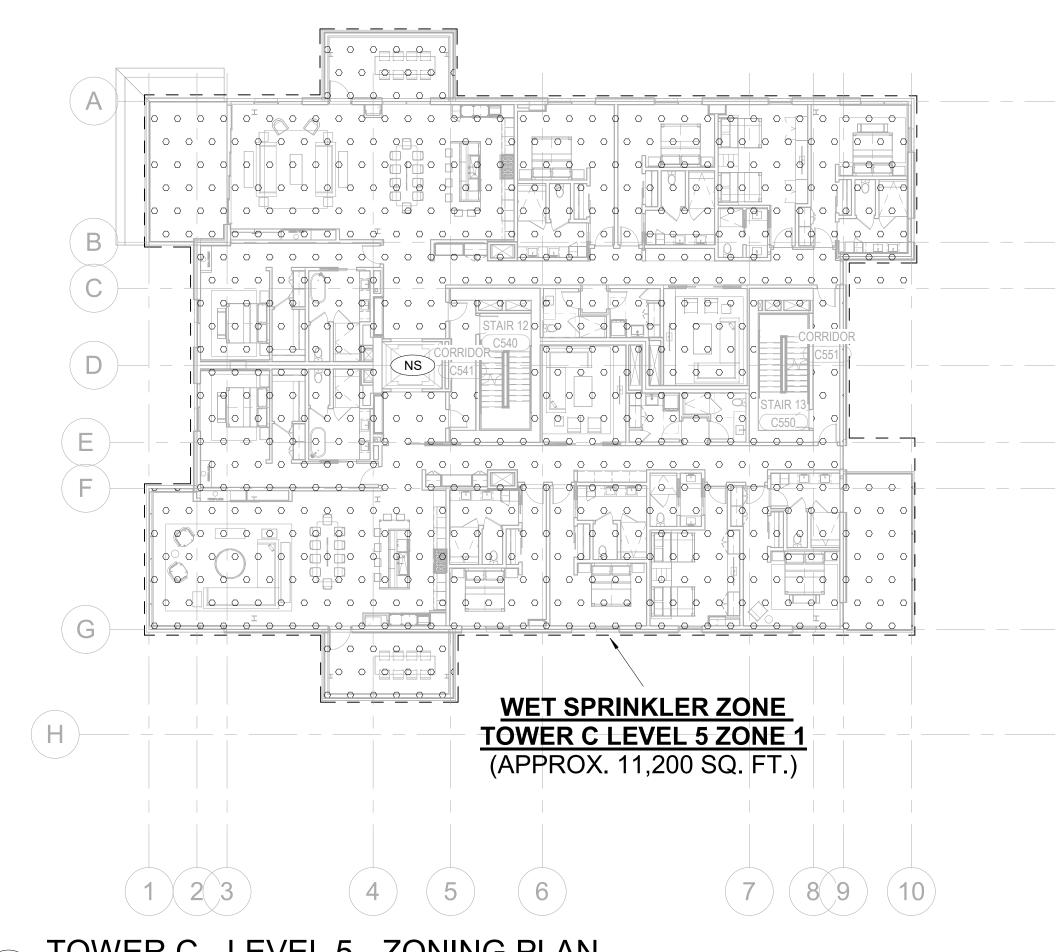1/16" = 1'-0"

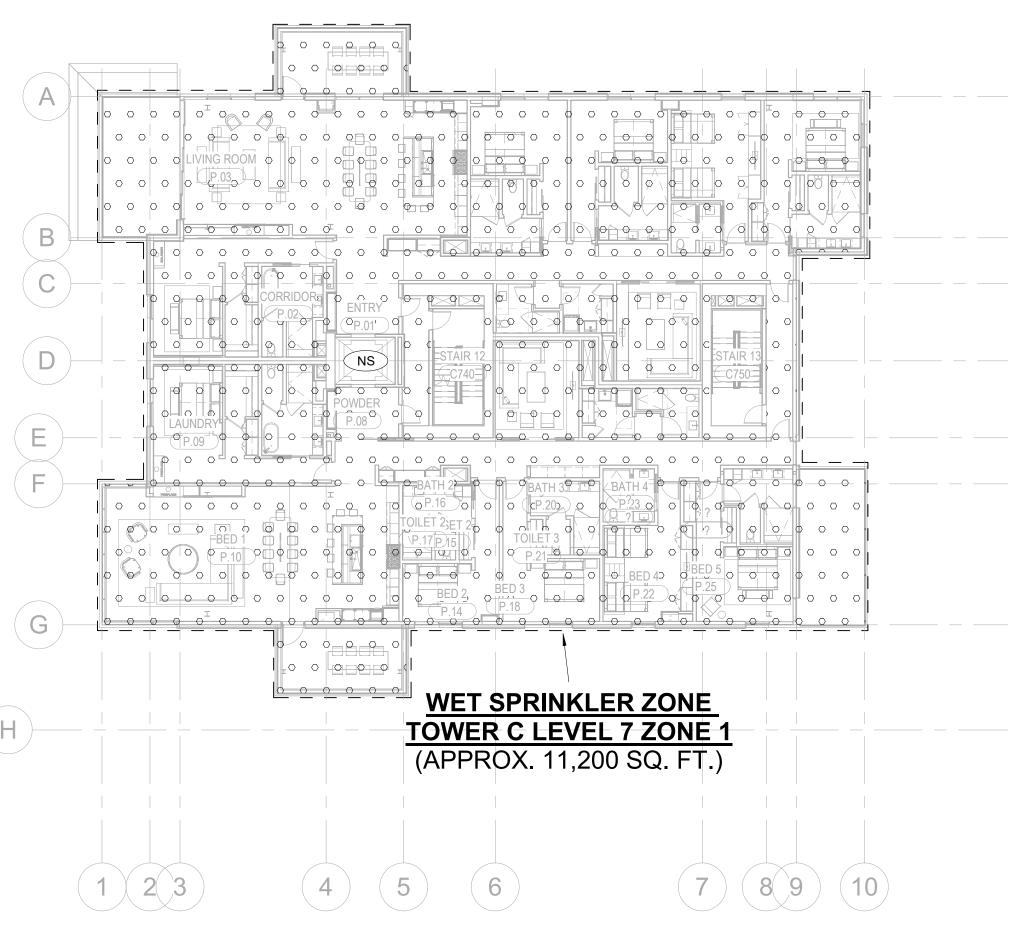

TOWER C - LEVEL 7 - ZONING PLAN

1/16" = 1'-0"

FIRE PROTECTION DESIGN HATCH LEGEND

LIGHT HAZARD; SYSTEM PROVIDING A DENSITY OF .10 OVER DESIGN AREA OF 1,500 SQ. FT. WITH 100 GPM HO ALLOWANCE RESIDENTIAL HAZARD; SYSTEM PROVIDING A DENSITY	
OVER DESIGN AREA OF 1,500 SQ. FT. WITH 100 GPM HC ALLOWANCE	
Ö Ö Ö Ö RES GPM/SQFT. OVER DESIGN AREA OF 4 SPRINKLERS. WI	
⊕ ⊕ ⊕ ⊕ ⊕ ⊕ ⊕ ⊕ ⊕ ⊕ ⊕ ⊕ ⊕ ⊕ ⊕ ⊕ ⊕ ⊕ ⊕	
ORDINARY HAZARD GROUP 1; SYSTEM PROVIDING A D OF .15 GPM/SQFT. OVER DESIGN AREA OF 1,500 SQ. FT	
GPM HOSE ALLOWANCE	
ORDINARY HAZARD GROUP 2; SYSTEM PROVIDING A D OF .20 GPM/SQFT. OVER DESIGN AREA OF 1,500 SQ. FT	
GPM HOSE ALLOWANCE	
EXTRA HAZARD GROUP 1; SYSTEM PROVIDING A DENS GPM/SQFT. OVER DESIGN AREA OF THE ENTIRE ROOM	
+ + + + GPM HOSE ALLOWANCE	
NON CODINIZIEDED ADEA	
NS NON-SPRINKLERED AREA	

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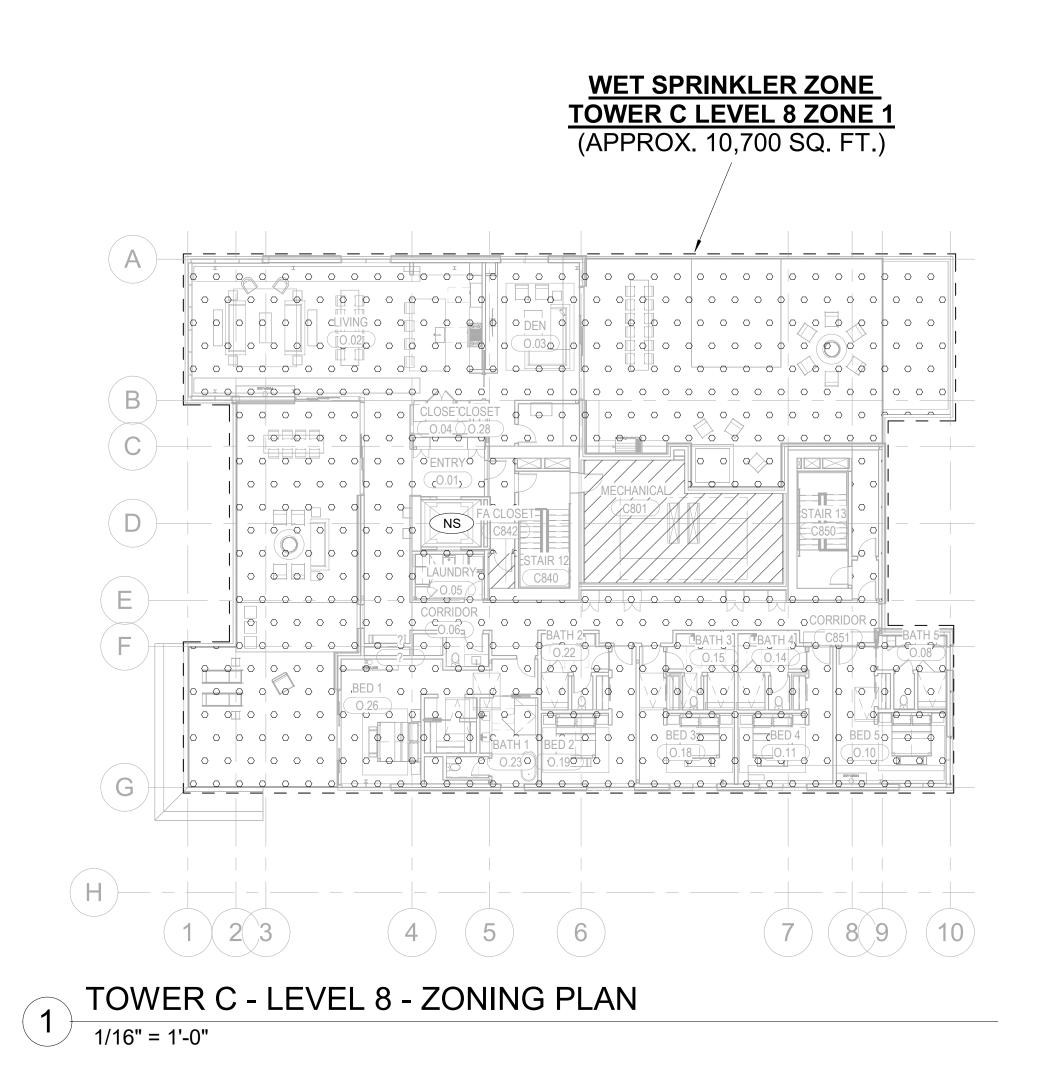
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FIRE PROTECTION -TOWER C - ZONING PLANS



FIRE PROTECTION DESIGN HATCH LEGEND

	LH	LIGHT HAZARD; SYSTEM PROVIDING A DENSITY OF .10 GPM/SQF OVER DESIGN AREA OF 1,500 SQ. FT. WITH 100 GPM HOSE ALLOWANCE
	RES	RESIDENTIAL HAZARD; SYSTEM PROVIDING A DENSITY OF .10 GPM/SQFT. OVER DESIGN AREA OF 4 SPRINKLERS. WITH 100 GPHOSE ALLOWANCE
	OH1	ORDINARY HAZARD GROUP 1; SYSTEM PROVIDING A DENSITY OF .15 GPM/SQFT. OVER DESIGN AREA OF 1,500 SQ. FT. WITH 250 GPM HOSE ALLOWANCE
	OH2	ORDINARY HAZARD GROUP 2; SYSTEM PROVIDING A DENSITY OF .20 GPM/SQFT. OVER DESIGN AREA OF 1,500 SQ. FT. WITH 250 GPM HOSE ALLOWANCE
+ + + + + + + + + + + + + + + + + + + +	EX1	EXTRA HAZARD GROUP 1; SYSTEM PROVIDING A DENSITY OF .30 GPM/SQFT. OVER DESIGN AREA OF THE ENTIRE ROOM WITH 500 GPM HOSE ALLOWANCE
	NS	NON-SPRINKLERED AREA

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no. date

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FIRE PROTECTION -TOWER C - ZONING PLANS

GENERAL NOTES:

1. SCOPE OF WORK INCLUDES SPRINKLER PROTECTION THROUGHOUT ALL AREAS IN ACCORDANCE WITH NFPA 13. SPRINKLERS ARE INDICATED IN AREAS WITH FINISHED CEILINGS FOR COORDINATION PURPOSES. INSTALLING CONTRACTOR SHALL BE RESPONSIBLE FOR DETAILED DESIGN OF BRANCH PIPING AND UPRIGHT SPRINKLERS IN AREAS WITHOUT FINISHED CEILINGS.

AREAS WITHOUT FINISHED CEILINGS.
2. REFER TO TYPICAL UNIT PLANS FOR SPRINKLER LAYOUTS ON RESIDENTIAL FLOORS.

SHEET KEYED NOTES:

- 1 1.5" CONNECTION FOR KITCHEN PCU. PROVIDE ACCESS PANEL FOR ISOLATION VALVE.
- 2 DISCHARGE SPRINKLER DRAIN RISER TO OPEN END DRAIN.

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project manager__JCC_____
drawn by__CRB, SMK______
checked by__Checker_____
job no. 20052
date 11/18/2022

revisions:

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FIRE PROTECTION PLAN - TOWER A - LVL B

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principal architect_____

project manager__JCC_____

drawn by__CRB, SMK____

checked by Checker job no. 20052

date 11/18/2022

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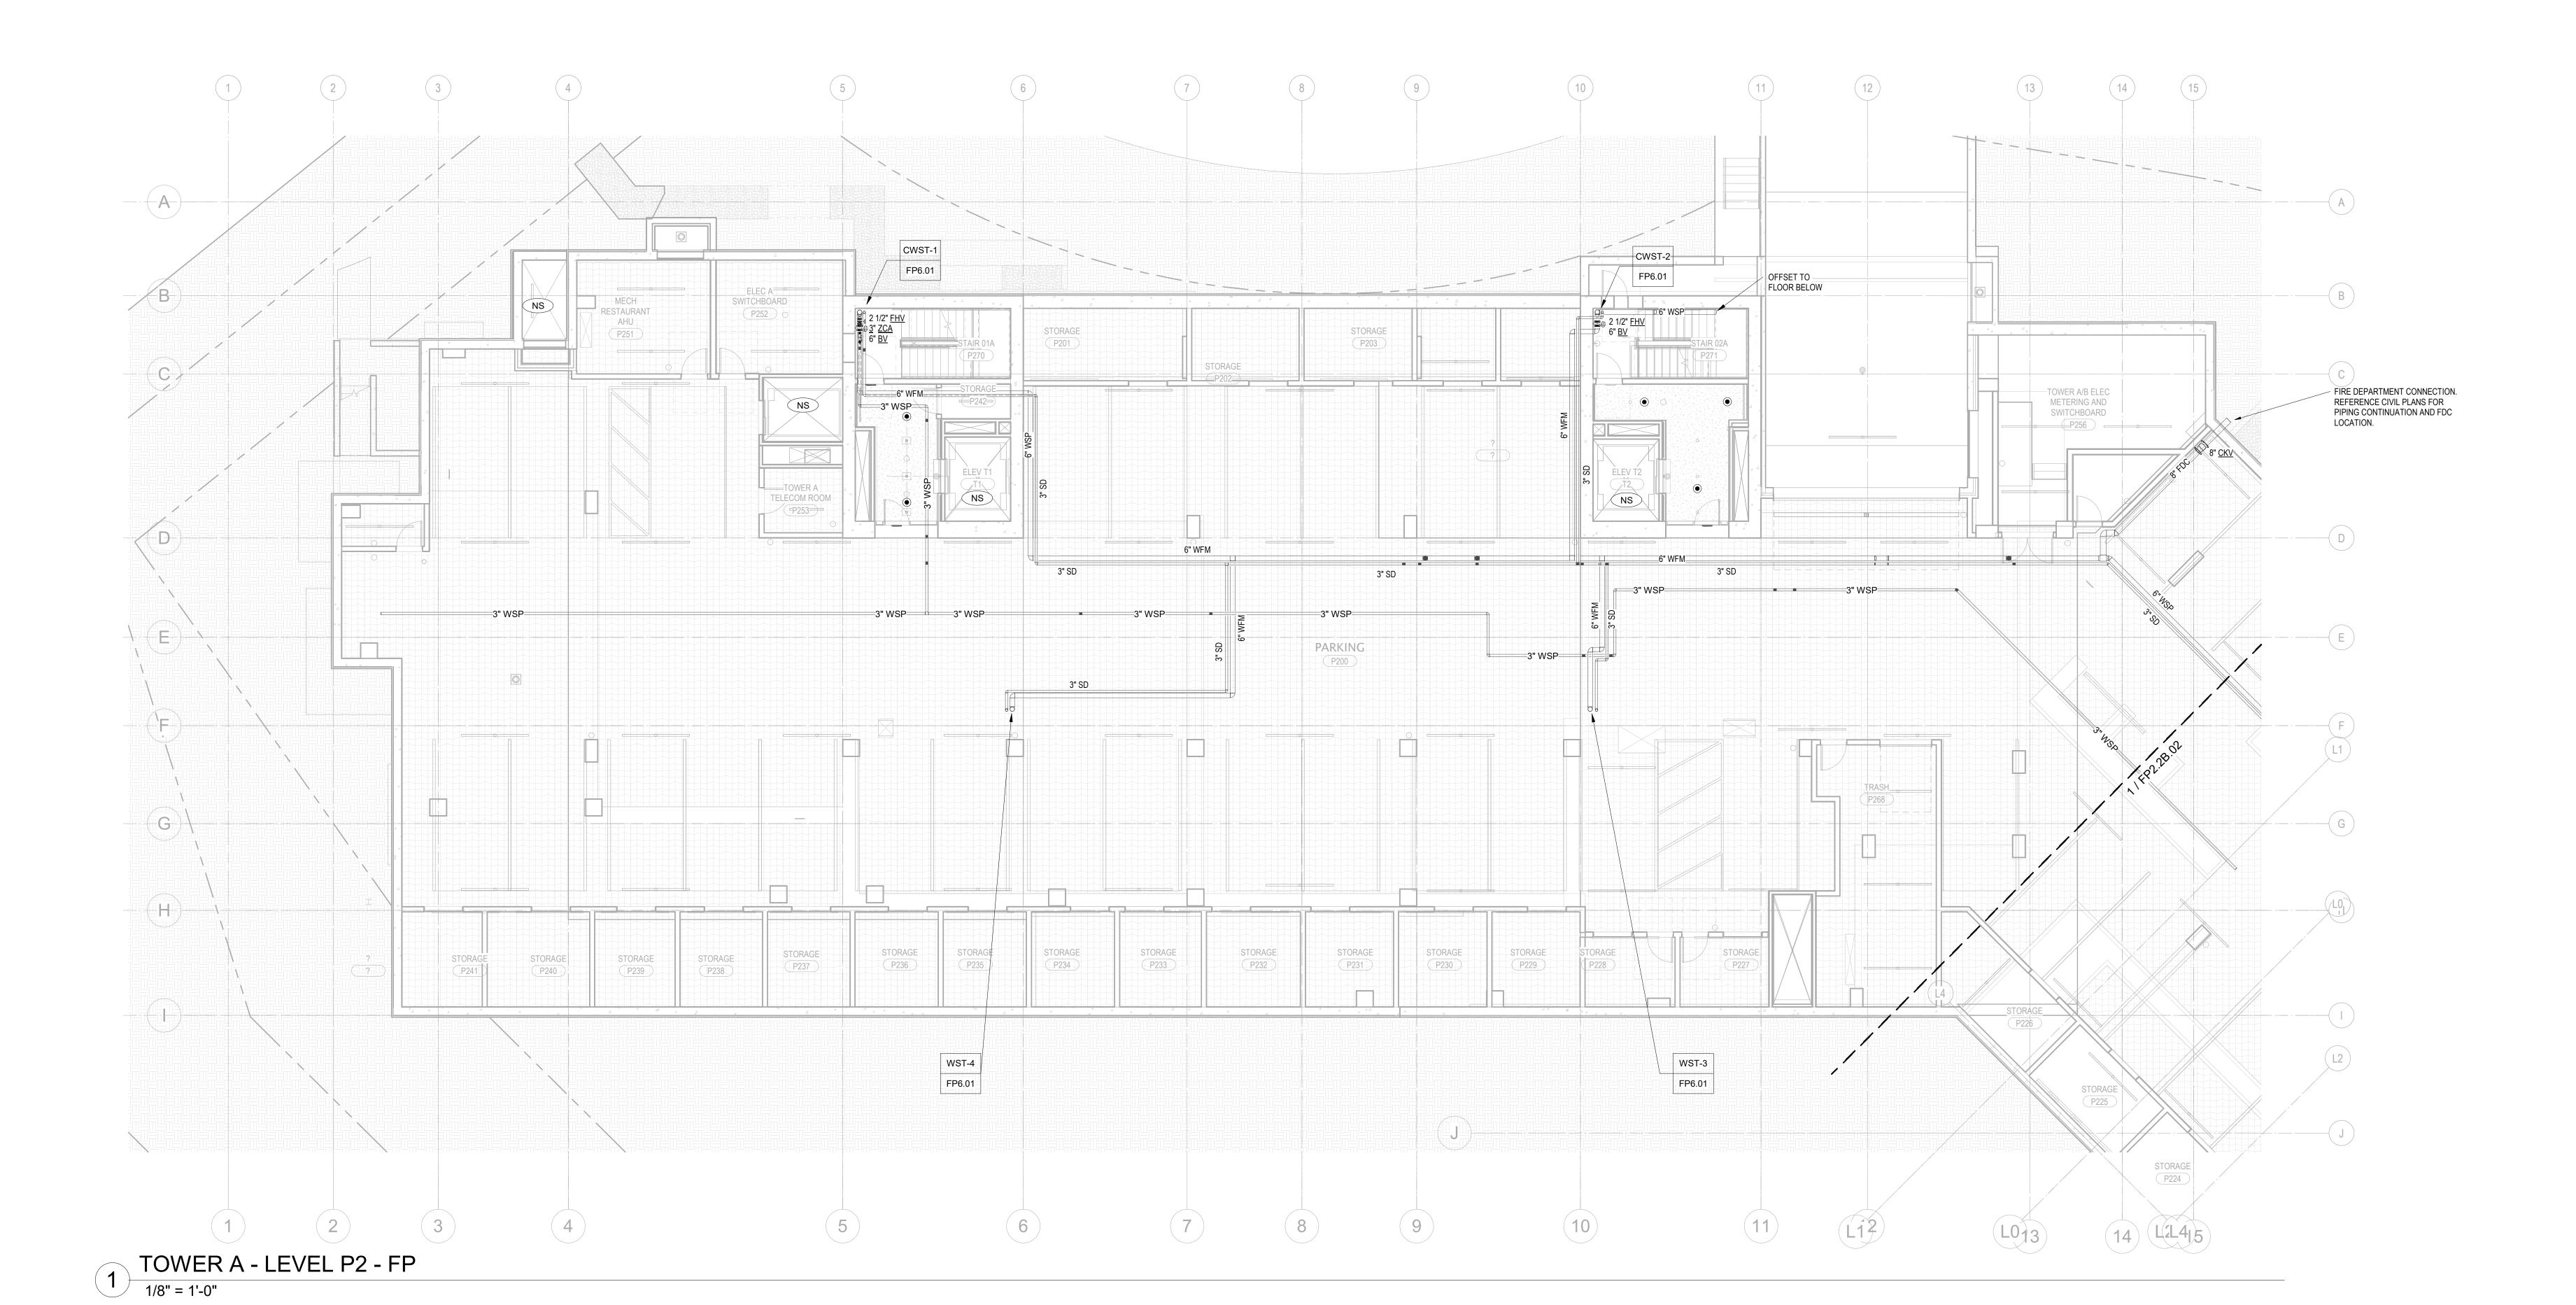
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Building Envelope Consultant RDH

Middlebury, VT



ISSUE FOR CONSTRUCTION 11/18/2022

FIRE PROTECTION PLAN
- TOWER A - LVL P2

FP2.2A.02

ACCORDANCE WITH NFPA 13. SPRINKLERS ARE INDICATED IN AREAS WITH FINISHED CEILINGS FOR COORDINATION PURPOSES. INSTALLING CONTRACTOR SHALL BE RESPONSIBLE FOR DETAILED DESIGN OF BRANCH PIPING AND UPRIGHT SPRINKLERS IN AREAS WITHOUT FINISHED CEILINGS. 2. REFER TO TYPICAL UNIT PLANS FOR SPRINKLER LAYOUTS ON RESIDENTIAL FLOORS.

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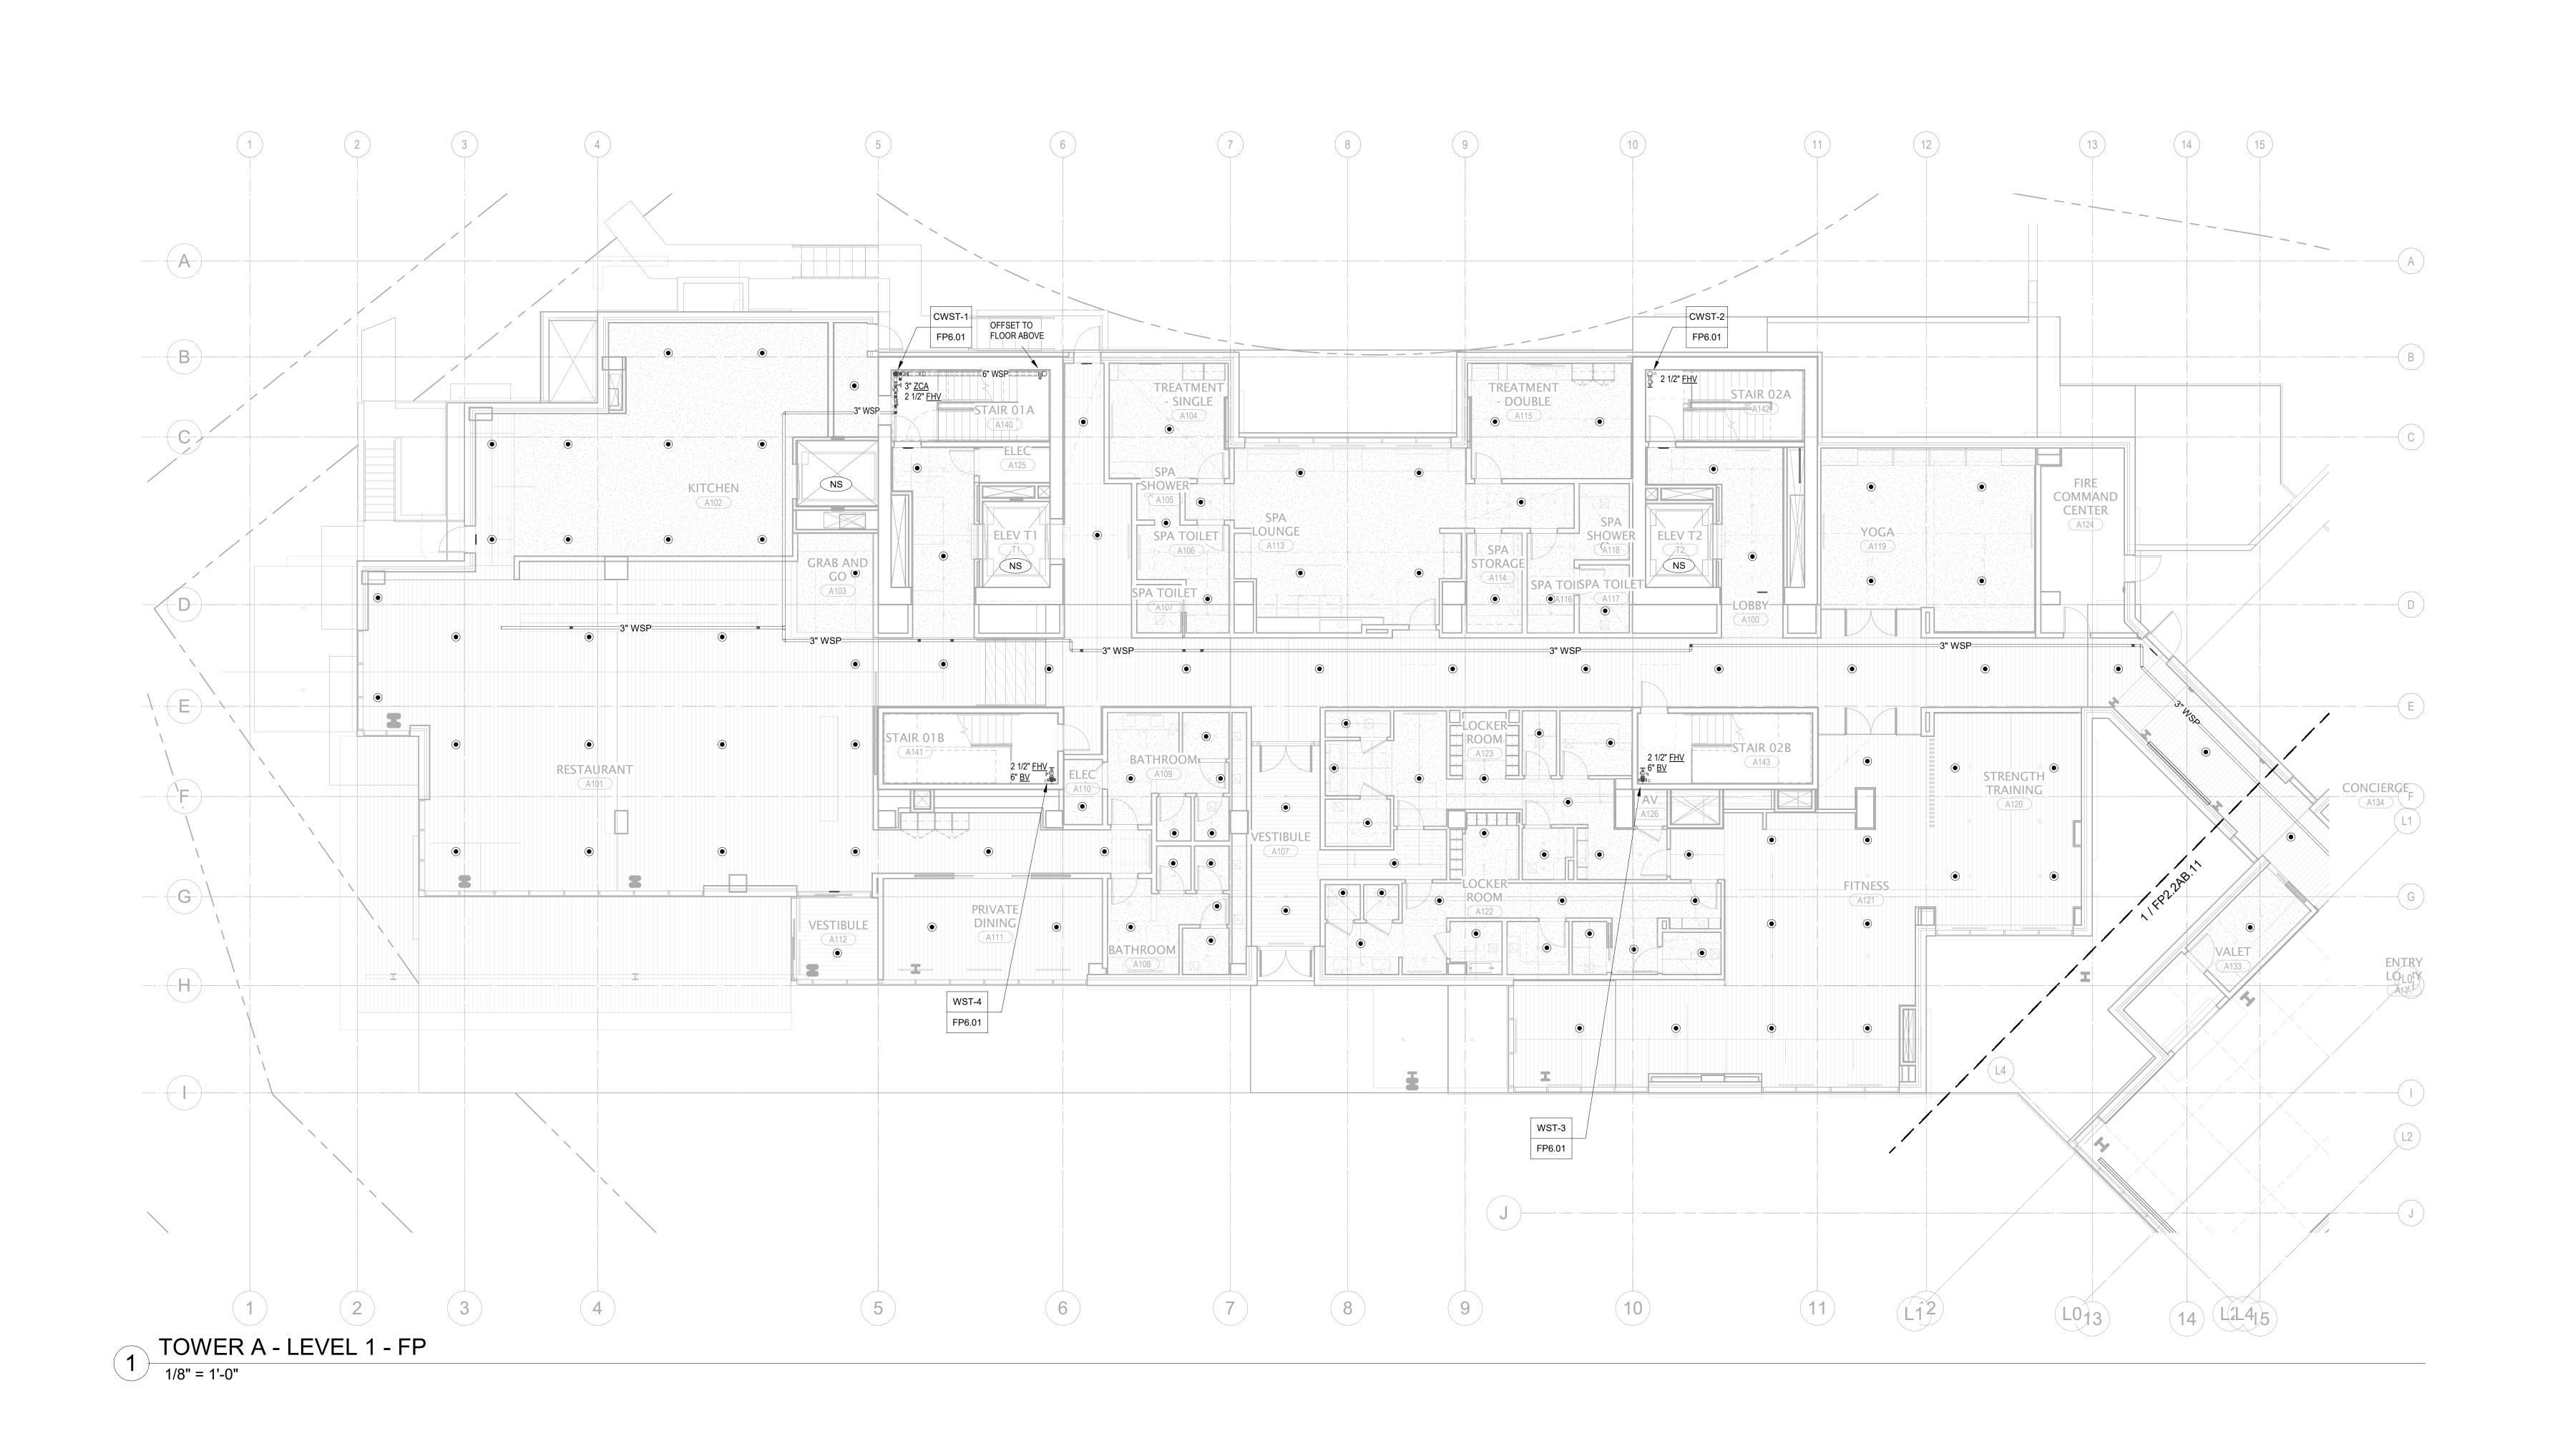
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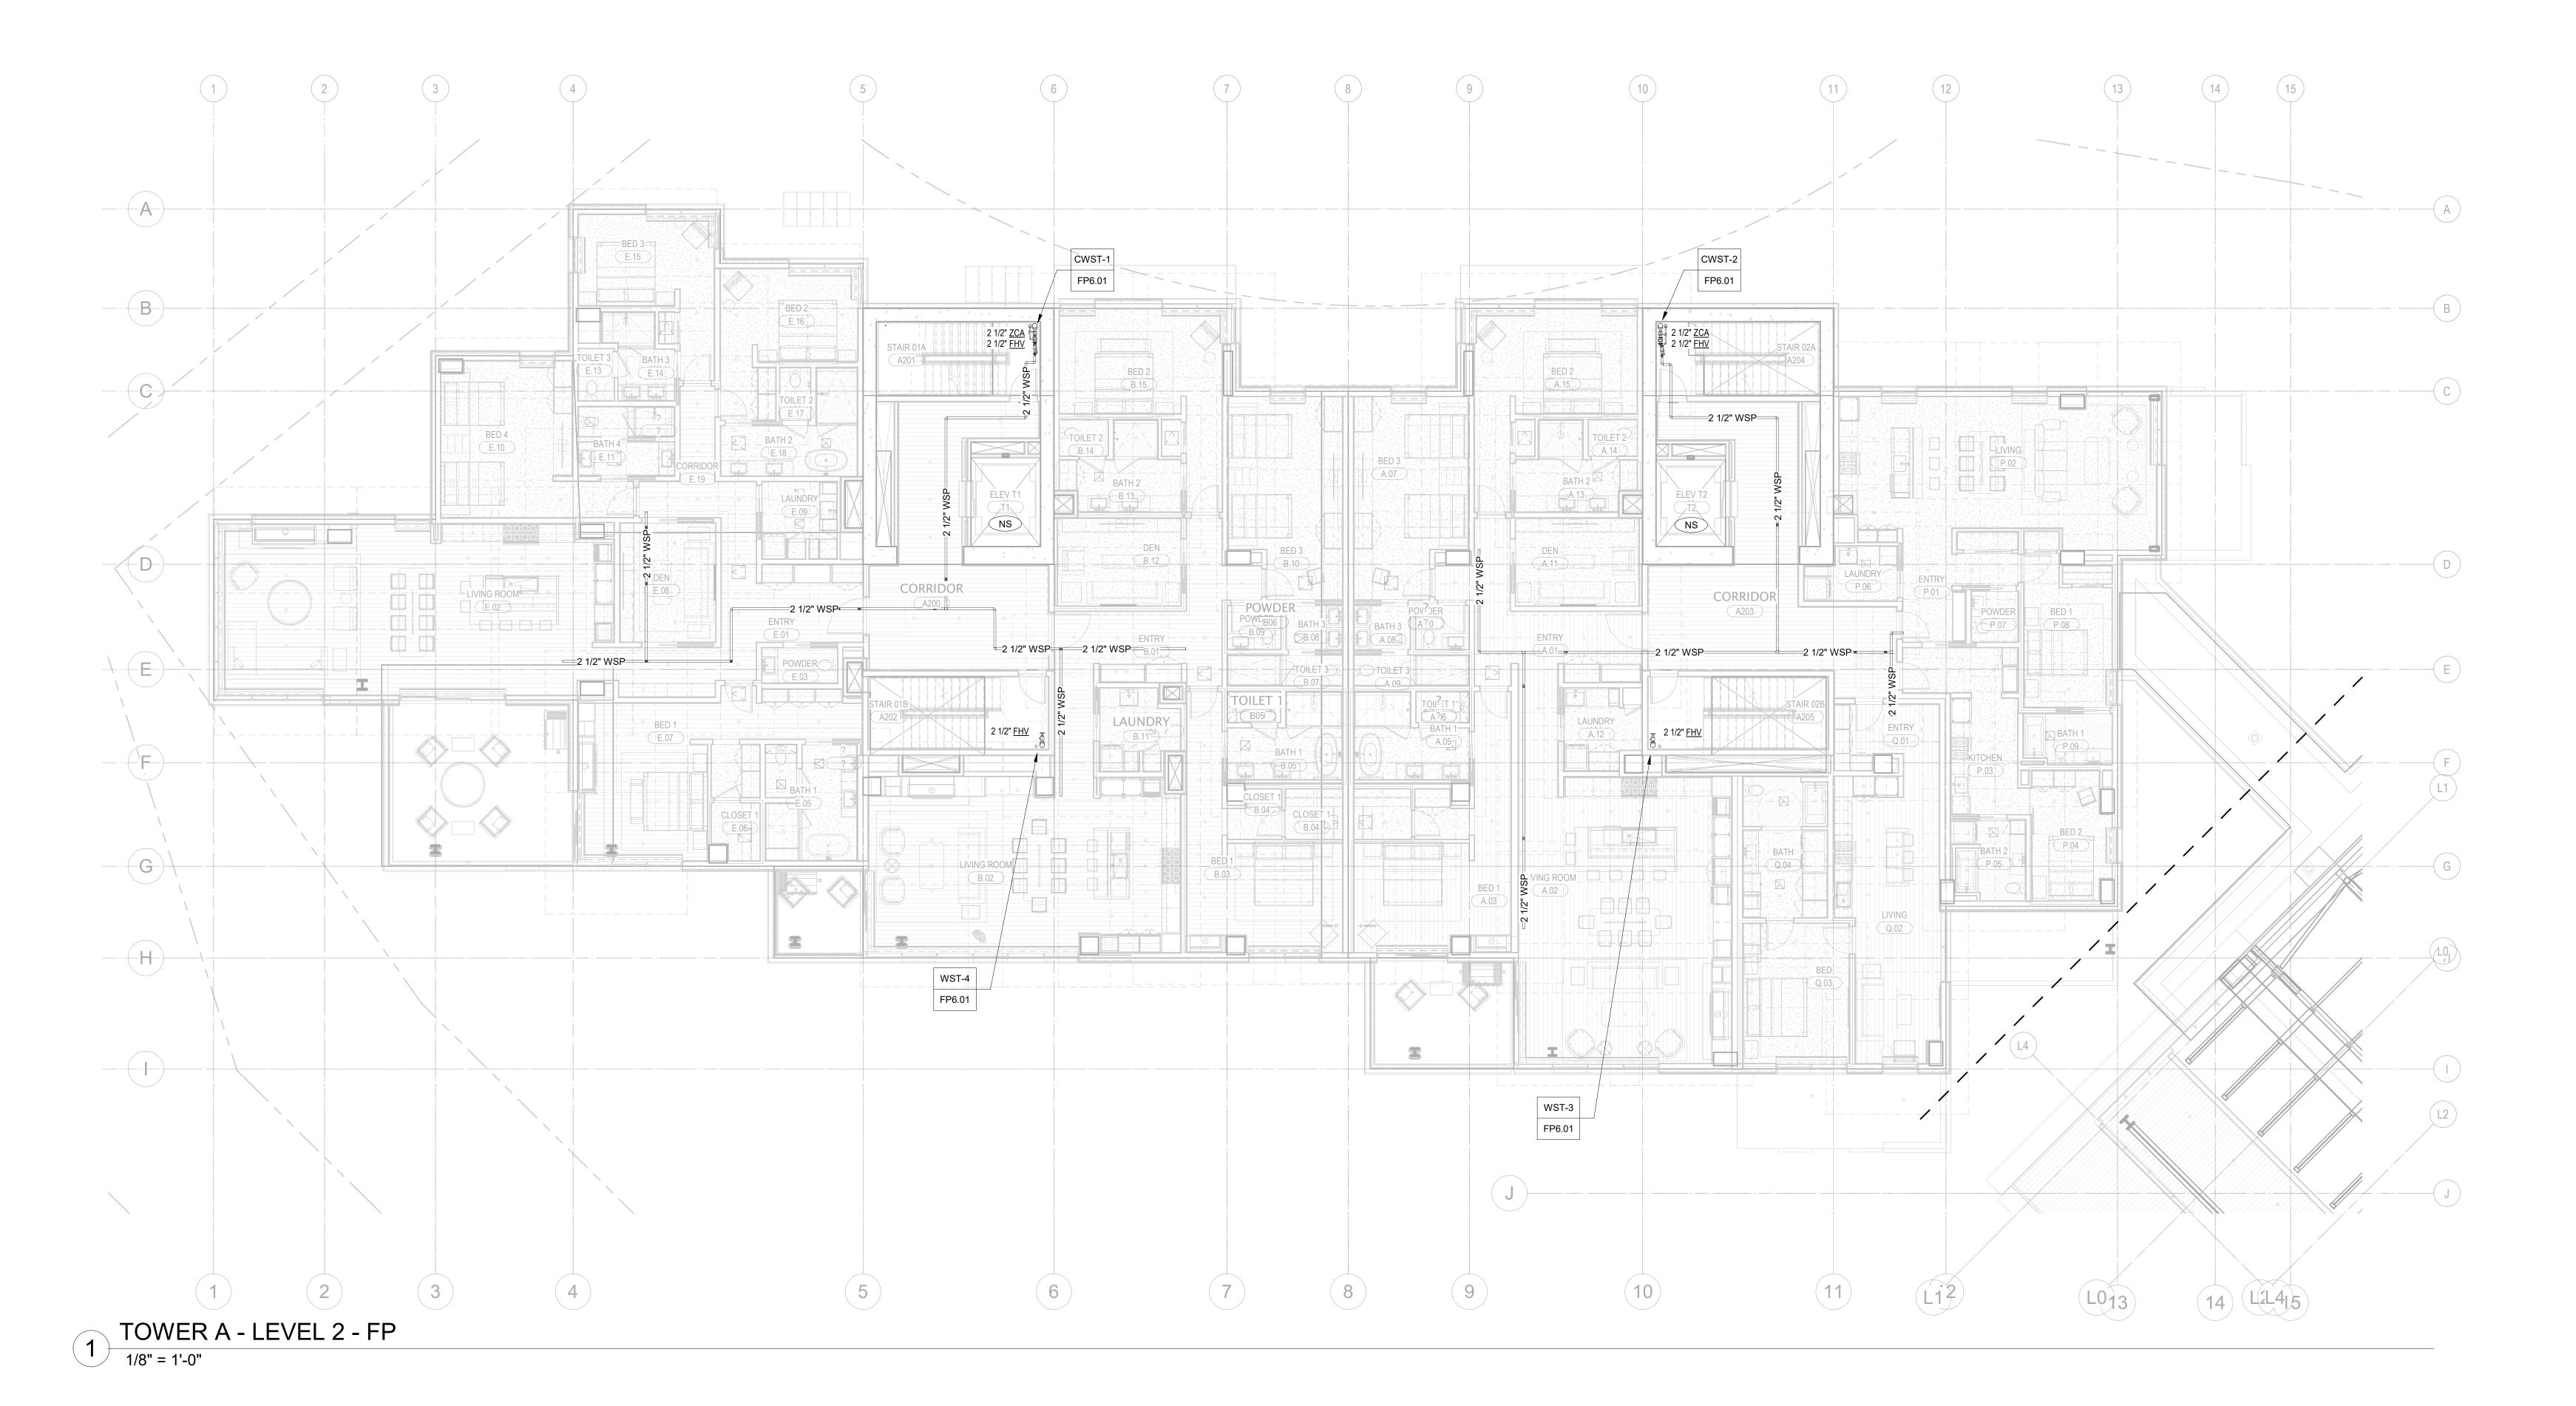
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FIRE PROTECTION PLAN
- TOWER A - LVL 1

FP2.2A.11



2. REFER TO TYPICAL UNIT PLANS FOR SPRINKLER LAYOUTS ON RESIDENTIAL FLOORS.



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project manager__JCC
drawn by__CRB,SMK____

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FIRE PROTECTION PLAN - TOWER A - LVL 2

FP2.2A.12

SCOPE OF WORK INCLUDES SPRINKLER PROTECTION THROUGHOUT ALL AREAS IN ACCORDANCE WITH NFPA 13. SPRINKLERS ARE INDICATED IN AREAS WITH FINISHED CEILINGS FOR COORDINATION PURPOSES. INSTALLING CONTRACTOR SHALL BE RESPONSIBLE FOR DETAILED DESIGN OF BRANCH PIPING AND UPRIGHT SPRINKLERS IN AREAS WITHOUT FINISHED CEILINGS.
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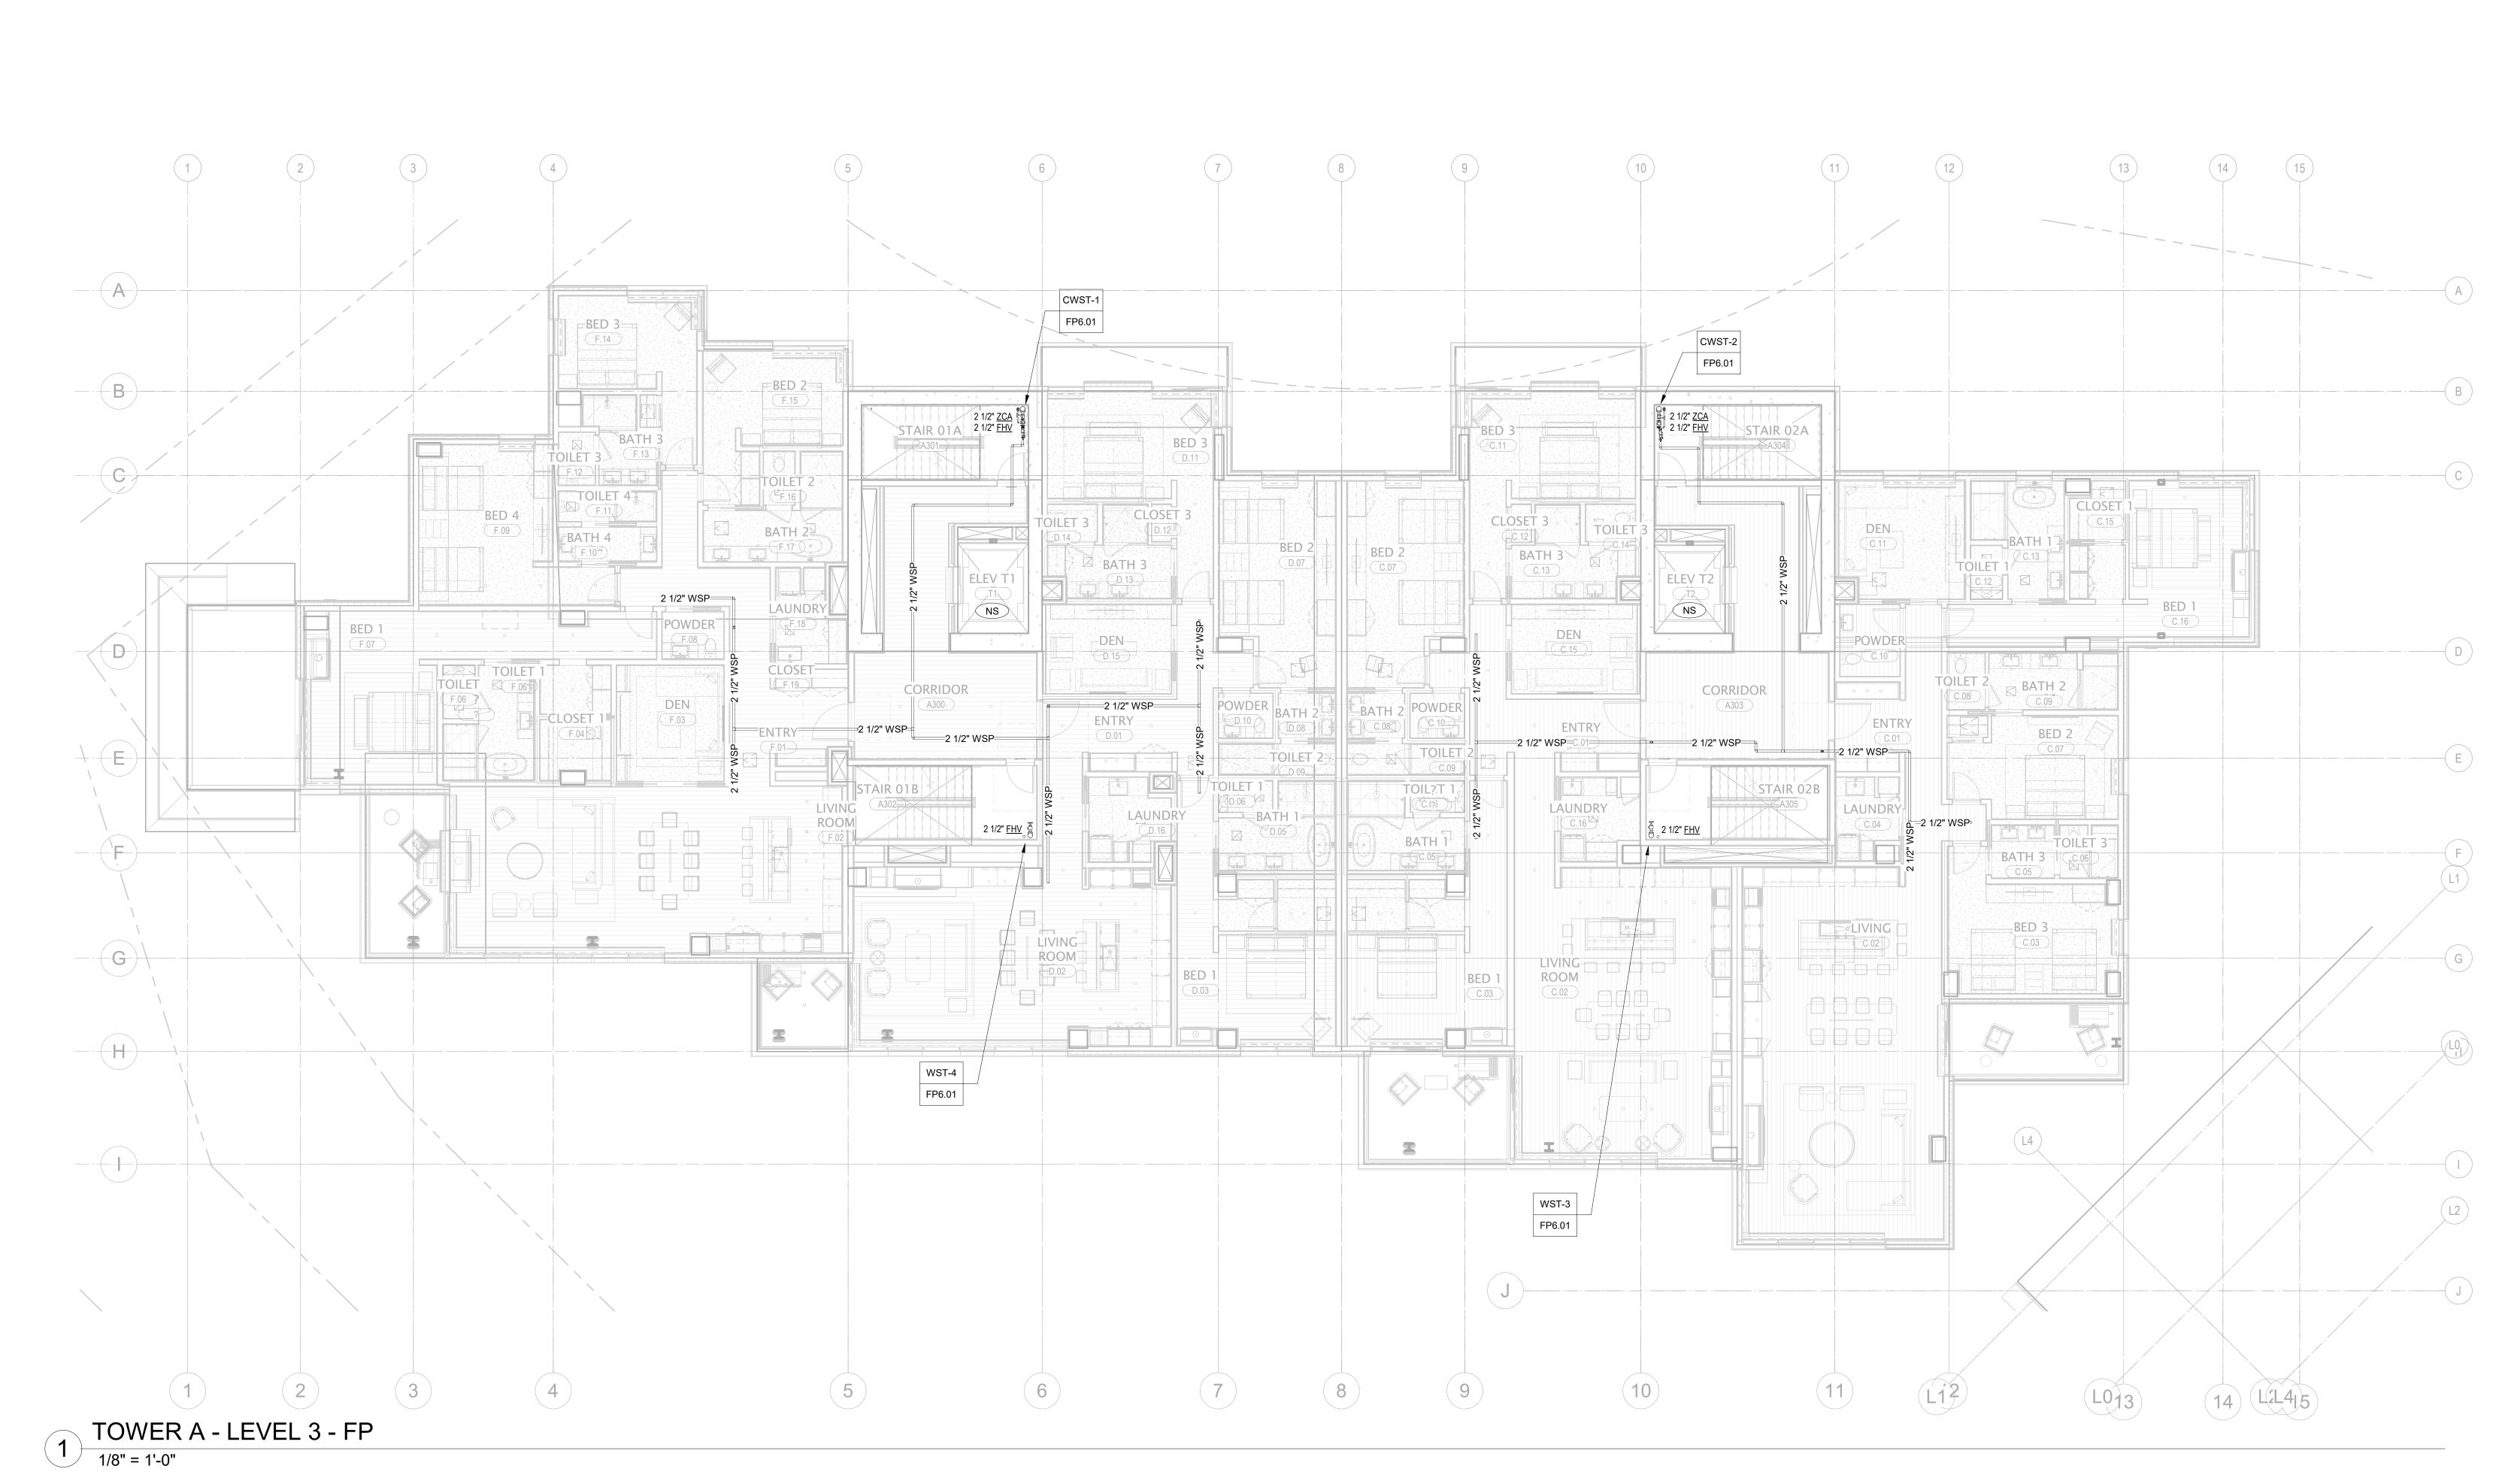
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FIRE PROTECTION PLAN
- TOWER A - LVL 3

FP2.2A.13



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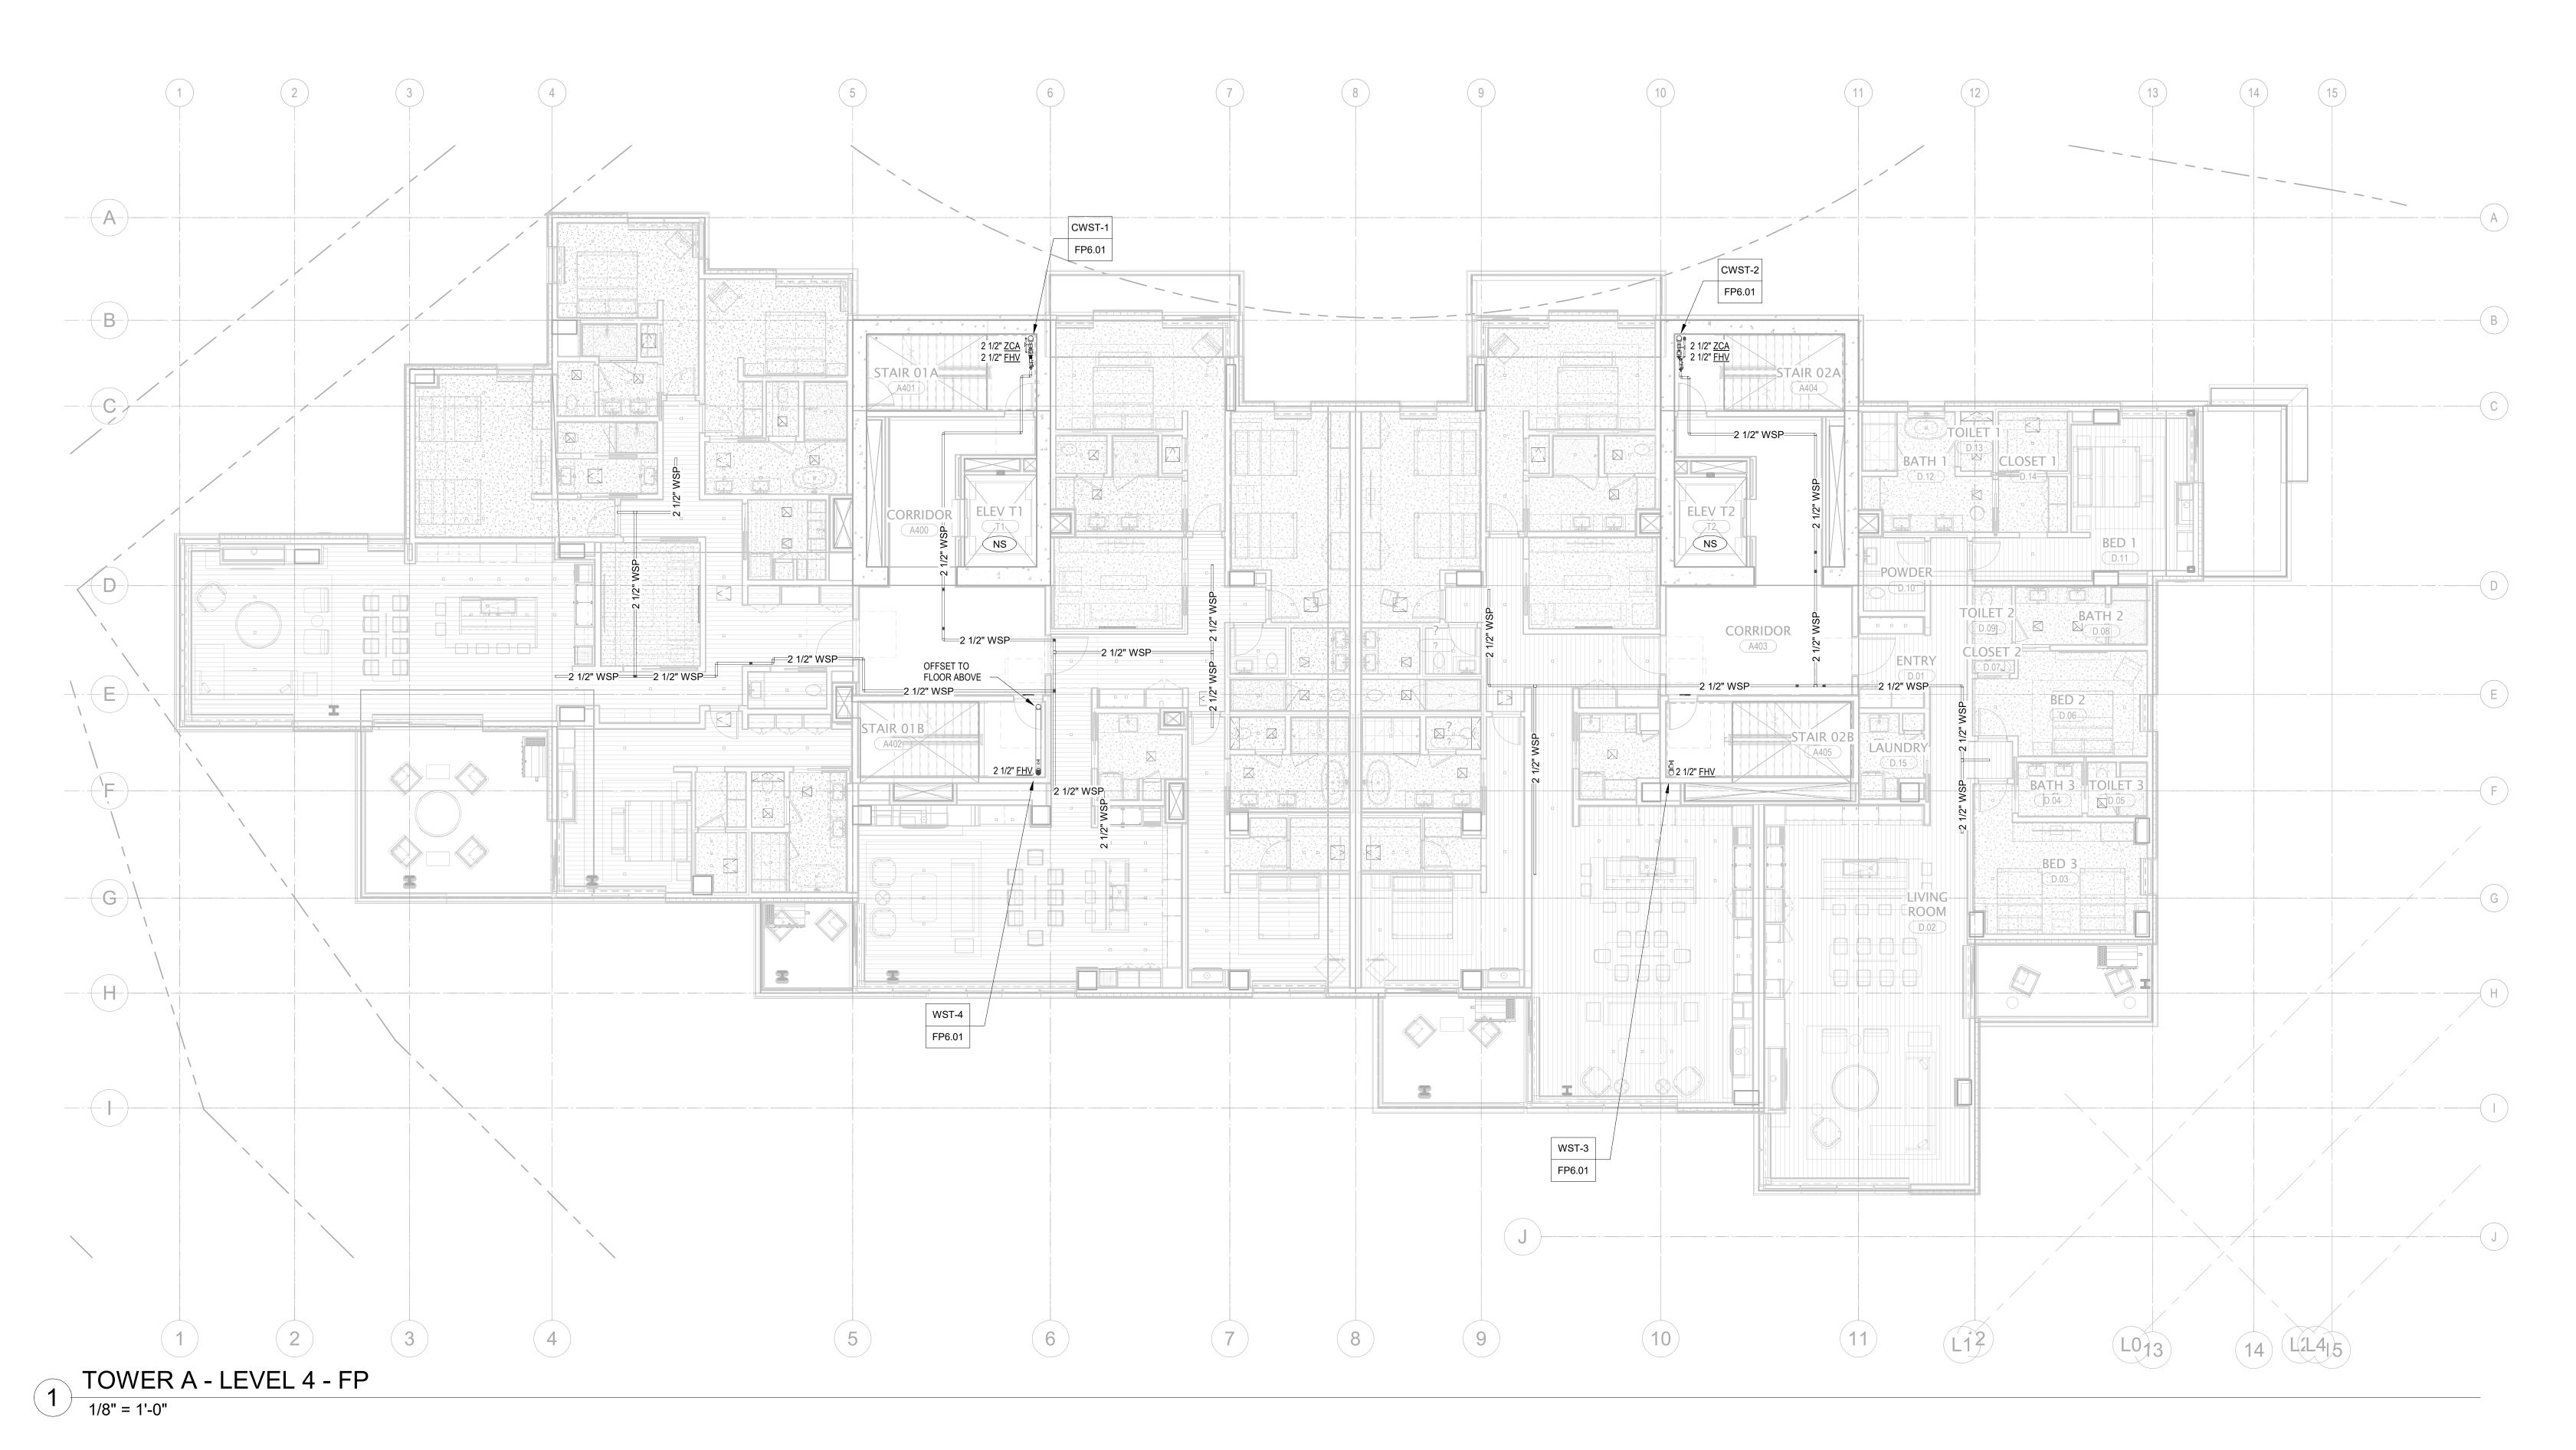
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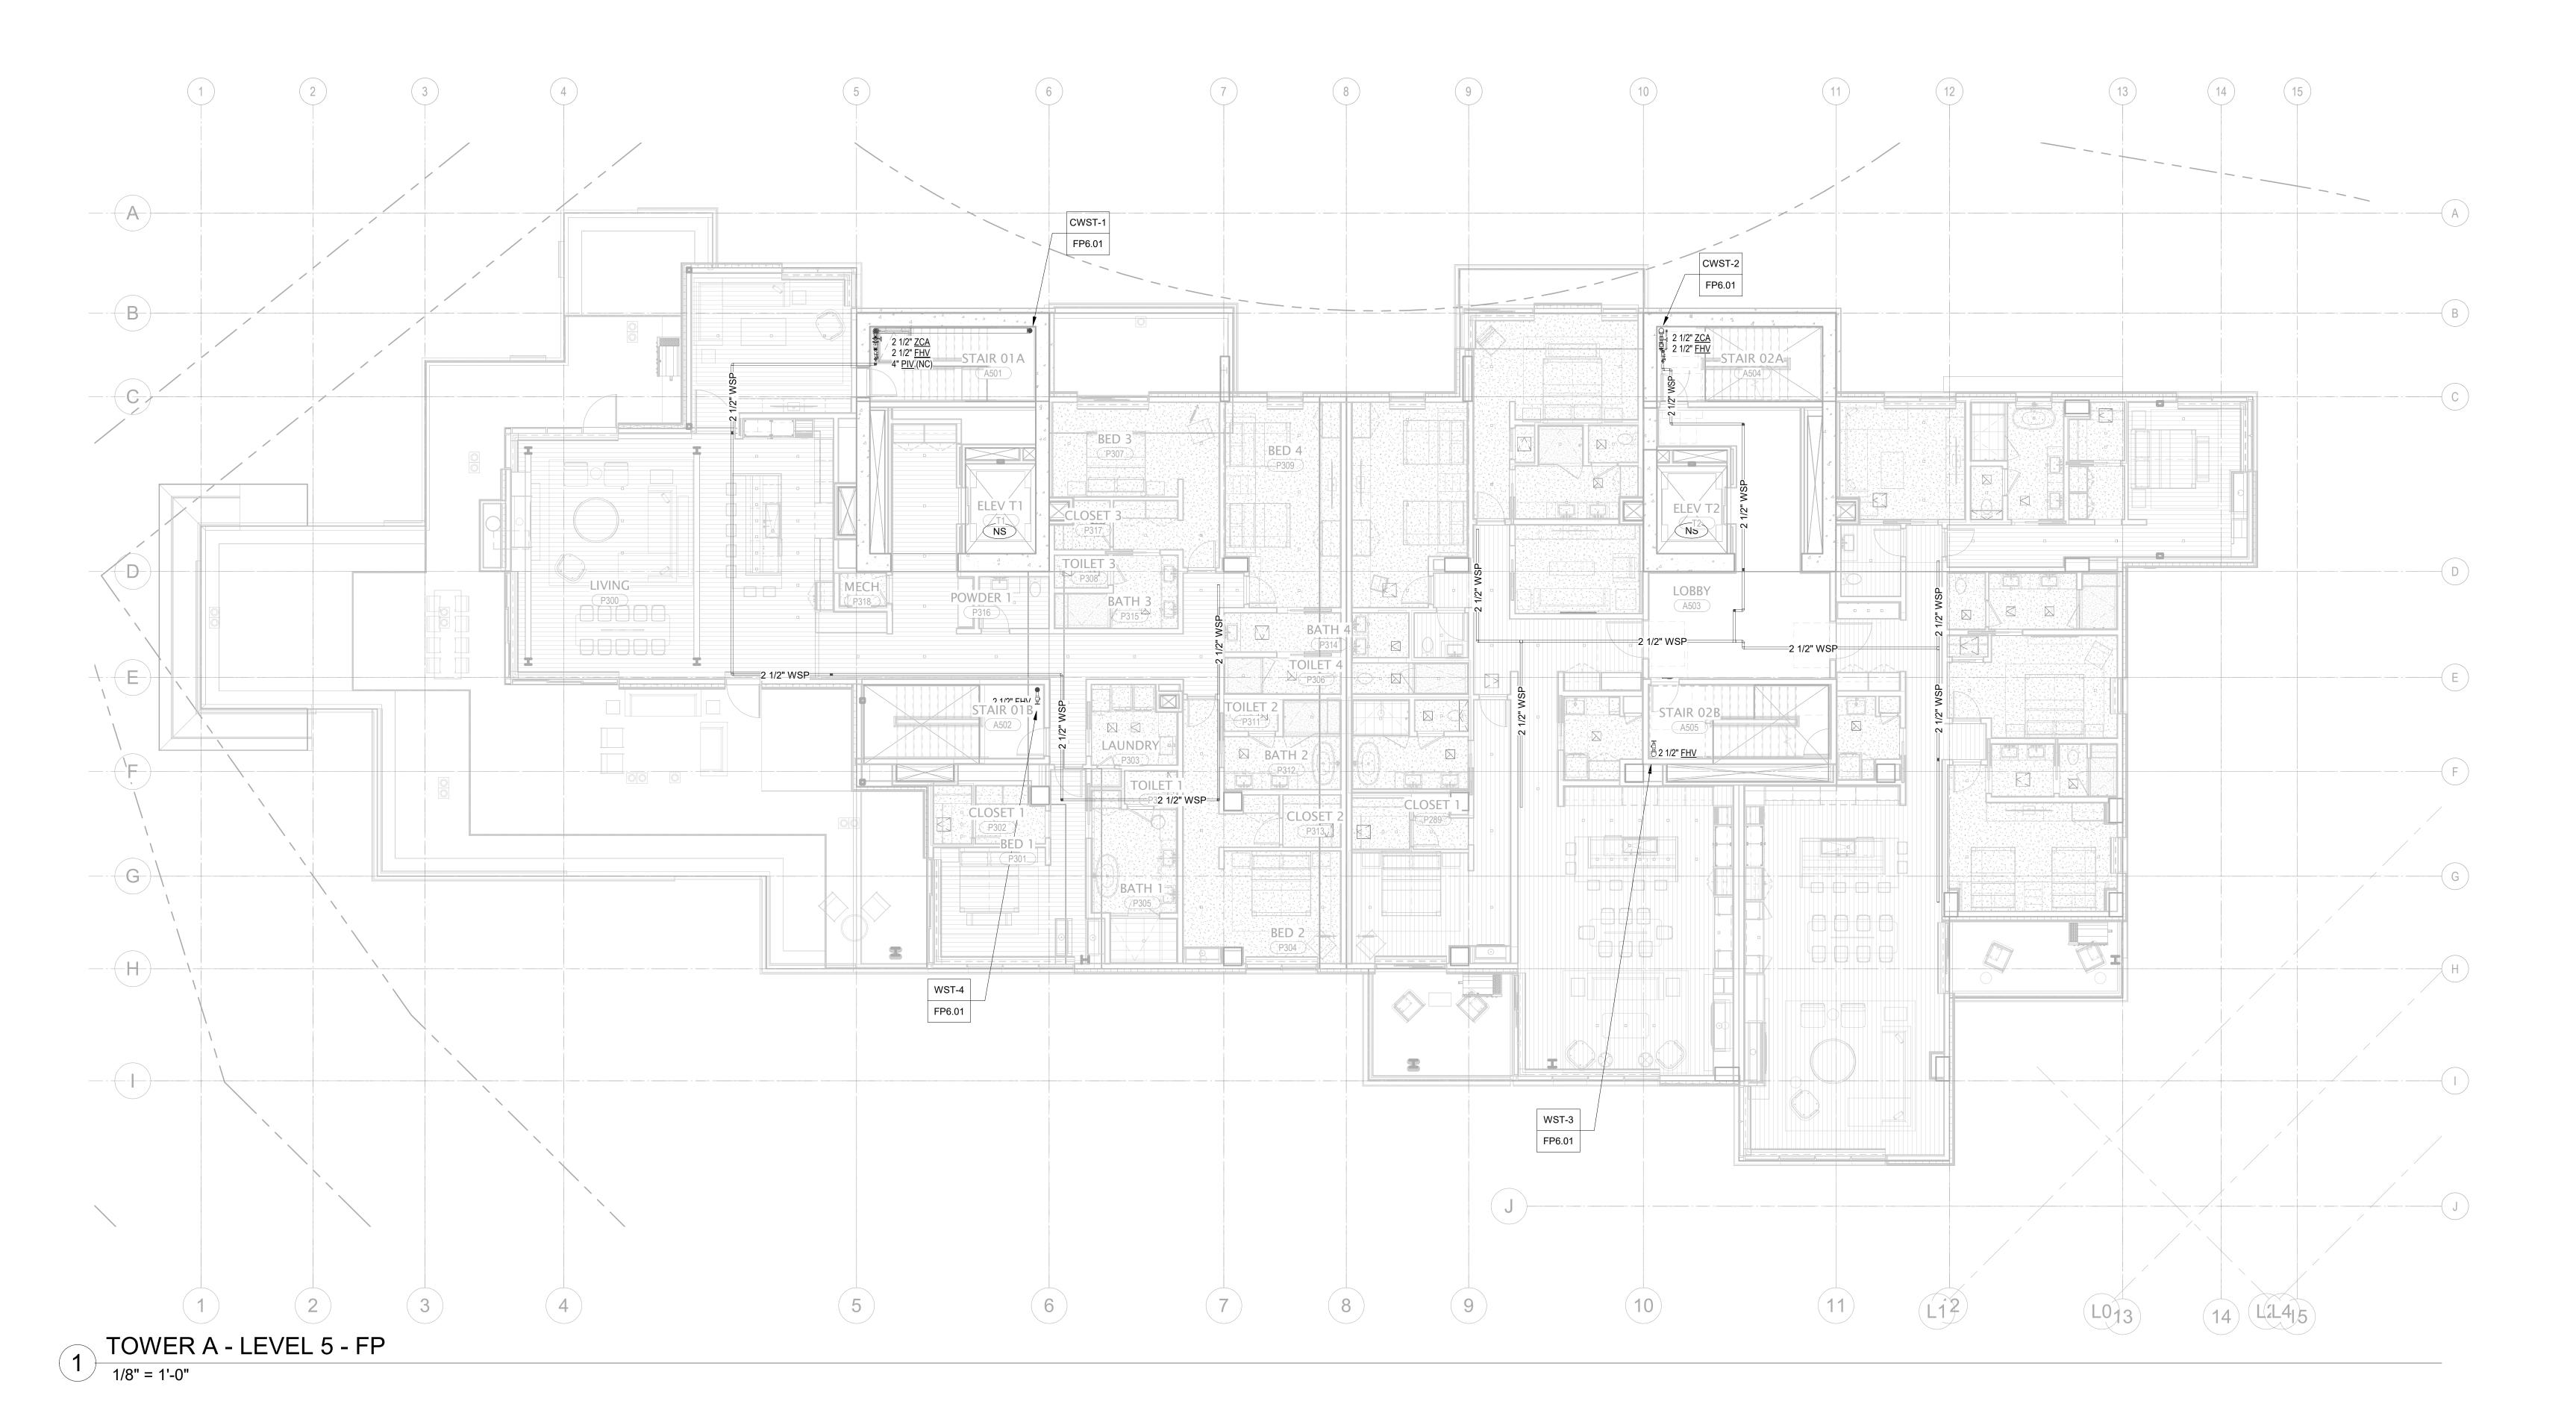
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FIRE PROTECTION PLAN
- TOWER A - LVL 4

FP2.2A.14

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project manager<u>JCC</u>

drawn by__CRB, SMK____

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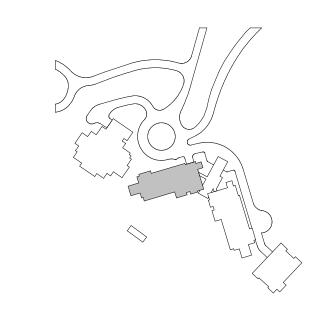
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FIRE PROTECTION PLAN - TOWER A - LVL 5

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AREAS WITHOUT FINISHED CEILINGS.

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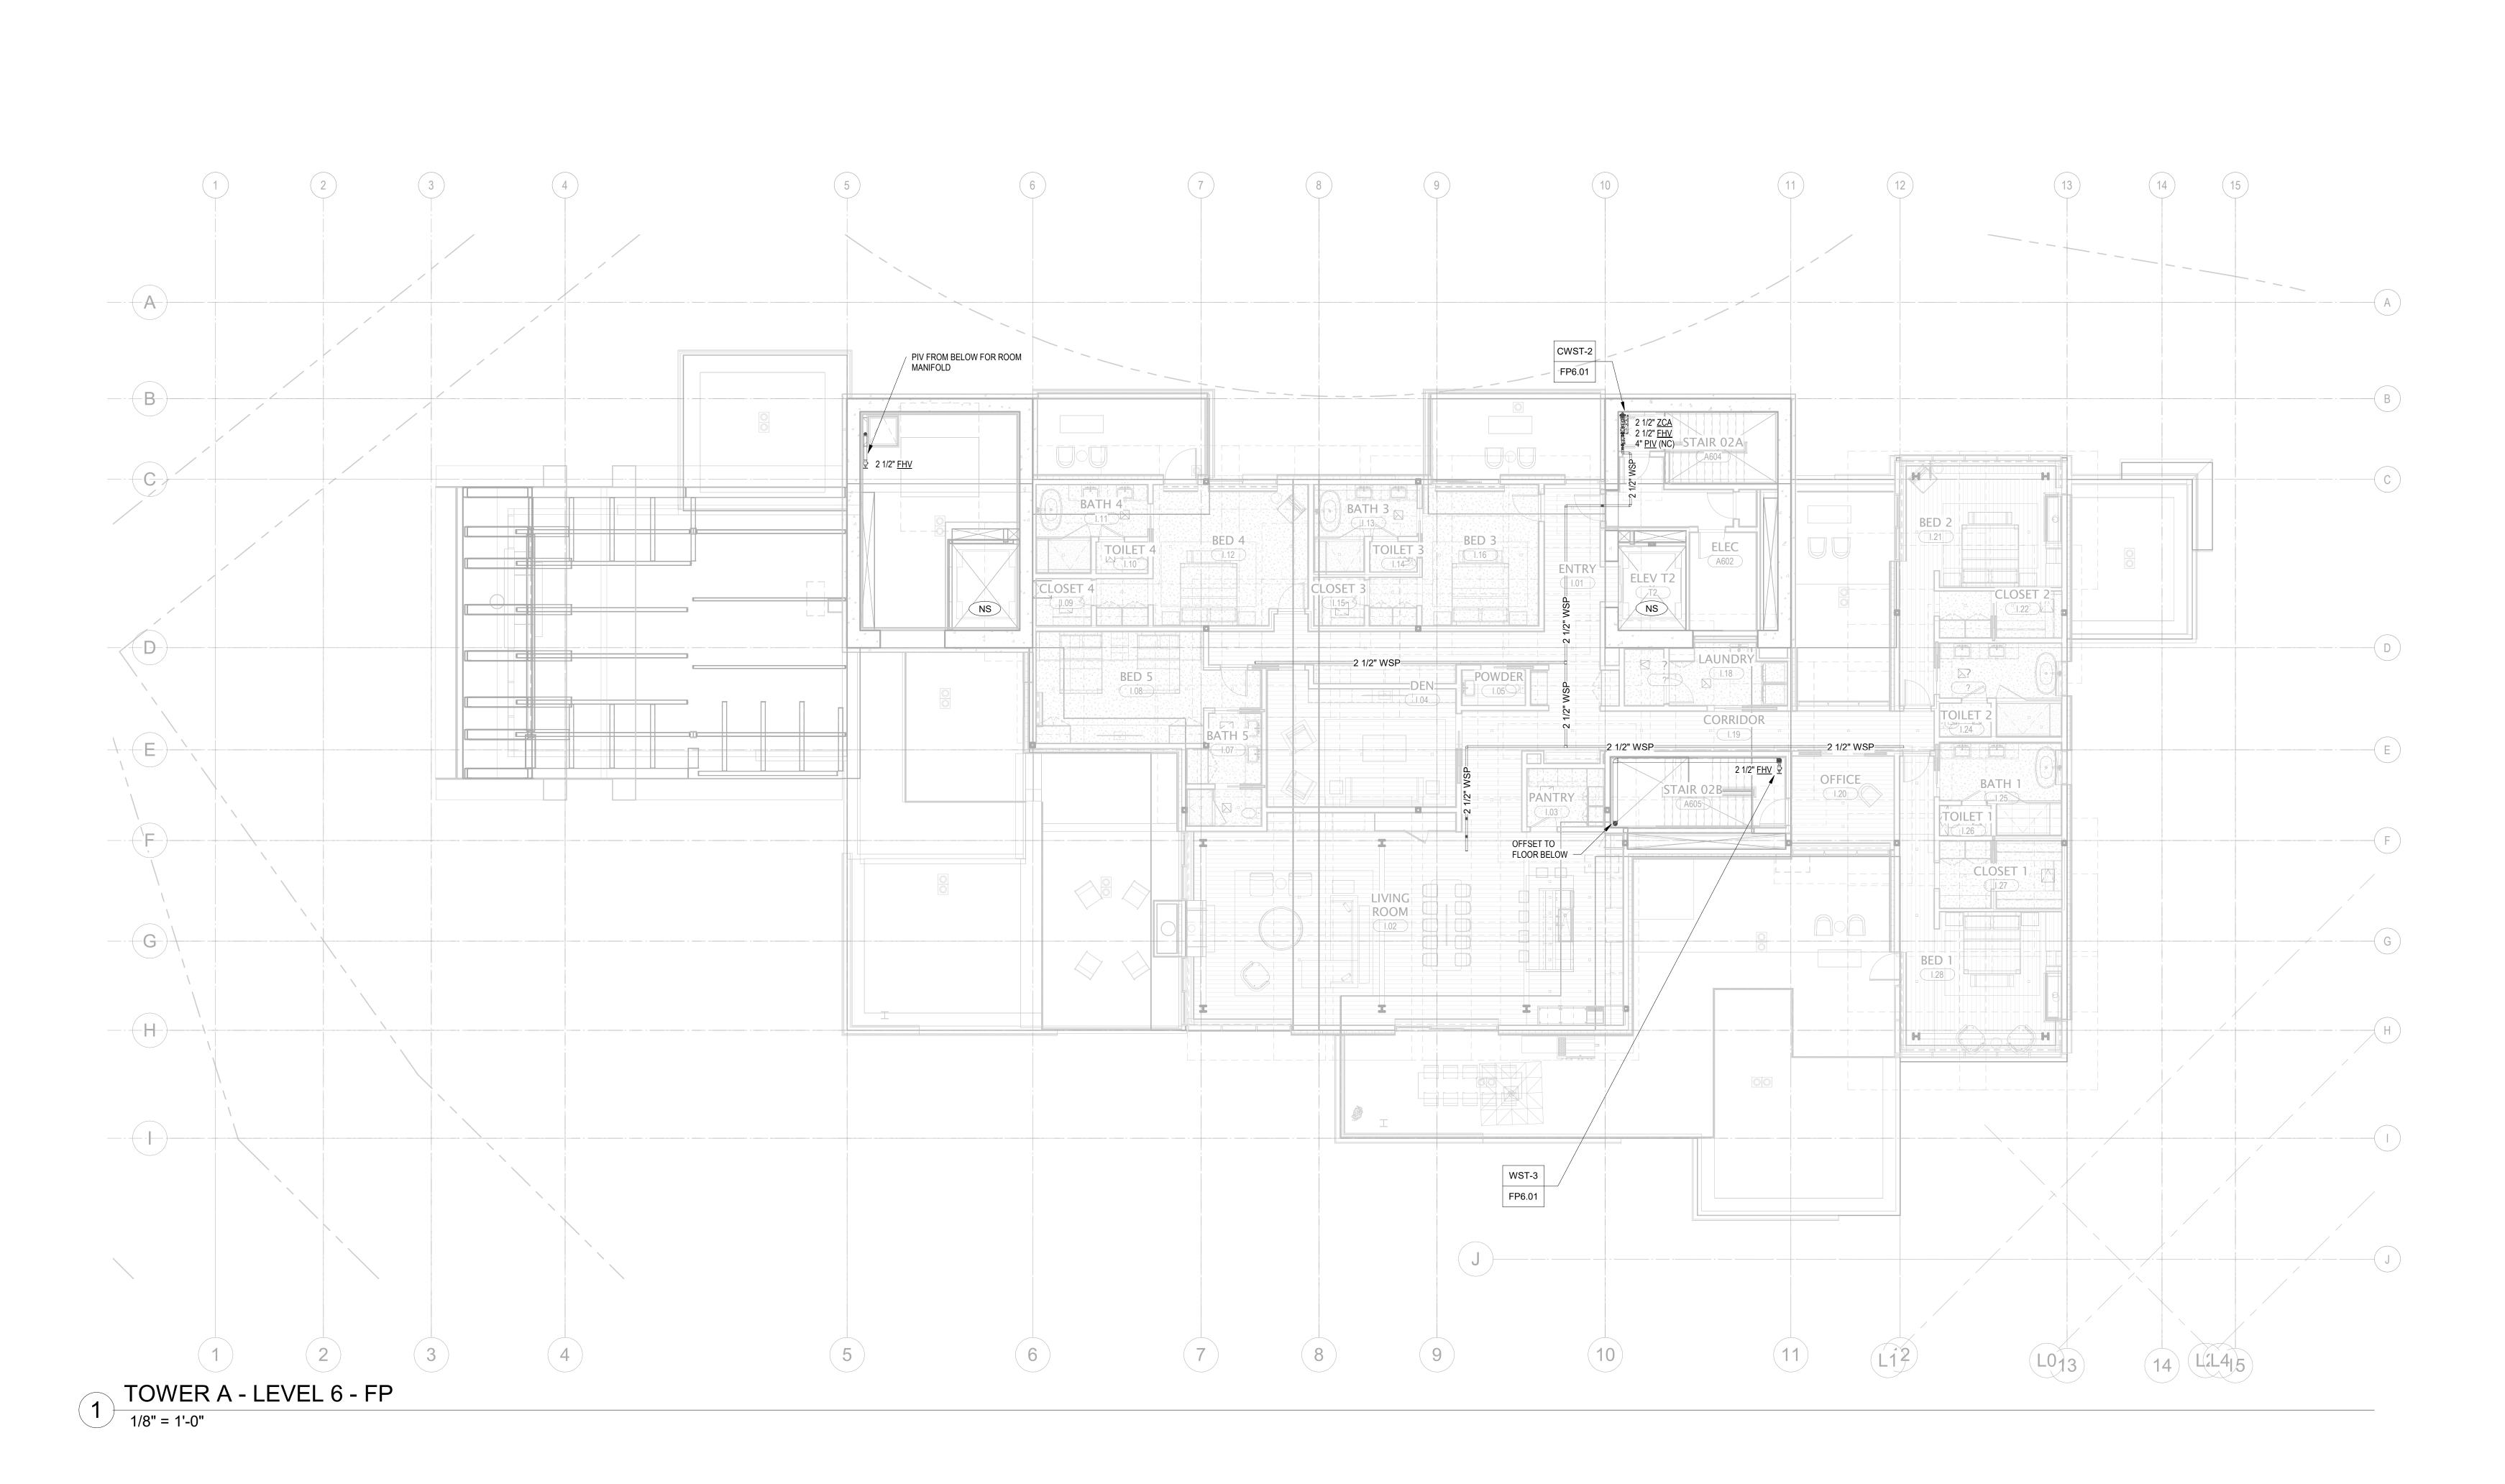
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FIRE PROTECTION PLAN - TOWER A - LVL 6

FP2.2A.16



GENERAL NOTES:

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1. SCOPE OF WORK INCLUDES SPRINKLER PROTECTION THROUGHOUT ALL AREAS IN

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principal architect


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FIRE PROTECTION PLAN - TOWER A - ROOF

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1. SCOPE OF WORK INCLUDES SPRINKLER PROTECTION THROUGHOUT ALL AREAS IN ACCORDANCE WITH NFPA 13. SPRINKLERS ARE INDICATED IN AREAS WITH FINISHED CEILINGS FOR COORDINATION PURPOSES. INSTALLING CONTRACTOR SHALL BE RESPONSIBLE FOR DETAILED DESIGN OF BRANCH PIPING AND UPRIGHT SPRINKLERS IN AREAS WITHOUT FINISHED CEILINGS. 2. REFER TO TYPICAL UNIT PLANS FOR SPRINKLER LAYOUTS ON RESIDENTIAL FLOORS.

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> principal architect_____ project manager__JCC____ drawn by__CRB, SMK____ -


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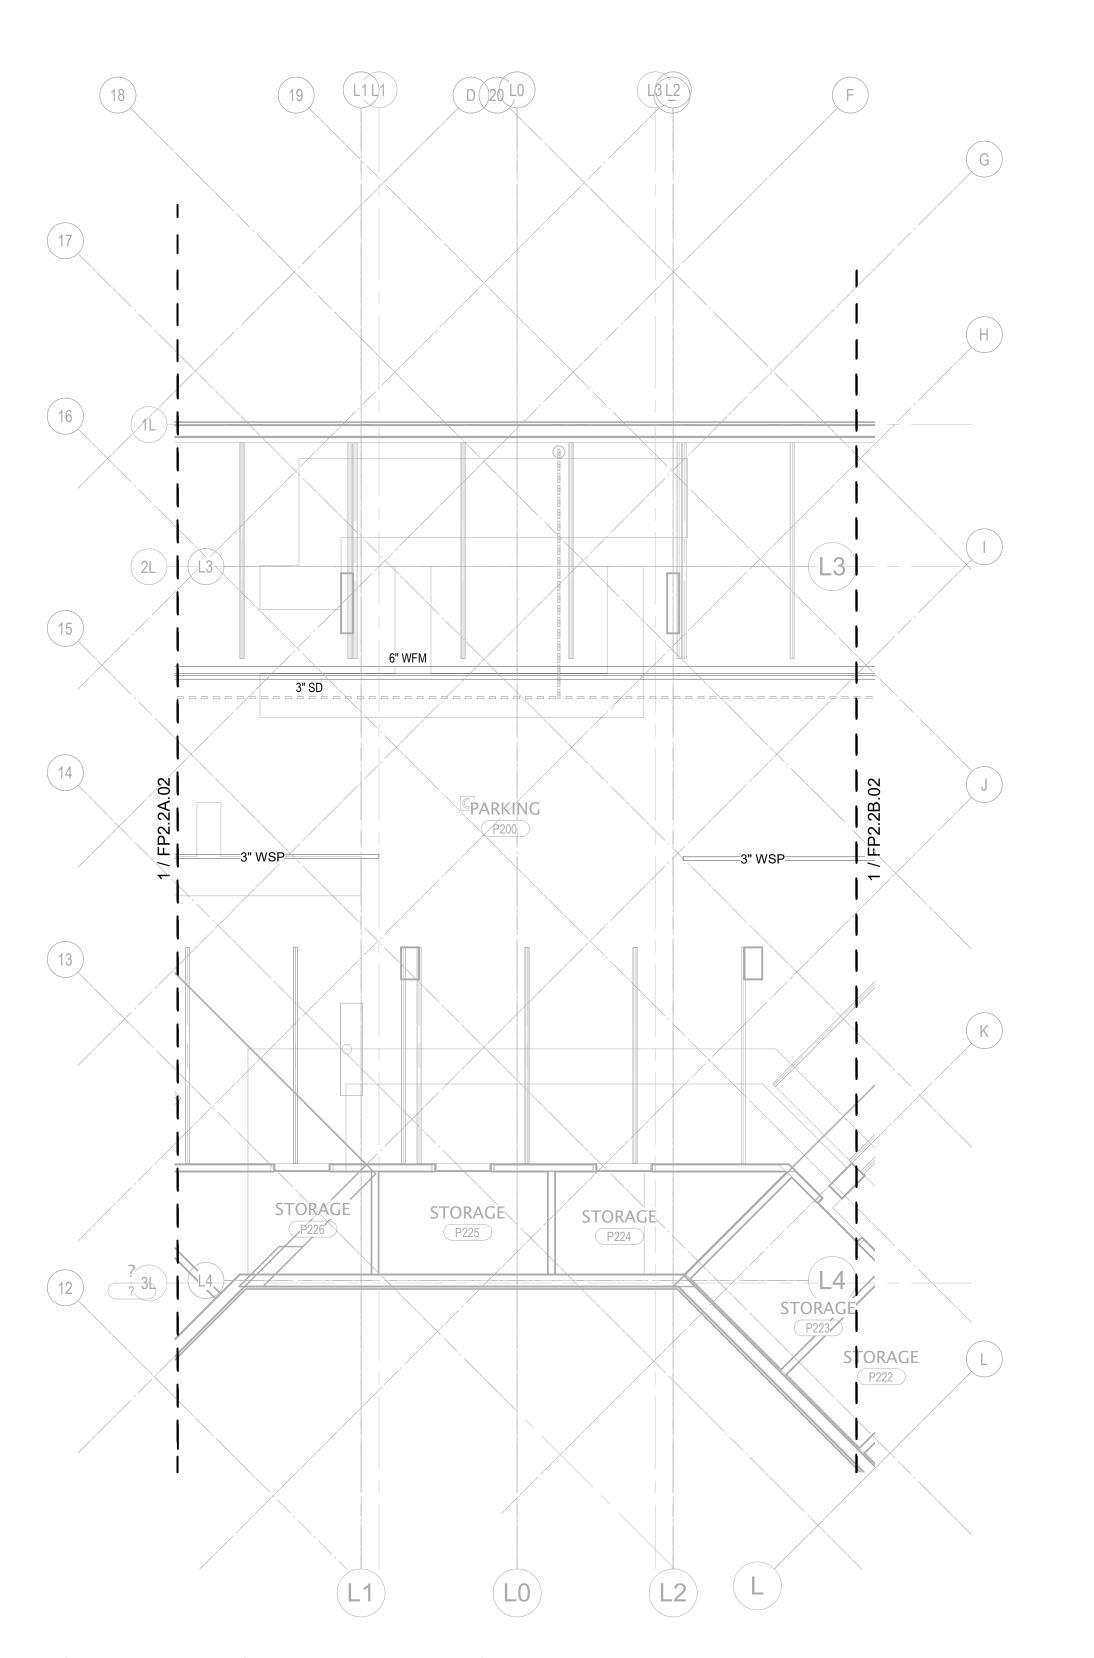
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FIRE PROTECTION PLAN
- TOWER AB - LOBBY




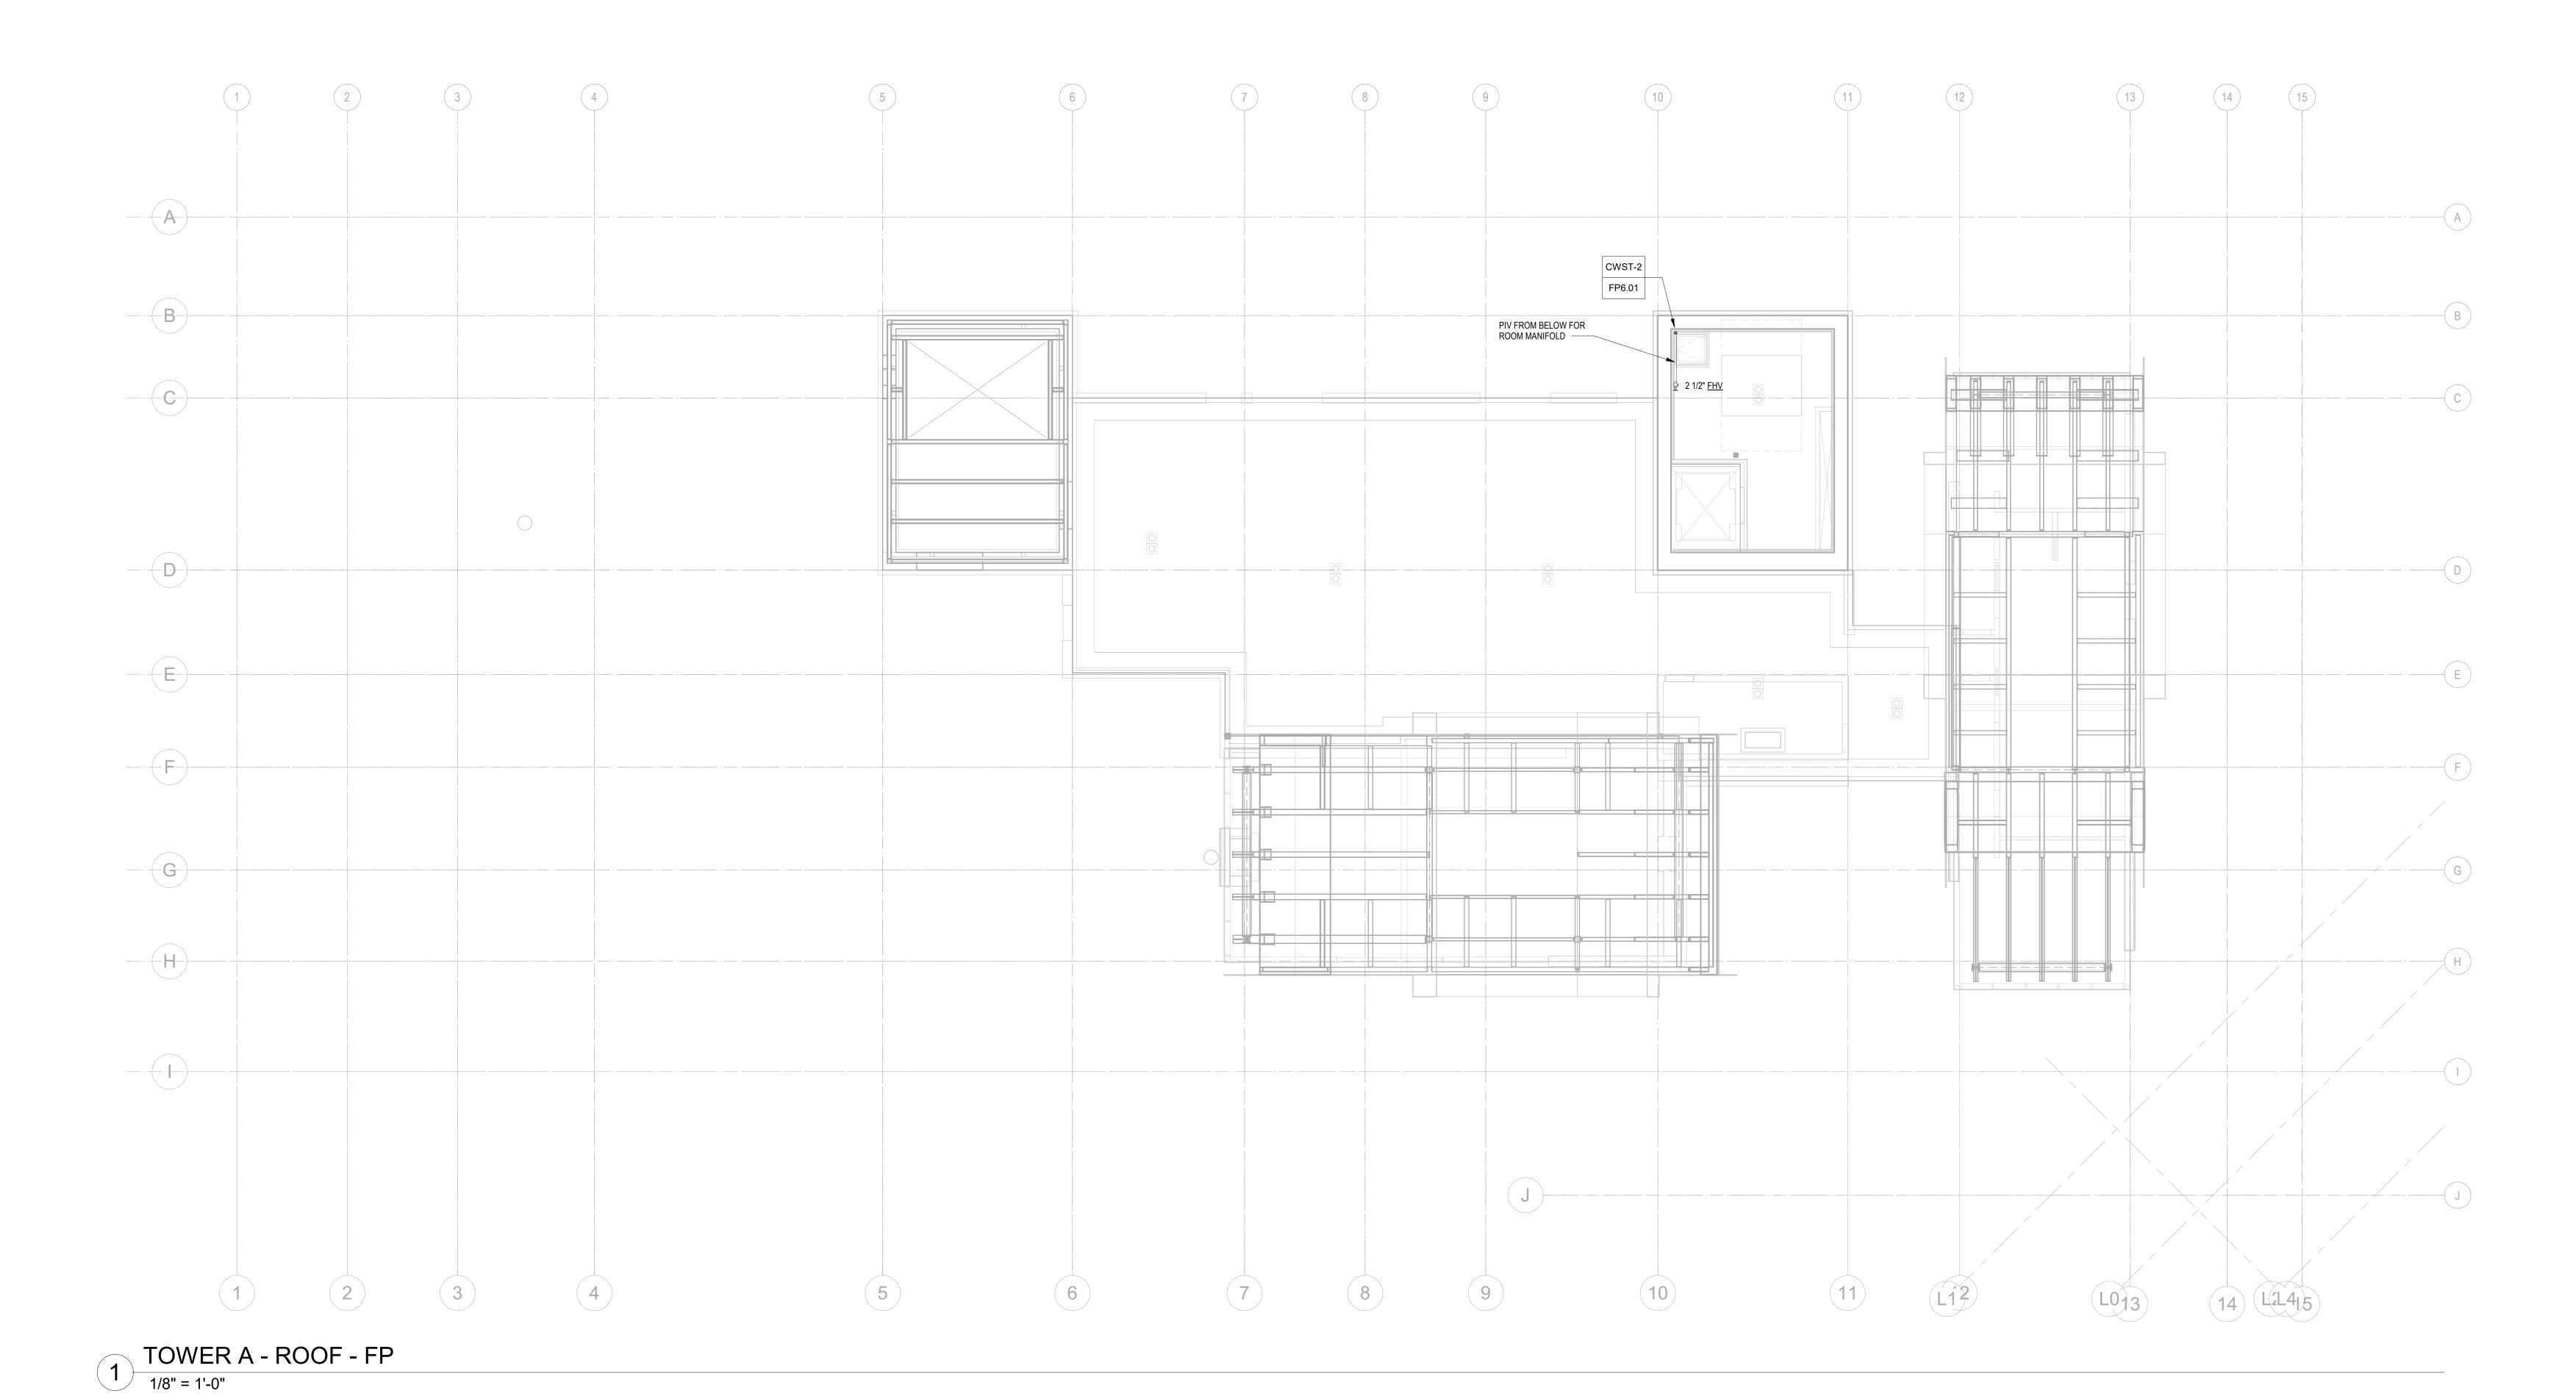

TOWER AB LOBBY - PARKING LEVEL 2 - FP

SHEET KEYED NOTES:

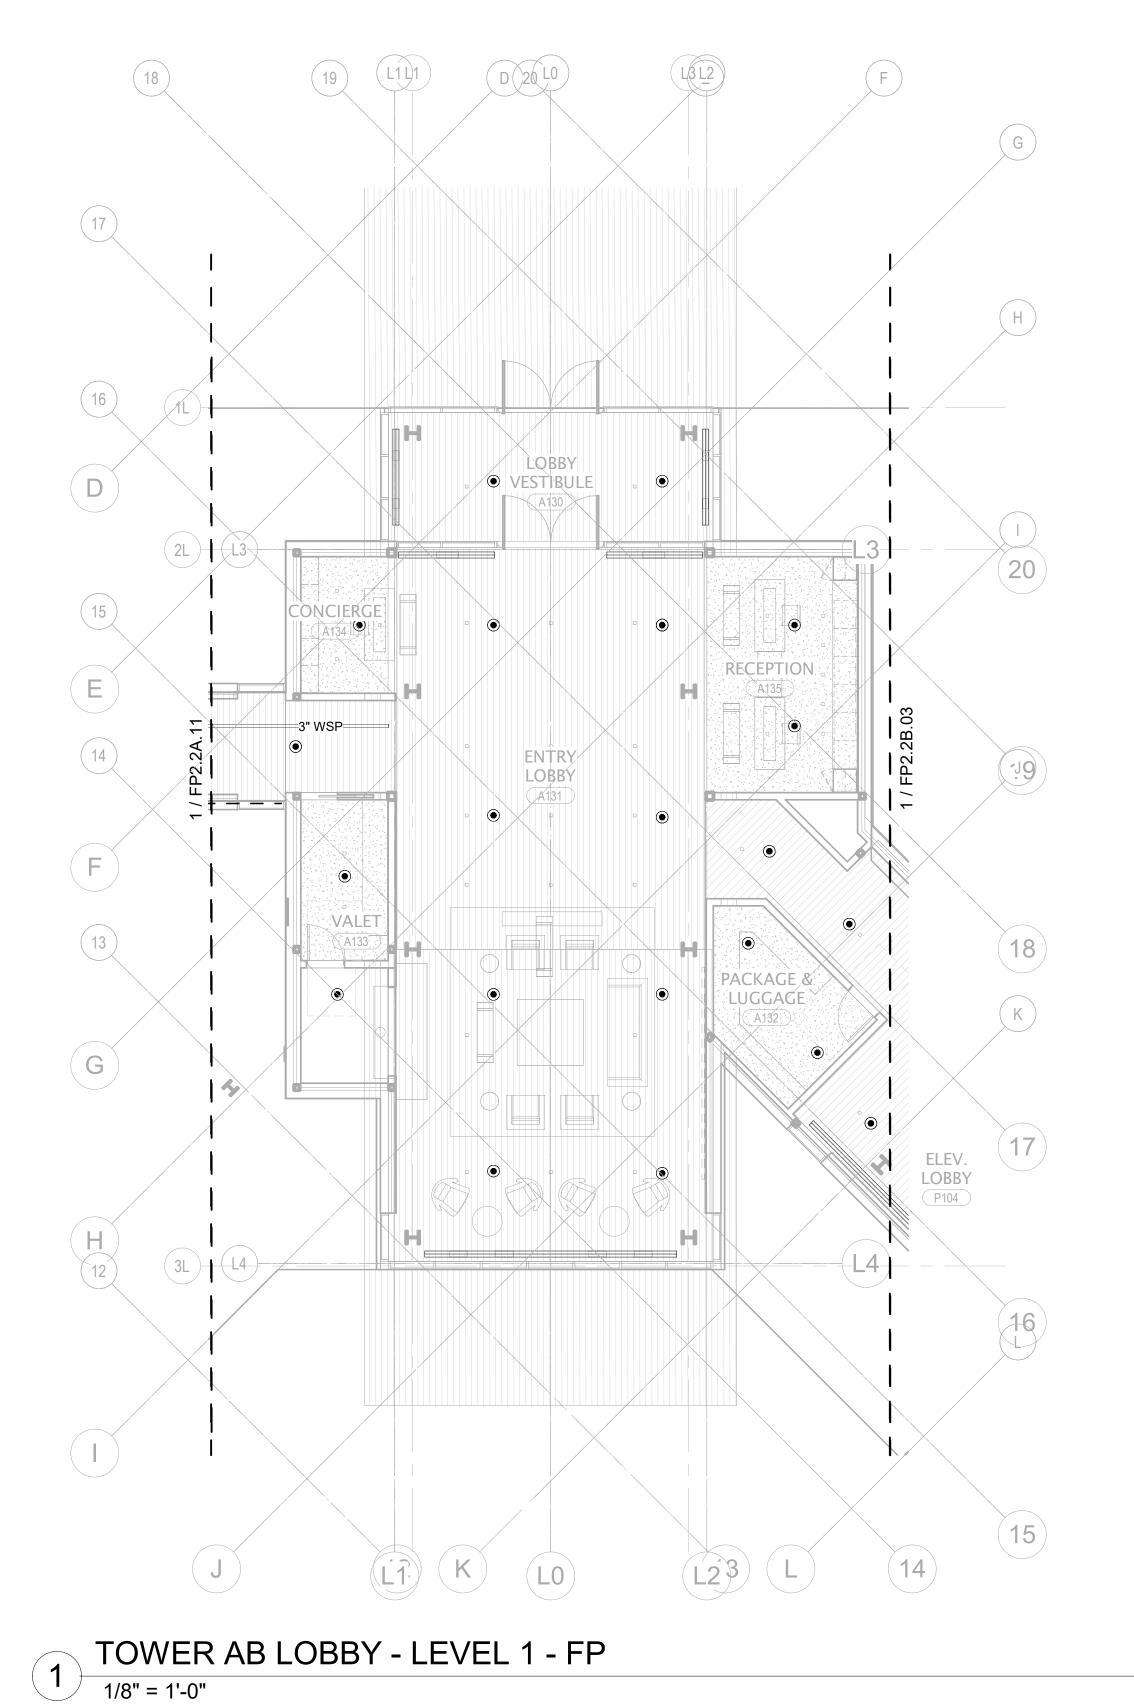1 DISCHARGE SPRINKLER DRAIN RISER TO OPEN END DRAIN.

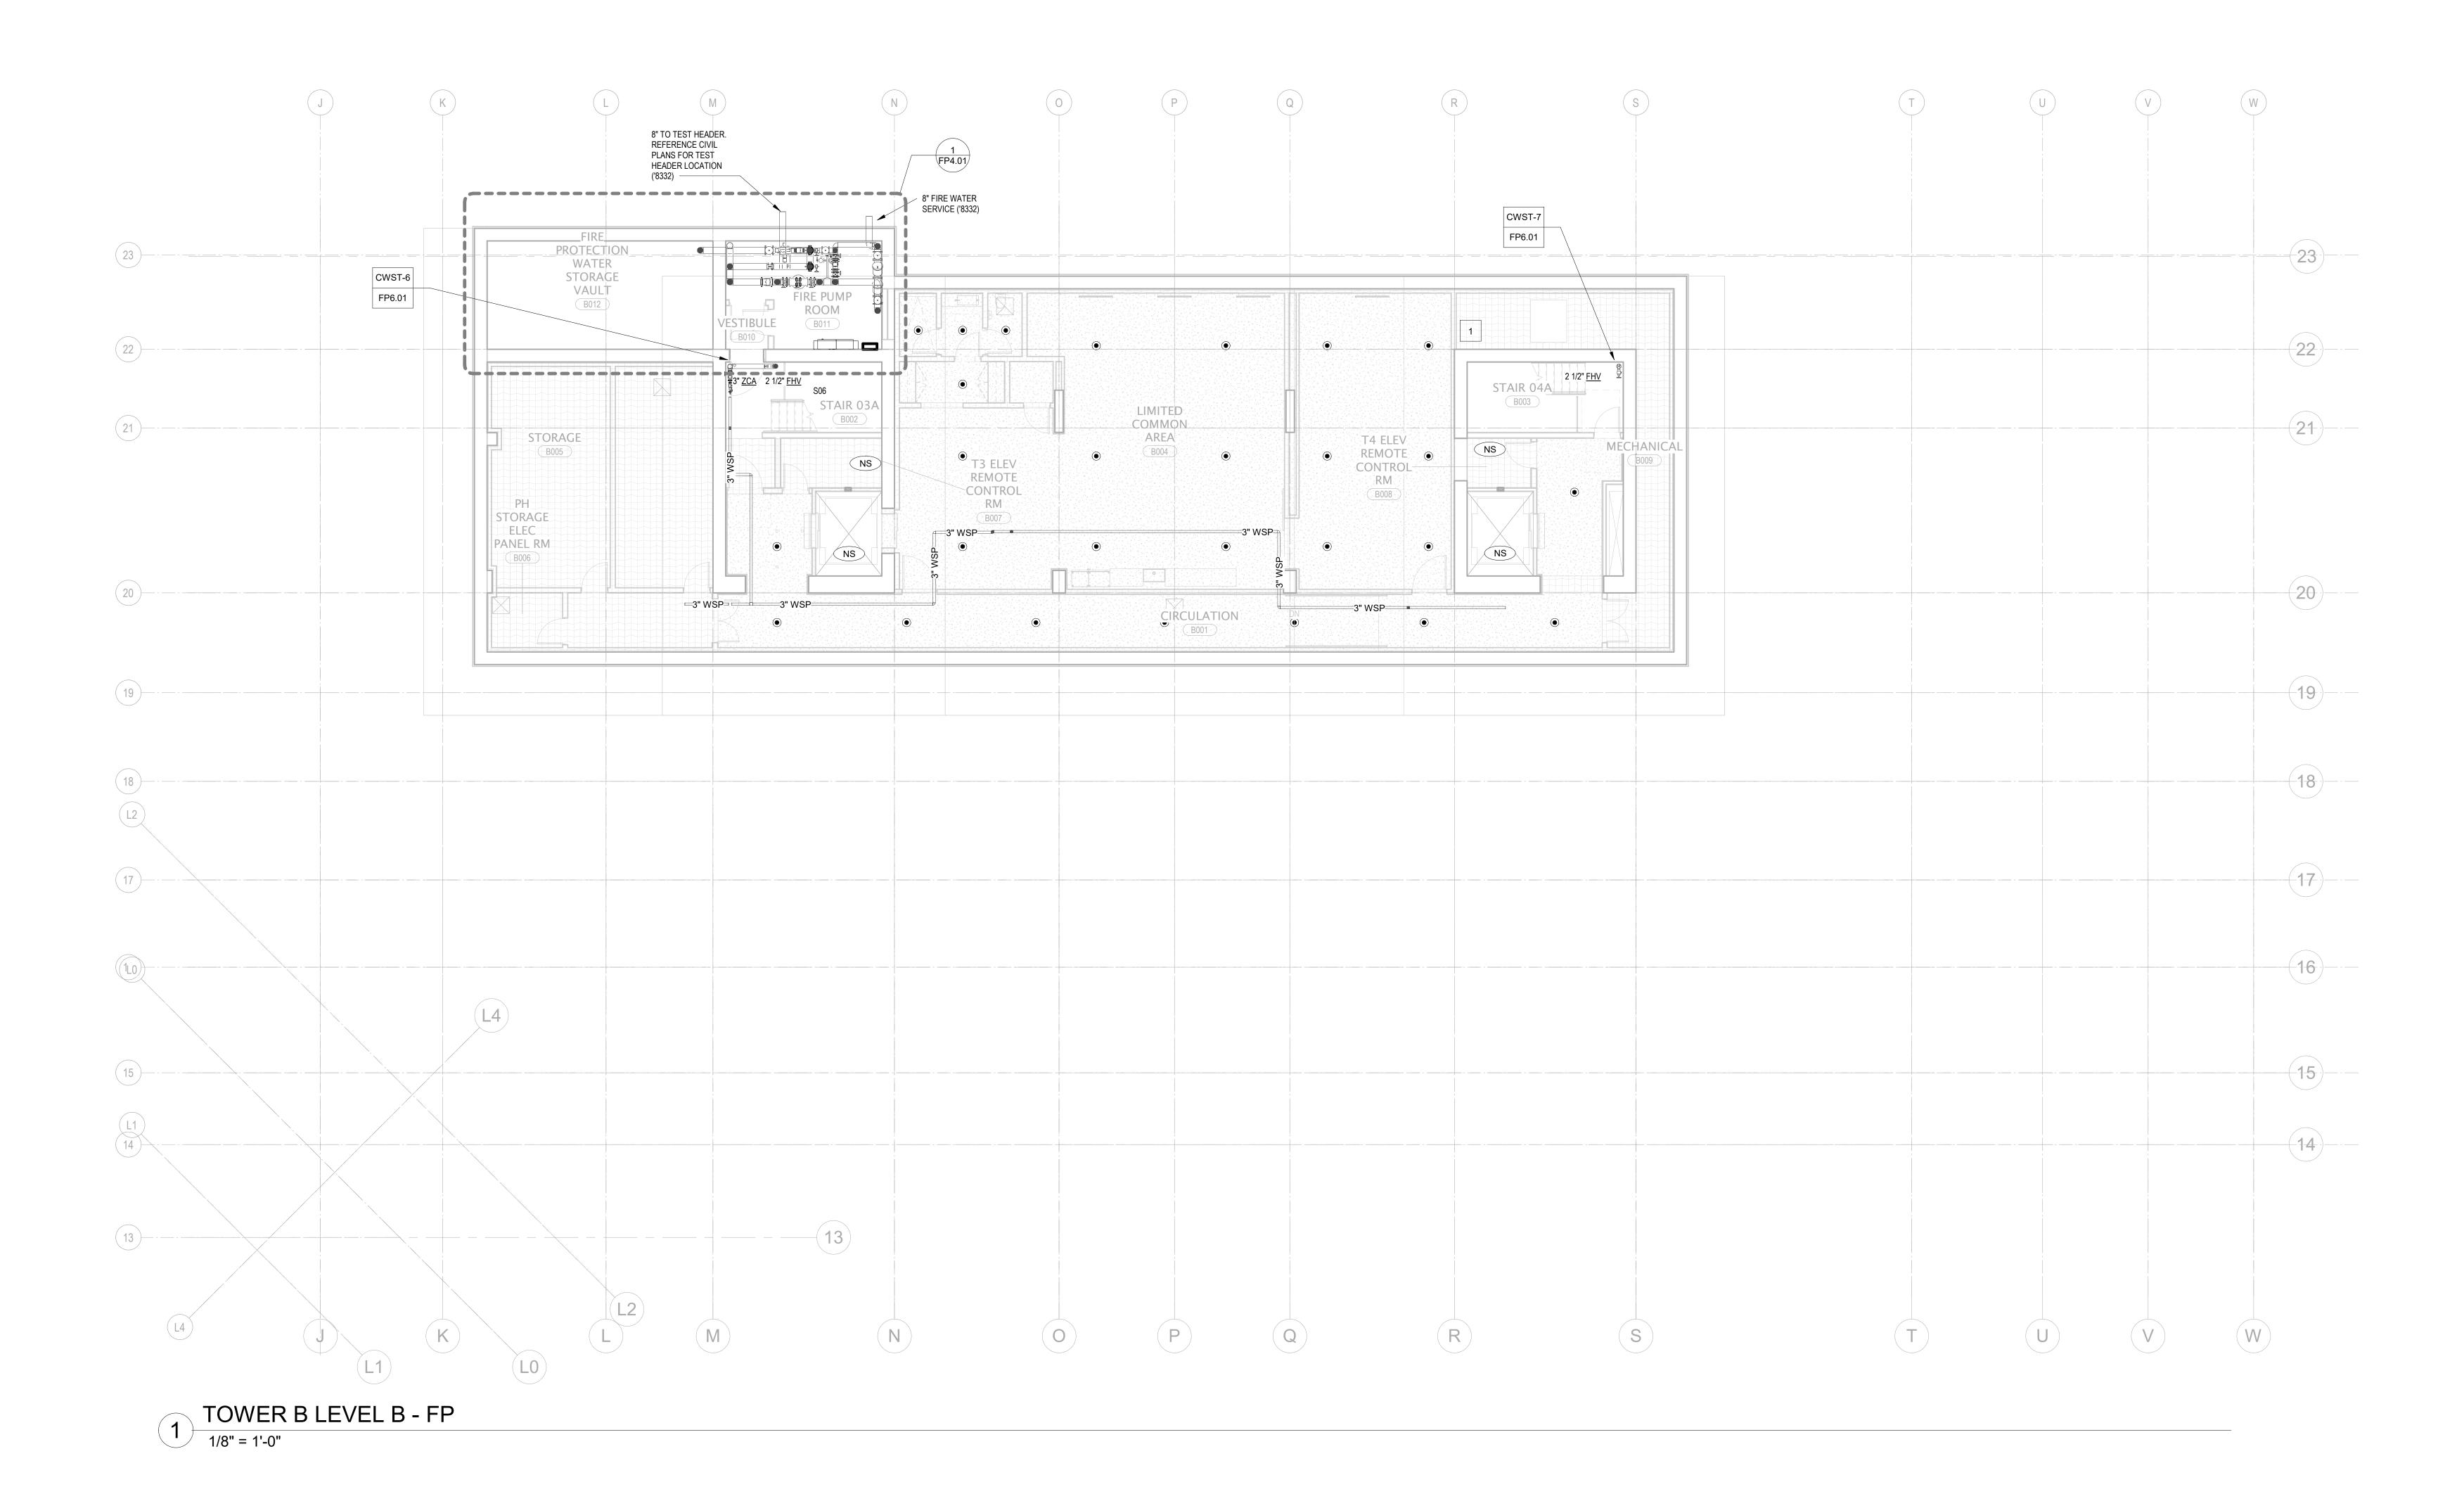

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project:

SOMMET BLANC - AB
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project manager__JCC_____

drawn by__CRB, SMK_____

checked by____


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FIRE PROTECTION PLAN
- TOWER B - LVL B



1 TOWER B - LEVEL P2 - FP

1/8" = 1'-0"

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project manager__JCC_____

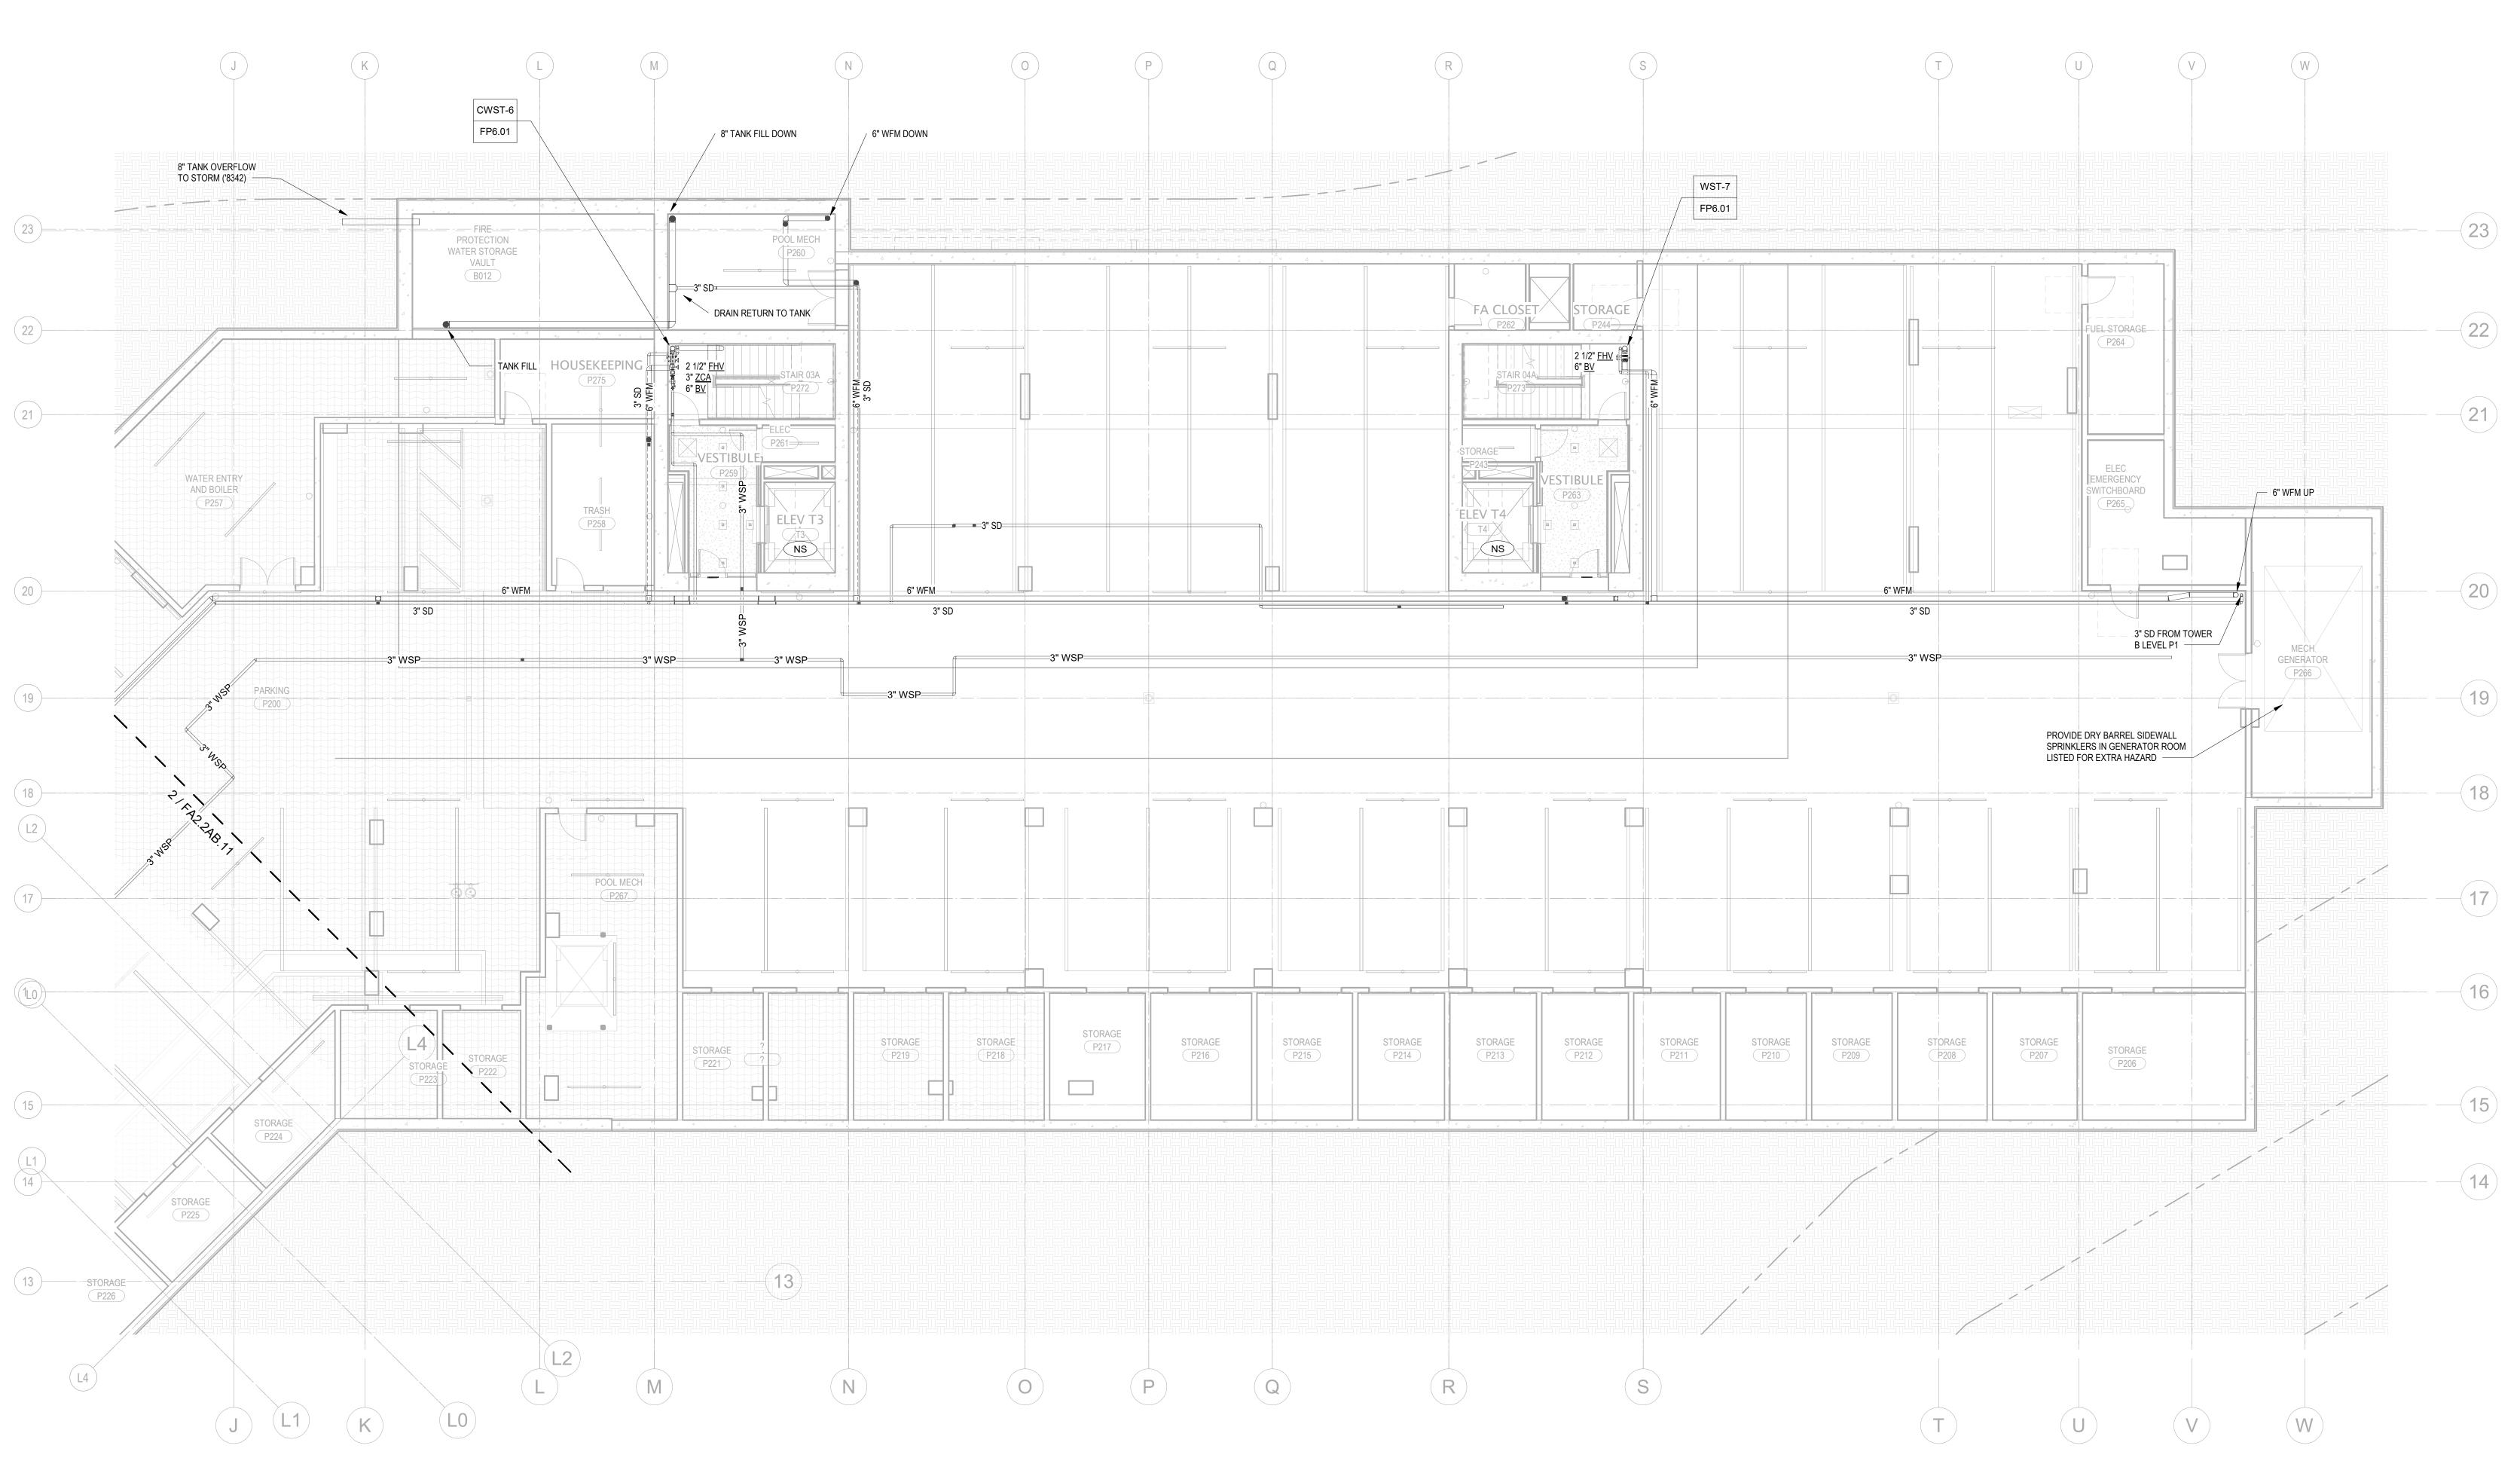drawn by__CRB, SMK_____

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job no. 20052
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FIRE PROTECTION PLAN - TOWER B - LVL P2

2. REFER TO TYPICAL UNIT PLANS FOR SPRINKLER LAYOUTS ON RESIDENTIAL FLOORS.

AREAS WITHOUT FINISHED CEILINGS.

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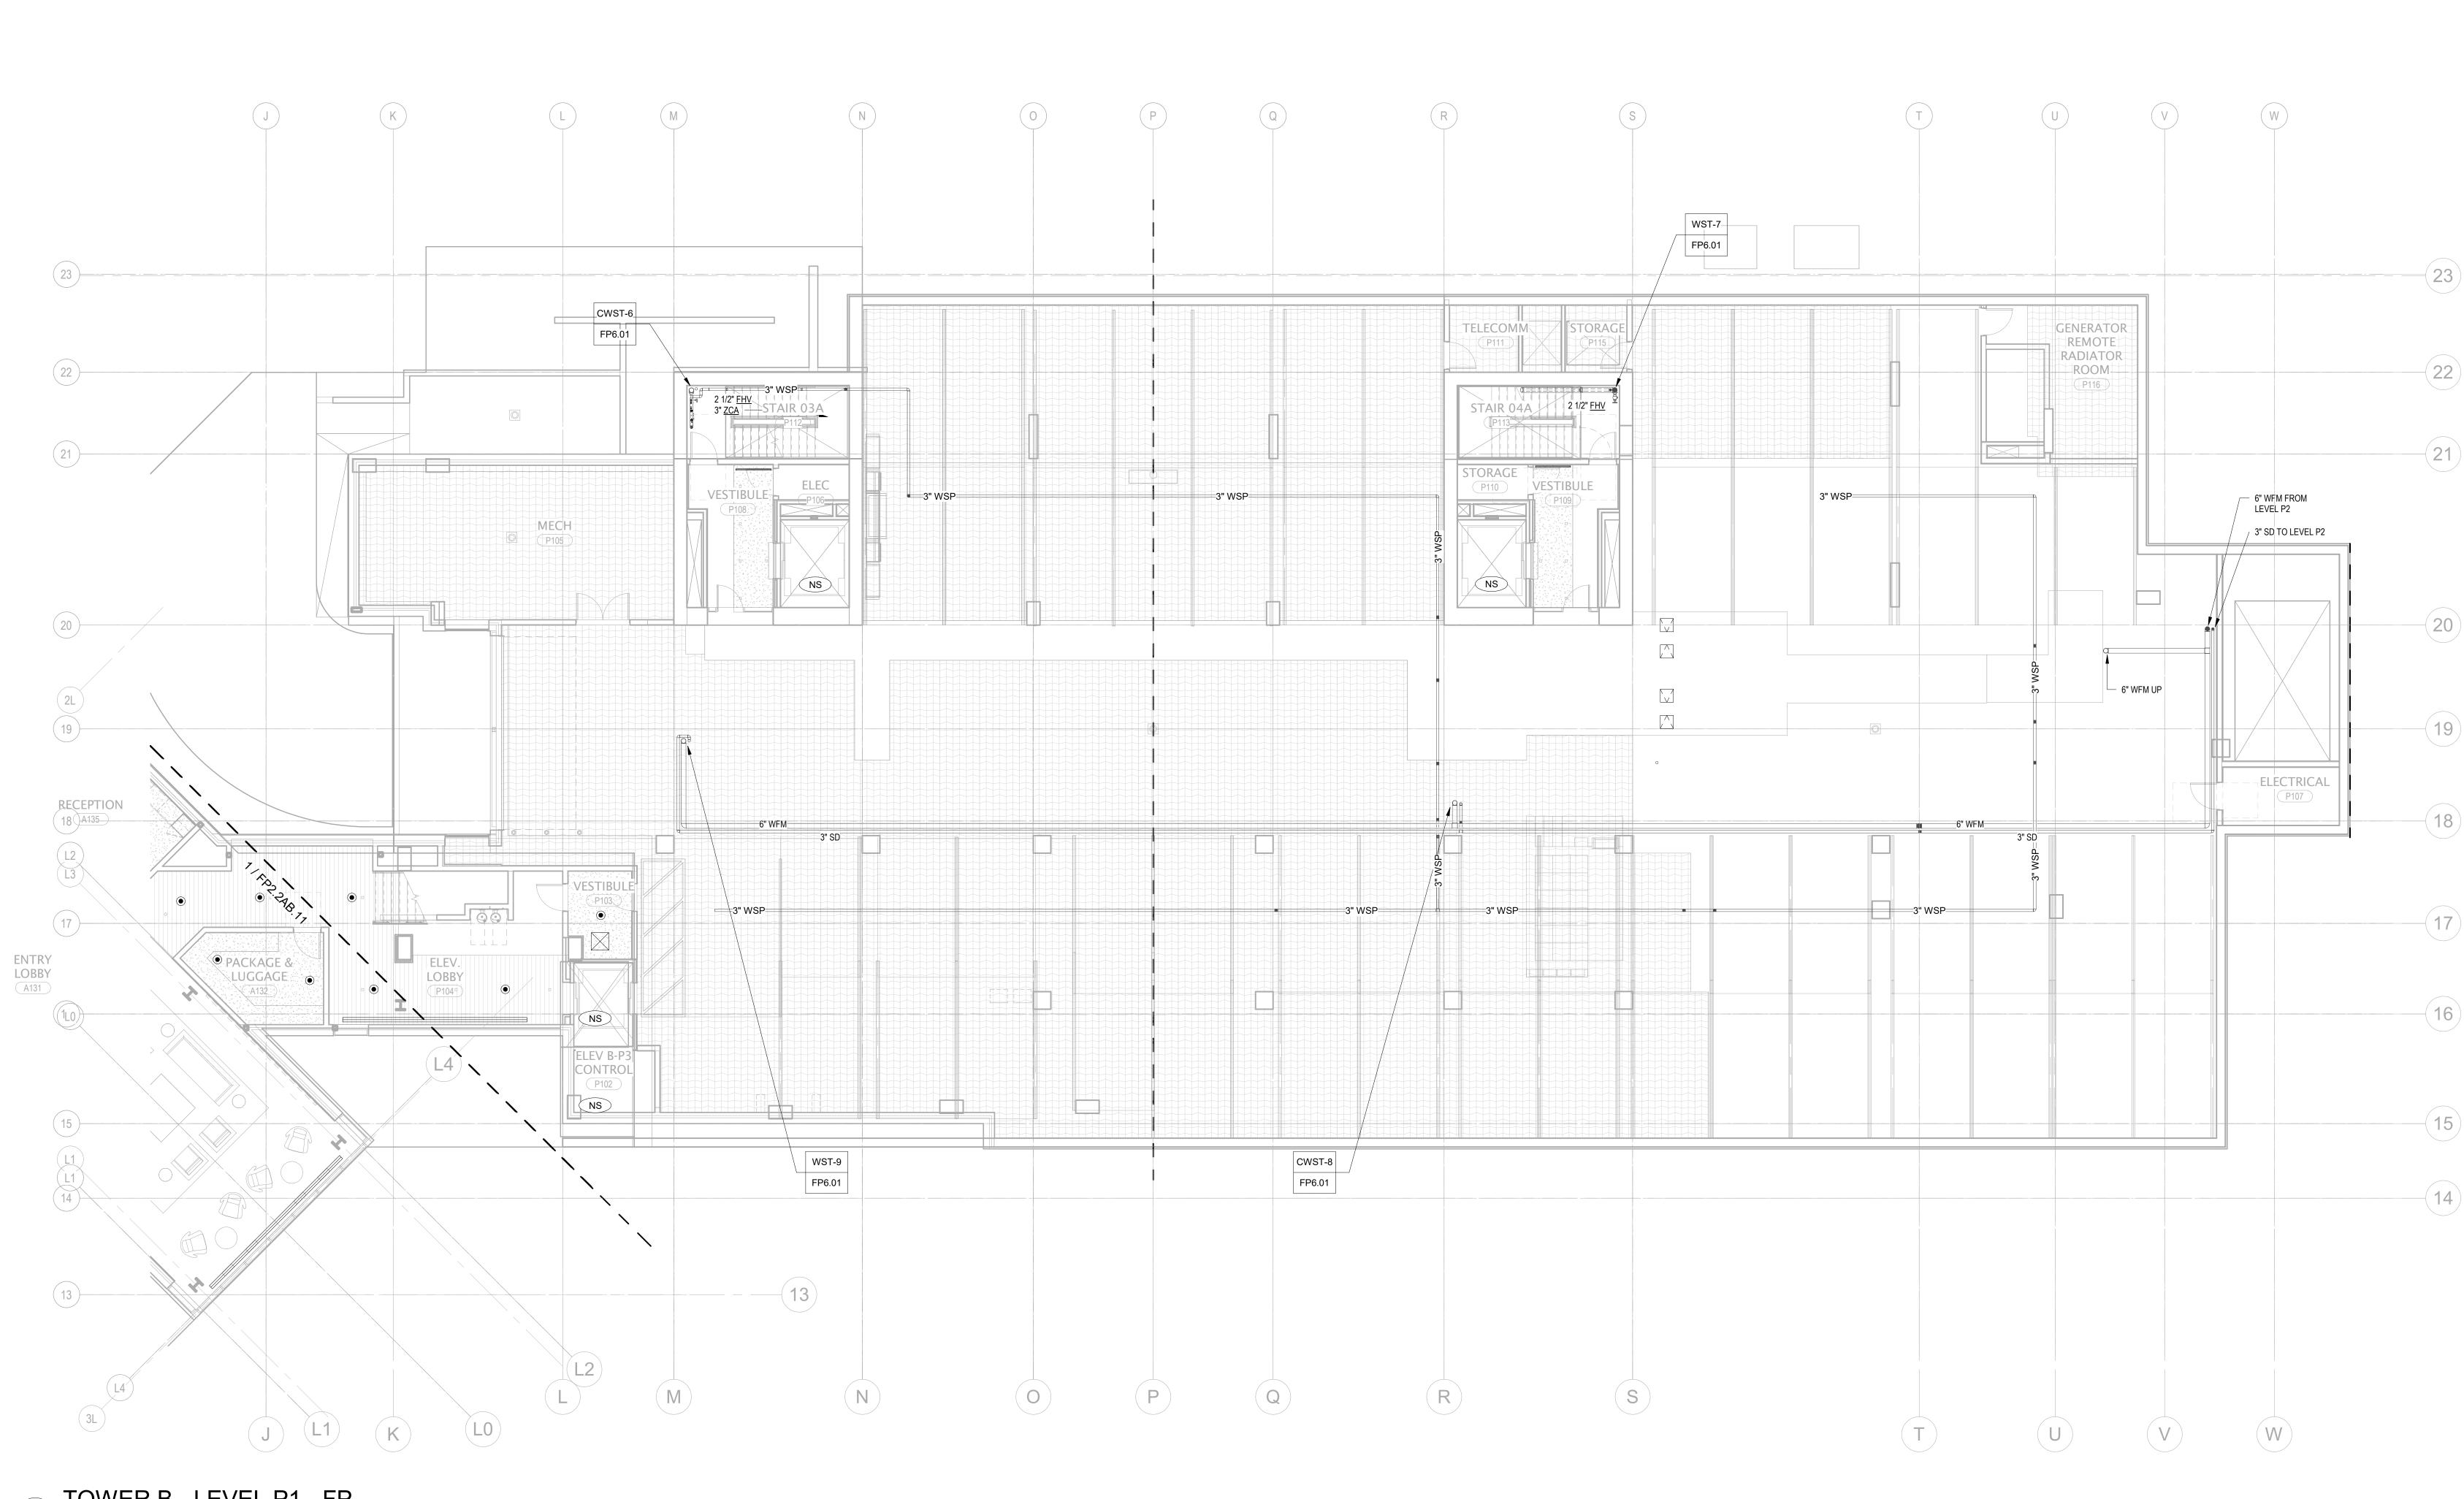
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FIRE PROTECTION PLAN
- TOWER B - LVL P1 FP2.2B.03



1 TOWER B - LEVEL P1 - FP

GENERAL NOTES:

ACCORDANCE WITH NFPA 13. SPRINKLERS ARE INDICATED IN AREAS WITH FINISHED CEILINGS FOR COORDINATION PURPOSES. INSTALLING CONTRACTOR SHALL BE RESPONSIBLE FOR DETAILED DESIGN OF BRANCH PIPING AND UPRIGHT SPRINKLERS IN AREAS WITHOUT FINISHED CEILINGS. 2. REFER TO TYPICAL UNIT PLANS FOR SPRINKLER LAYOUTS ON RESIDENTIAL FLOORS.

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FIRE PROTECTION PLAN
- TOWER B - LVL 1 FP2.2B.11

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CWST-6 FP6.01 BED 3 WST-7 FP6.01 BED 2 2 1/2" <u>FHV</u> 2 1/2" <u>ZCA</u> ₹ 21/2" FHV STAIR 04A STAIR 03A TOILET 2 TOILET 4 BED 4 ELEV T3 LAUNDRY 2 1/2" WSP ENTRY ROOM LOBBY —2 1/2" WSP—____ B200 2 1/2" WSP B203 2 1/2" WSP 2 1/2" WSP POWDER 1 2 1/2" WSP 2 1/2" WSP 2 1/2" WSP STAIR 04B 2 1/2" <u>FHV</u> 2 1/2" <u>ZCA</u> CLOSET 1 CWST-8 FP6.01 15 WST-9 FP6.01 1 TOWER B - LEVEL 2 - FP

Project:
SOMMET BLANC - AB

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project manager__JCC

drawn by__CRB, SMK

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job no. 20052
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FIRE PROTECTION PLAN - TOWER B - LVL 2

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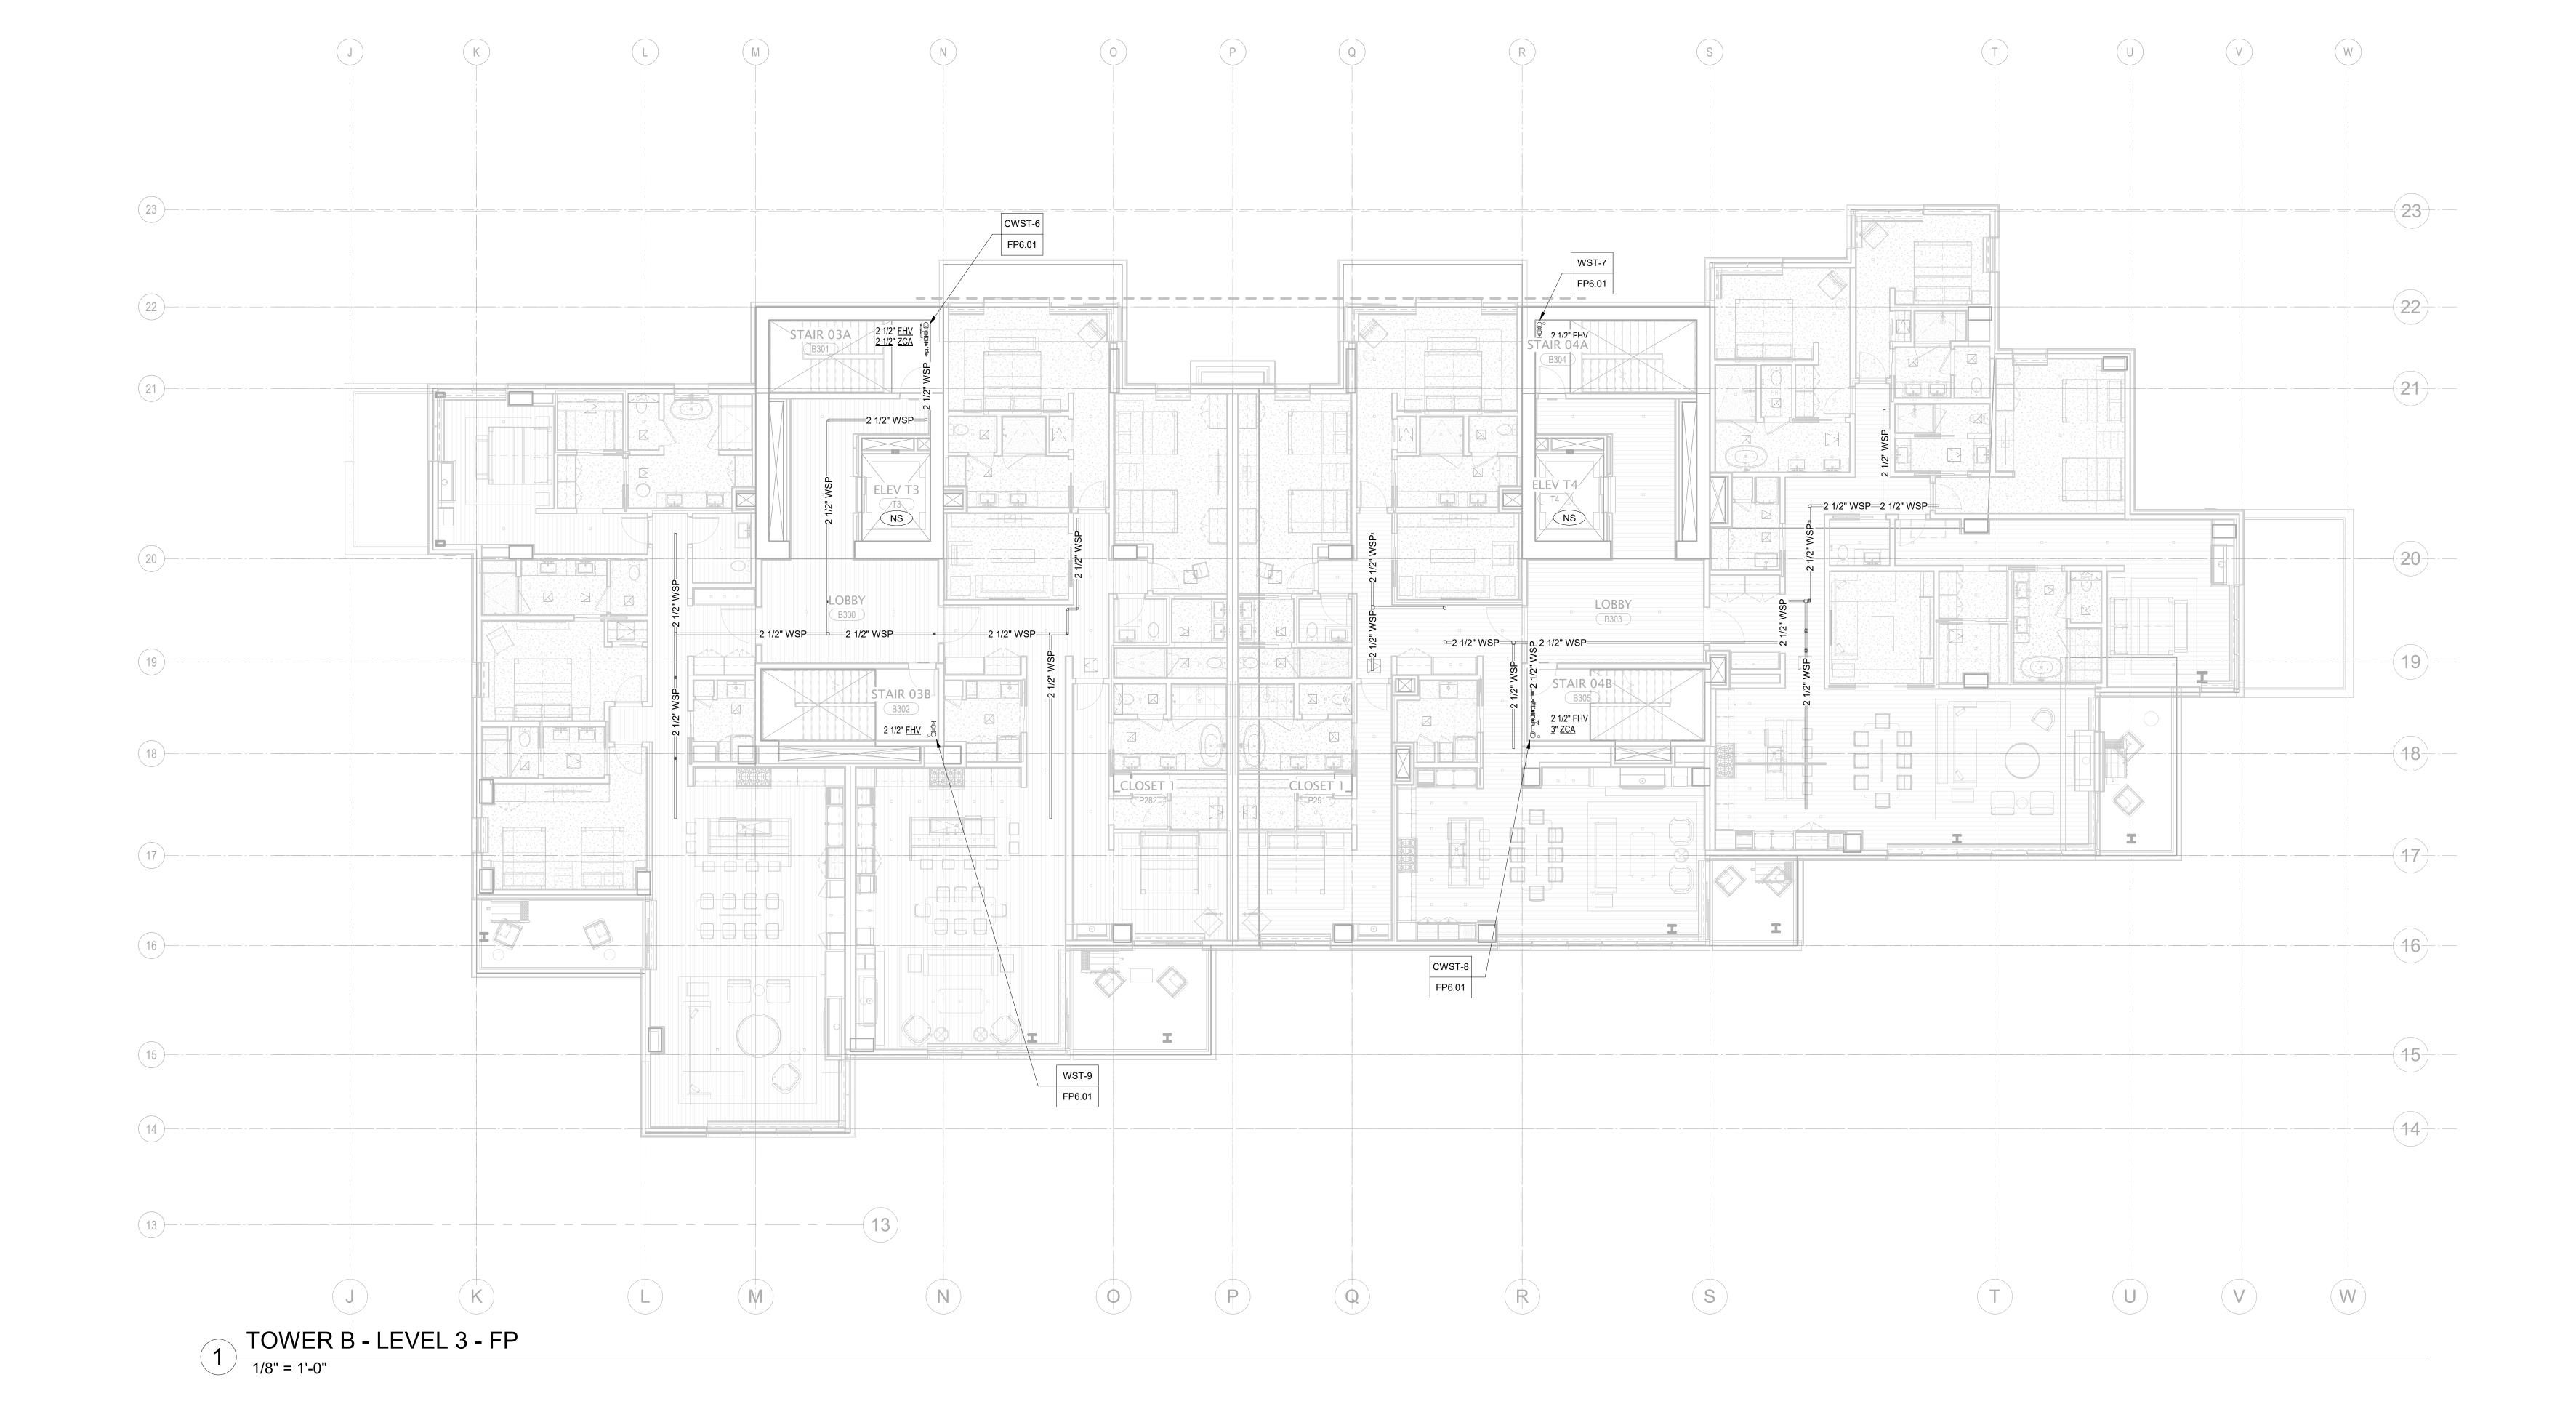
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checked by Checker job no. 20052 date 11/18/2022

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ISSUE FOR CONSTRUCTION 11/18/2022

FIRE PROTECTION PLAN
- TOWER B - LVL 3



1. SCOPE OF WORK INCLUDES SPRINKLER PROTECTION THROUGHOUT ALL AREAS IN ACCORDANCE WITH NFPA 13. SPRINKLERS ARE INDICATED IN AREAS WITH FINISHED CEILINGS FOR COORDINATION PURPOSES. INSTALLING CONTRACTOR SHALL BE RESPONSIBLE FOR DETAILED DESIGN OF BRANCH PIPING AND UPRIGHT SPRINKLERS IN AREAS WITHOUT FINISHED CEILINGS. 2. REFER TO TYPICAL UNIT PLANS FOR SPRINKLER LAYOUTS ON RESIDENTIAL FLOORS.

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Structural Engineer

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11/18/2022

FIRE PROTECTION PLAN
- TOWER B - LVL 4



2. REFER TO TYPICAL UNIT PLANS FOR SPRINKLER LAYOUTS ON RESIDENTIAL FLOORS.

AREAS WITHOUT FINISHED CEILINGS.

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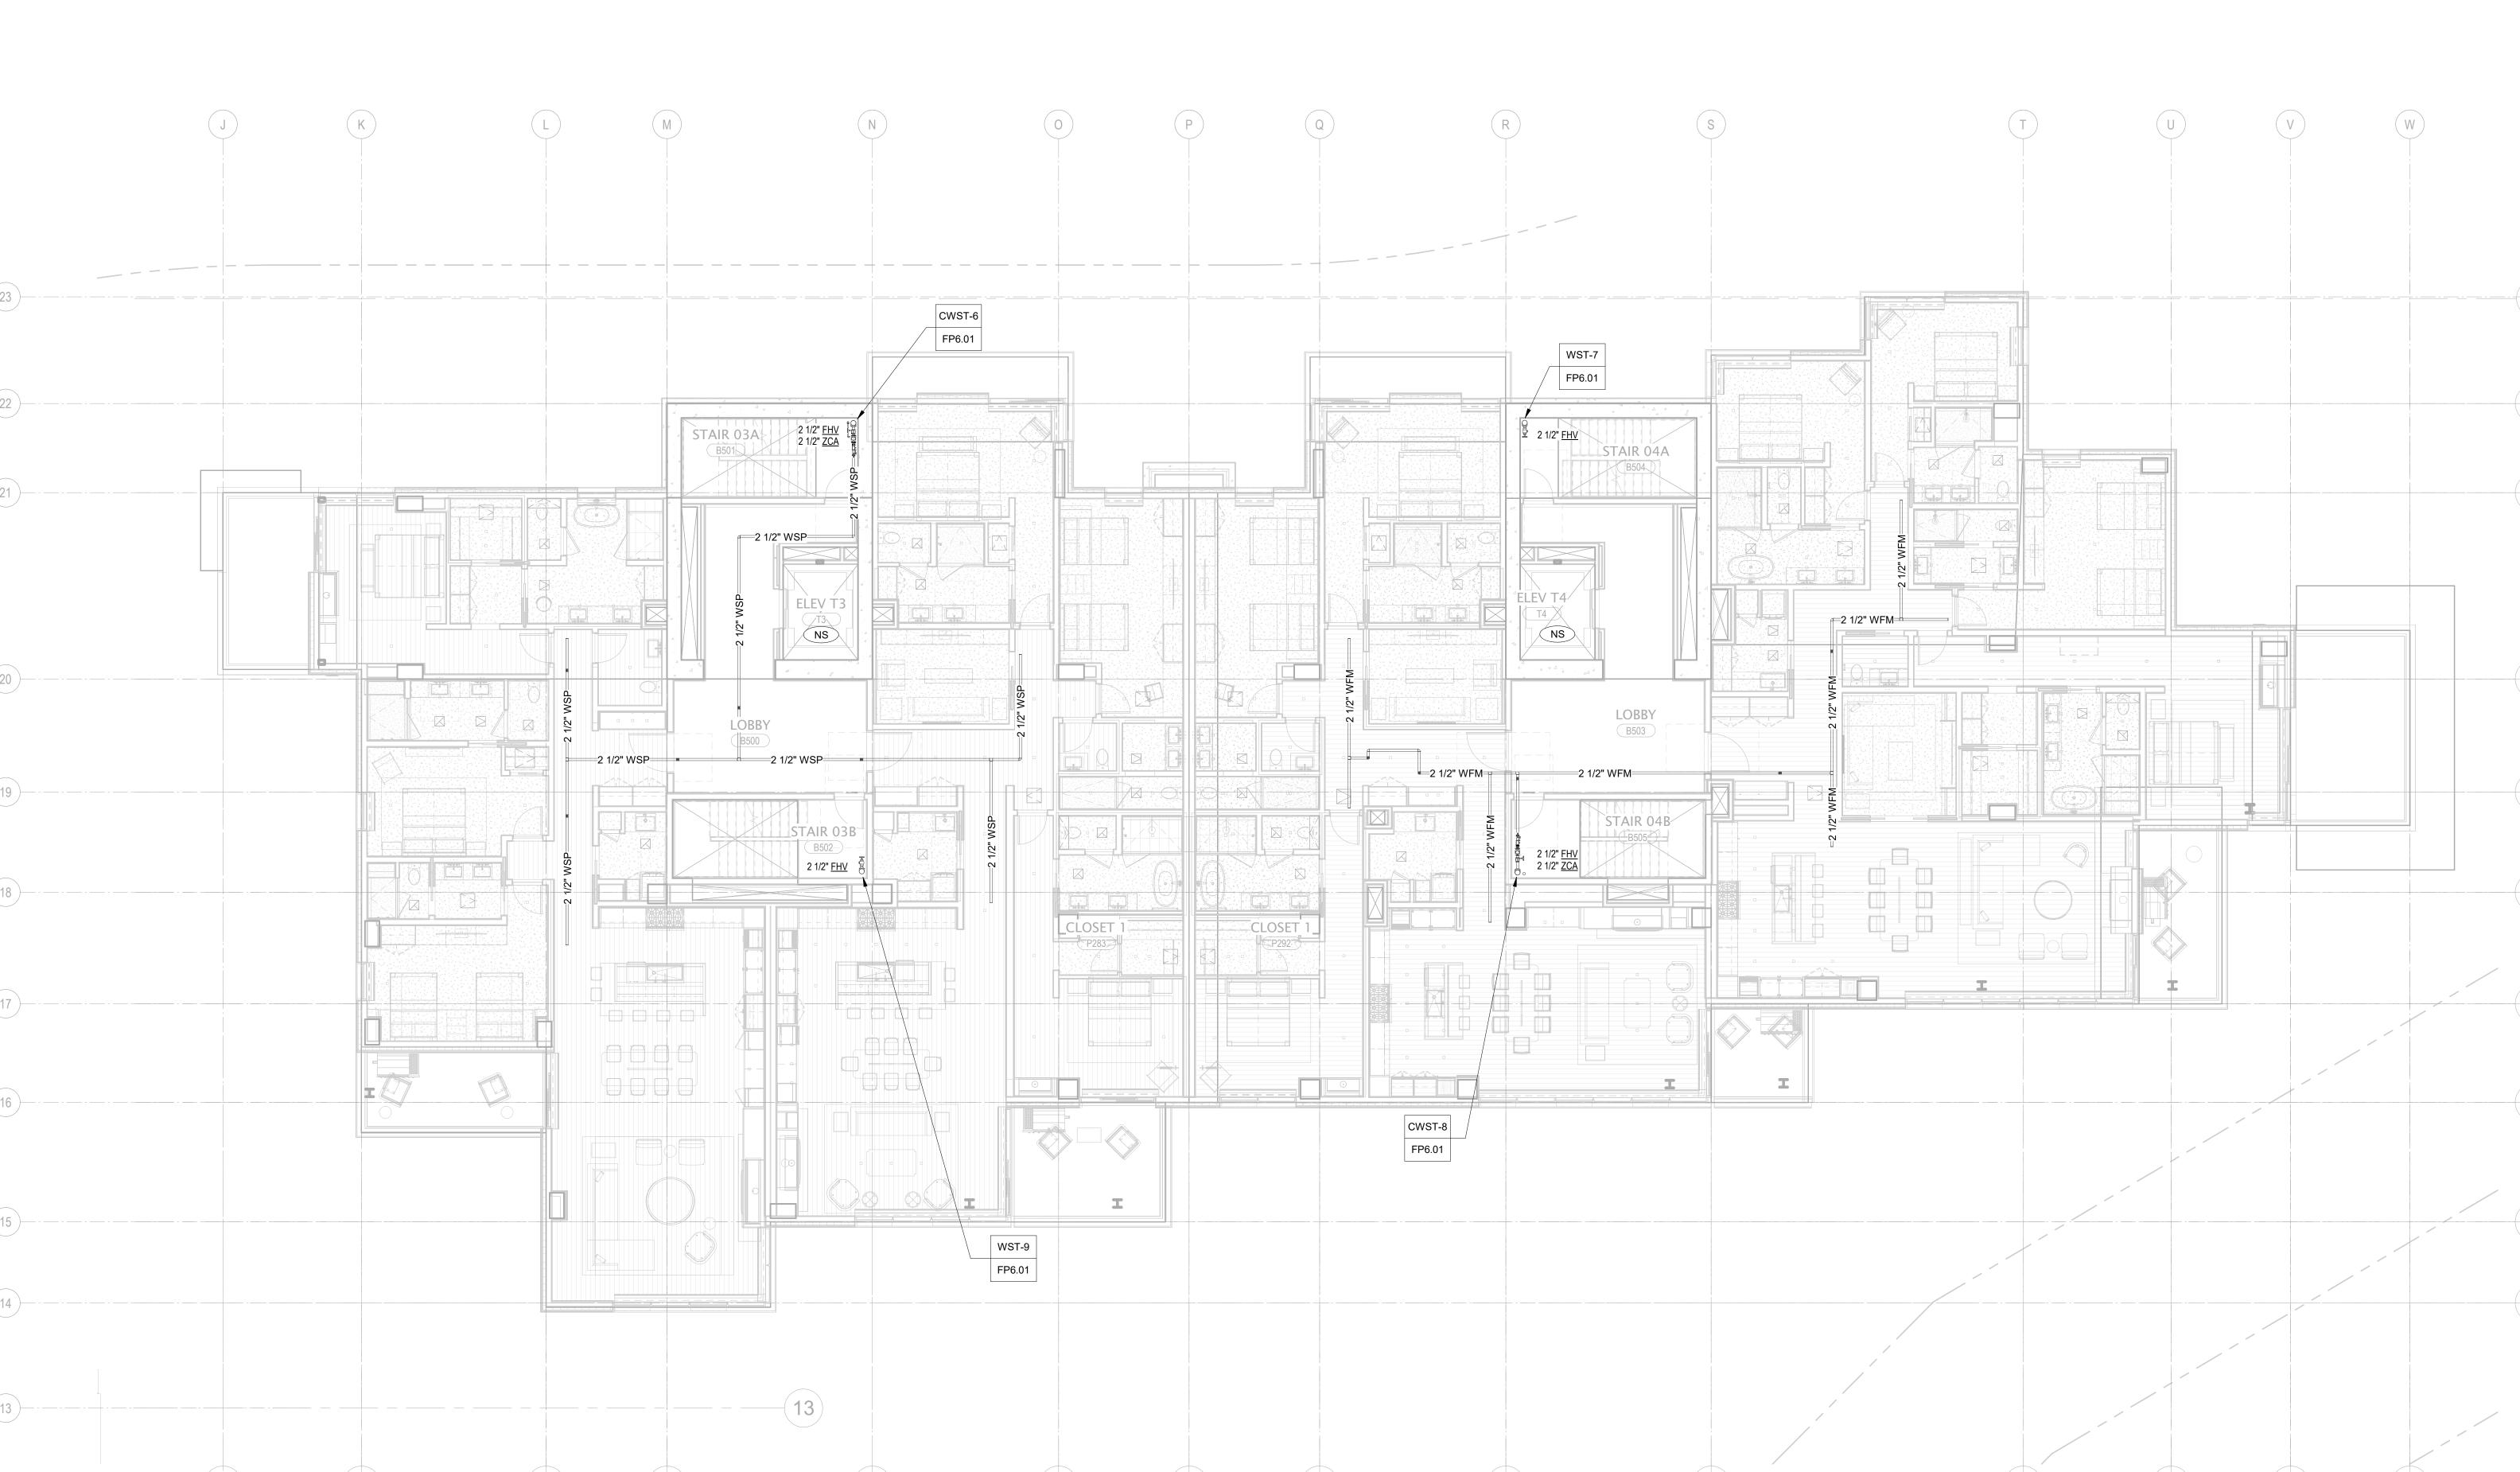
principal architect
project manager__JCC
drawn by__CRB, SMK

checked by__Checker
job no. 20052
date 11/18/2022
revisions:

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FIRE PROTECTION PLAN - TOWER B - LVL 5


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1 TOWER B - LEVEL 5 - FP

AREAS WITHOUT FINISHED CEILINGS.

2. REFER TO TYPICAL UNIT PLANS FOR SPRINKLER LAYOUTS ON RESIDENTIAL FLOORS.



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principal architect
project manager__JCC_
drawn by__CRB,SMK____
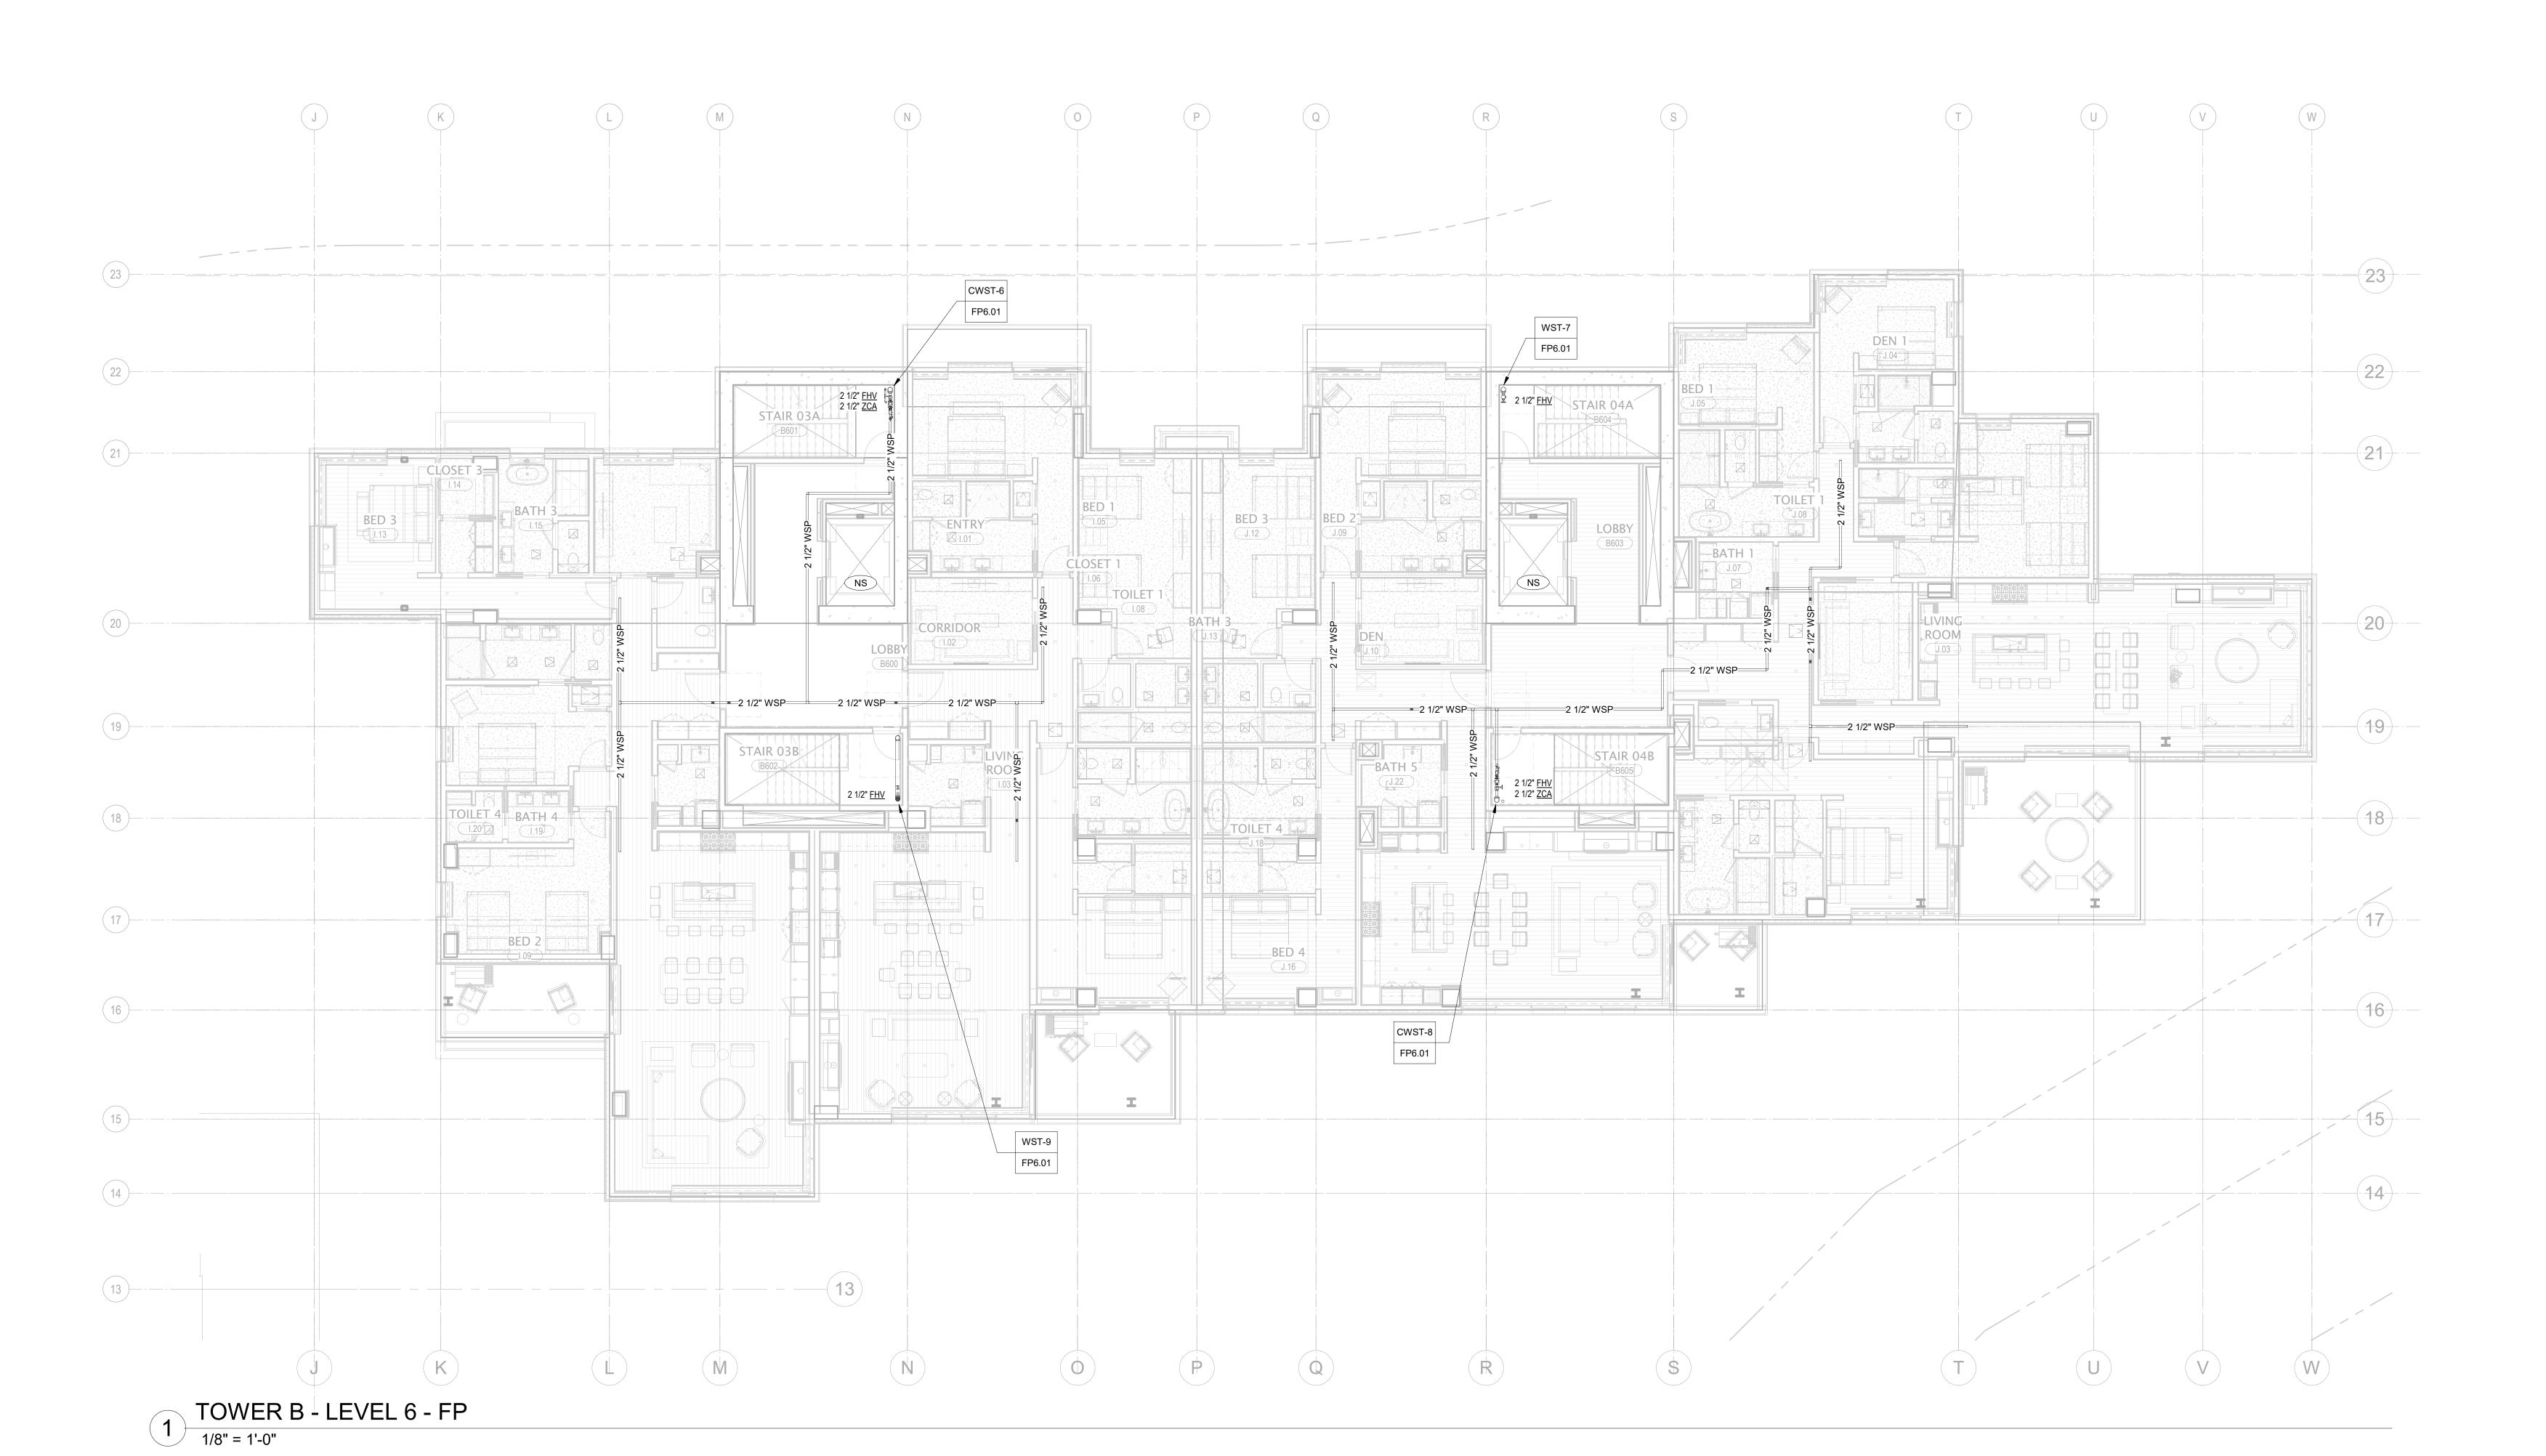
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date 11/18/2022

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FIRE PROTECTION PLAN - TOWER B - LVL 6

ACCORDANCE WITH NFPA 13. SPRINKLERS ARE INDICATED IN AREAS WITH FINISHED CEILINGS FOR COORDINATION PURPOSES. INSTALLING CONTRACTOR SHALL BE RESPONSIBLE FOR DETAILED DESIGN OF BRANCH PIPING AND UPRIGHT SPRINKLERS IN AREAS WITHOUT FINISHED CEILINGS.

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1. SCOPE OF WORK INCLUDES SPRINKLER PROTECTION THROUGHOUT ALL AREAS IN

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principal architect_____

project manager__JCC____

drawn by__CRB, SMK____

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Seattle, WA 98154


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WSP USA

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revisions:

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FIRE PROTECTION PLAN
- TOWER B - LVL 7



GENERAL NOTES:
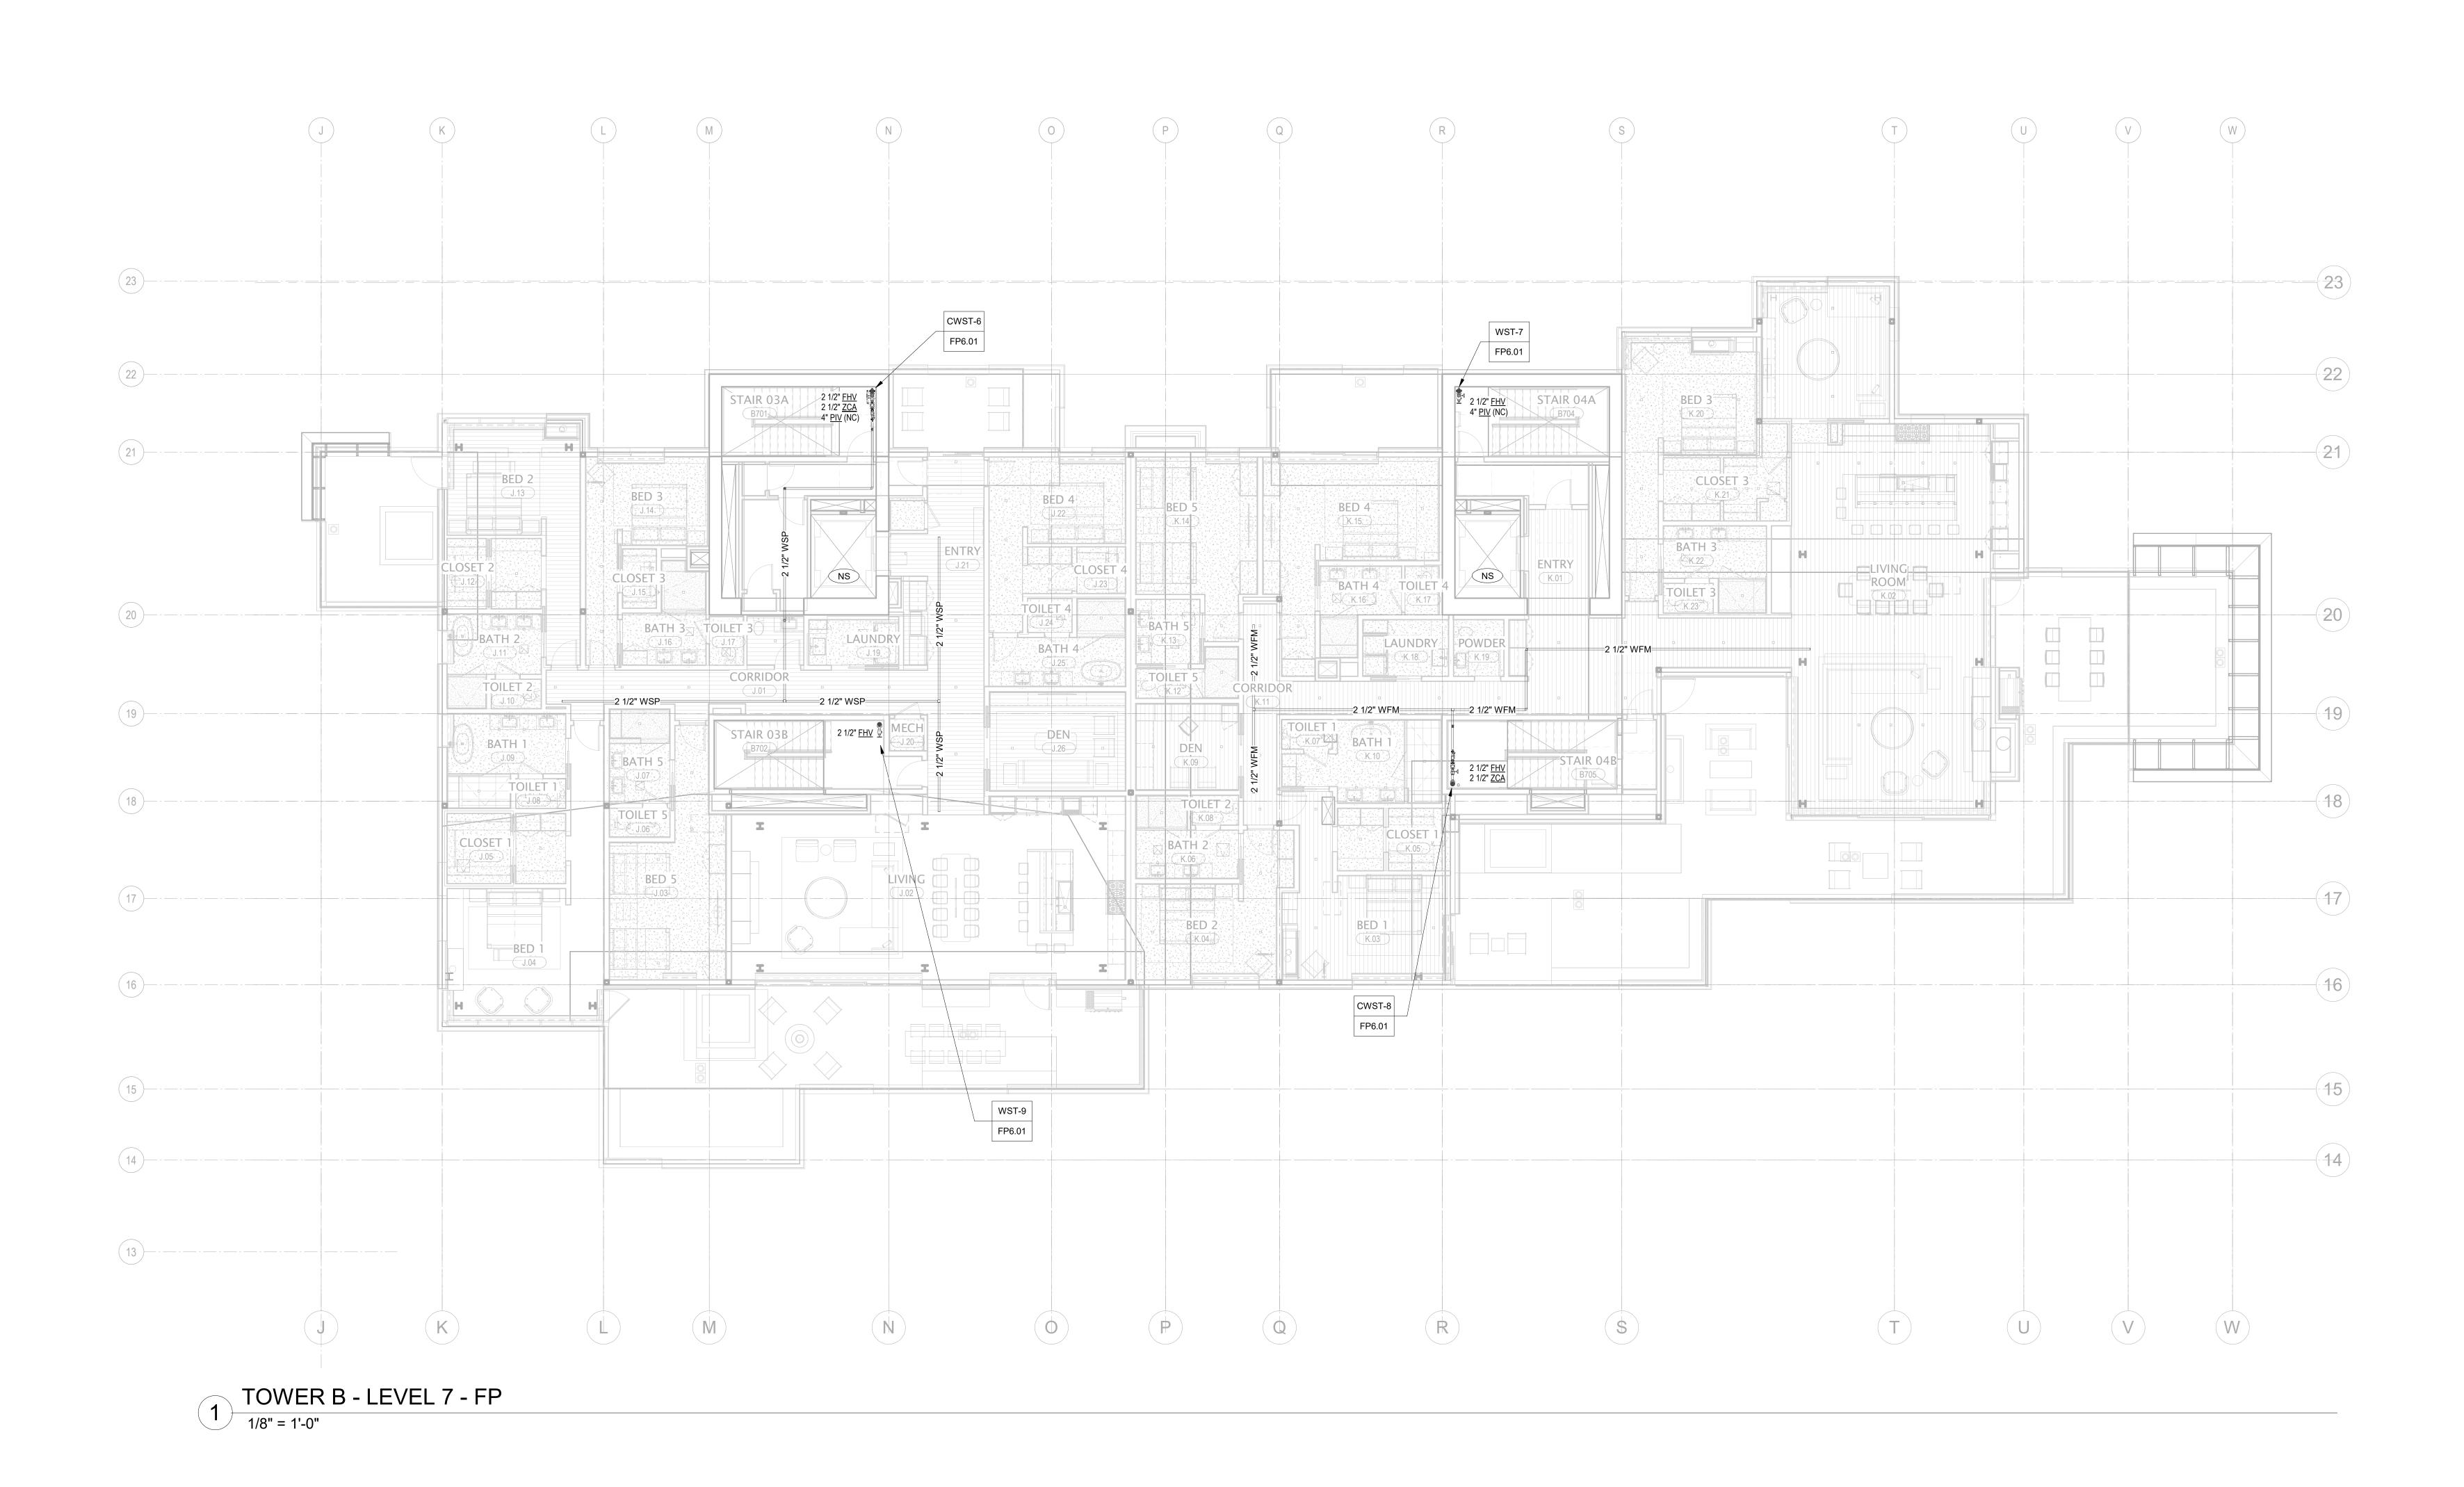
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> project manager__JCC drawn by__CRB, SMK____ ____ checked by Checker

principal architect_____


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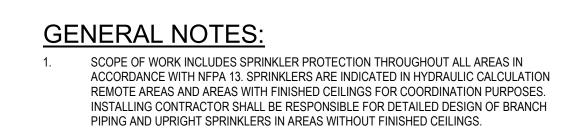
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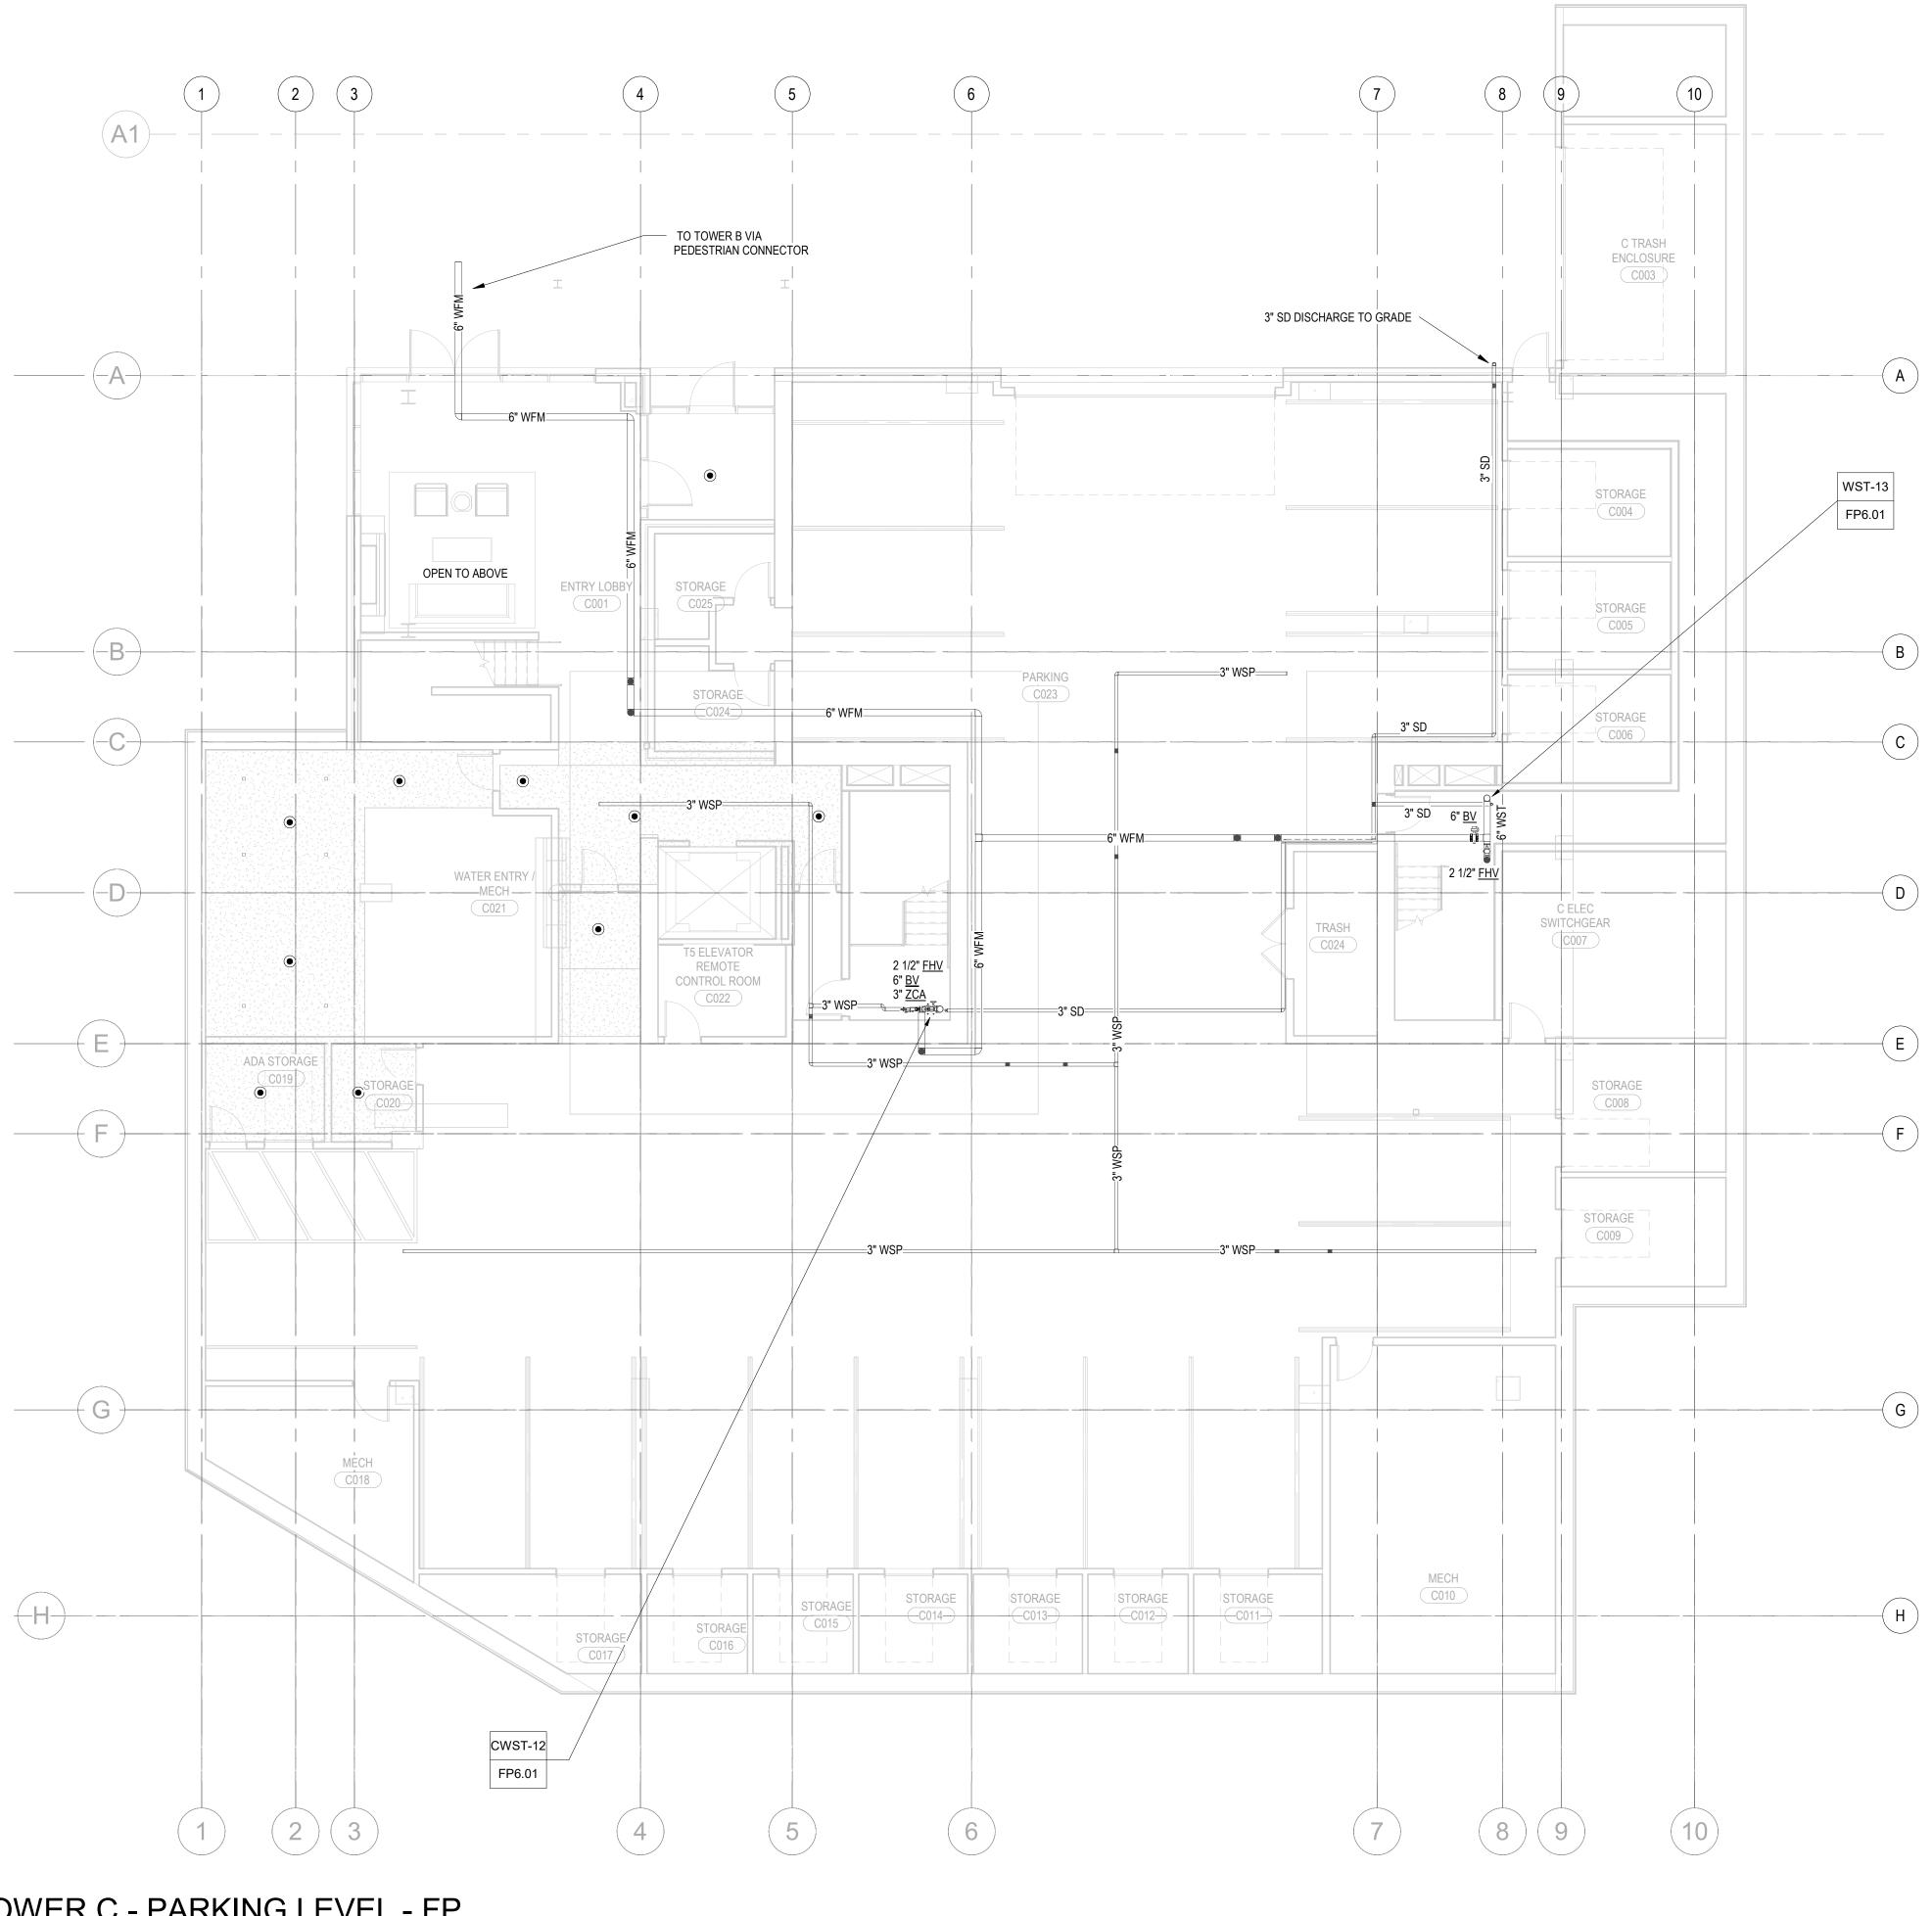
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FIRE PROTECTION PLAN
- TOWER B - ROOF








TOWER C - PARKING LEVEL - FP

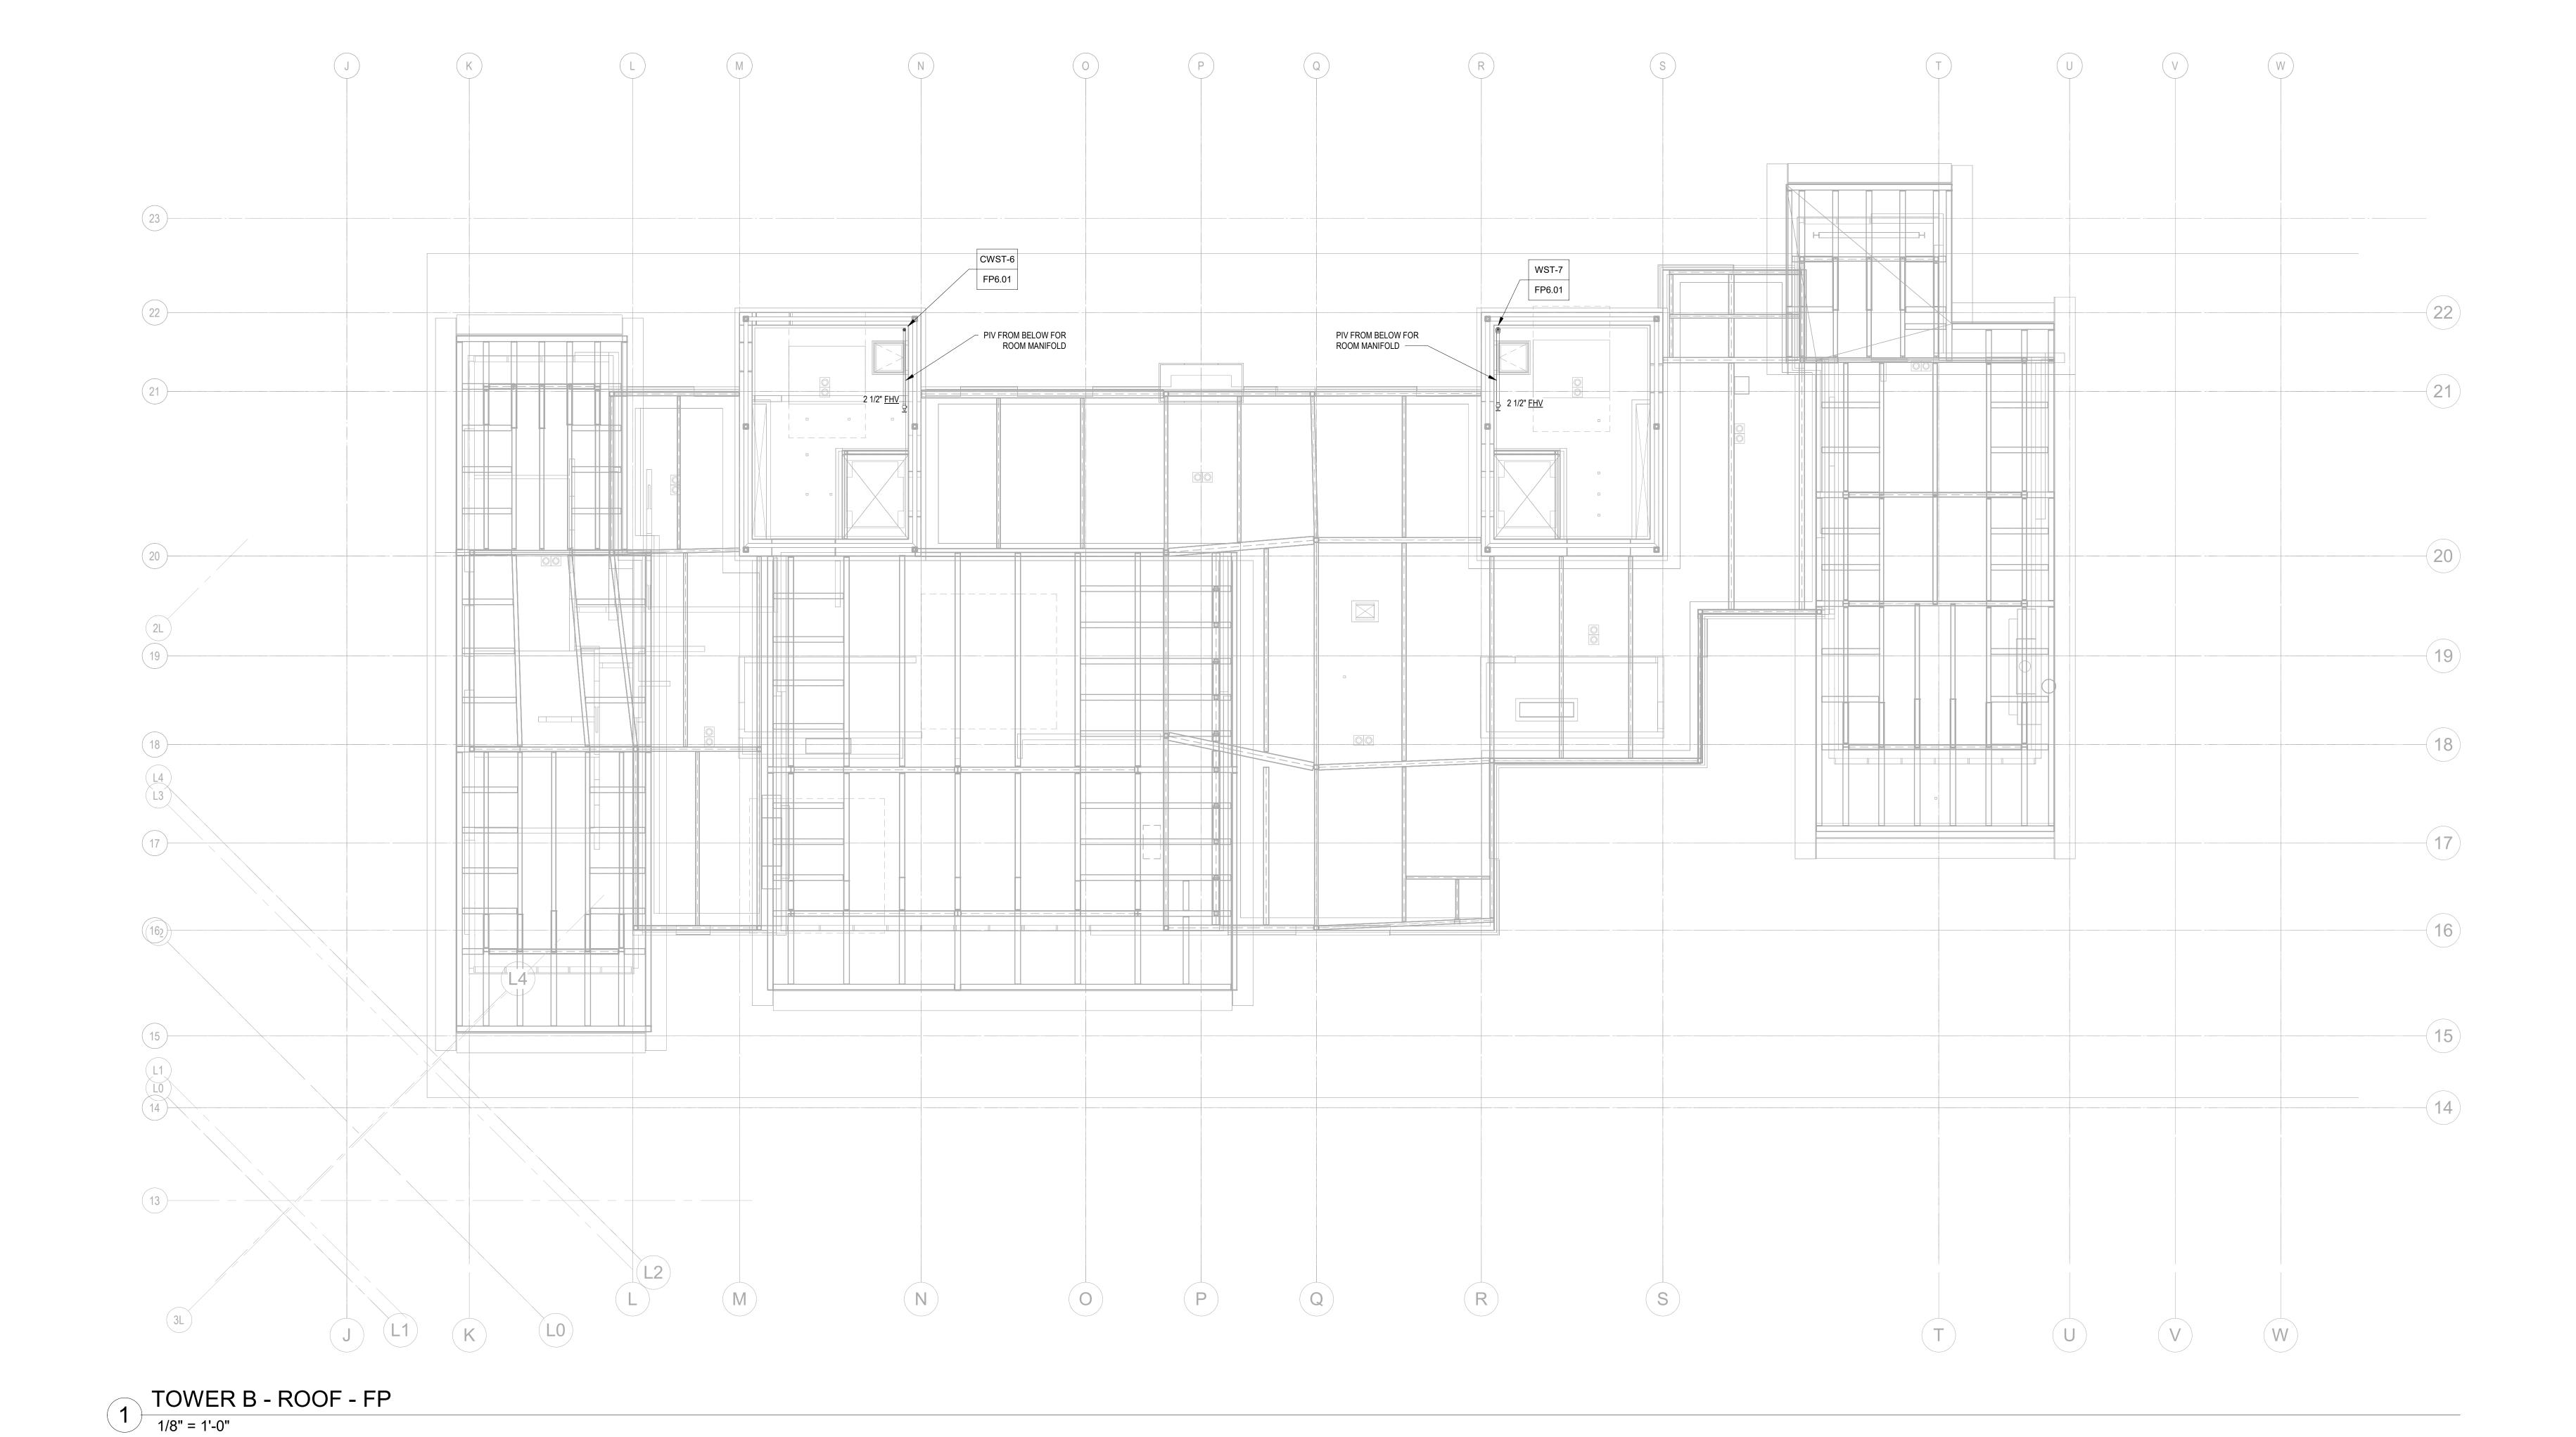1/8" = 1'-0"

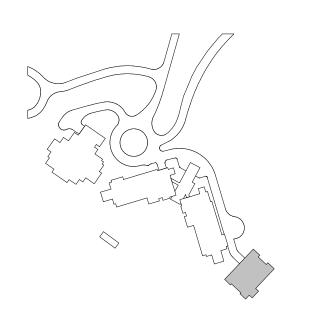

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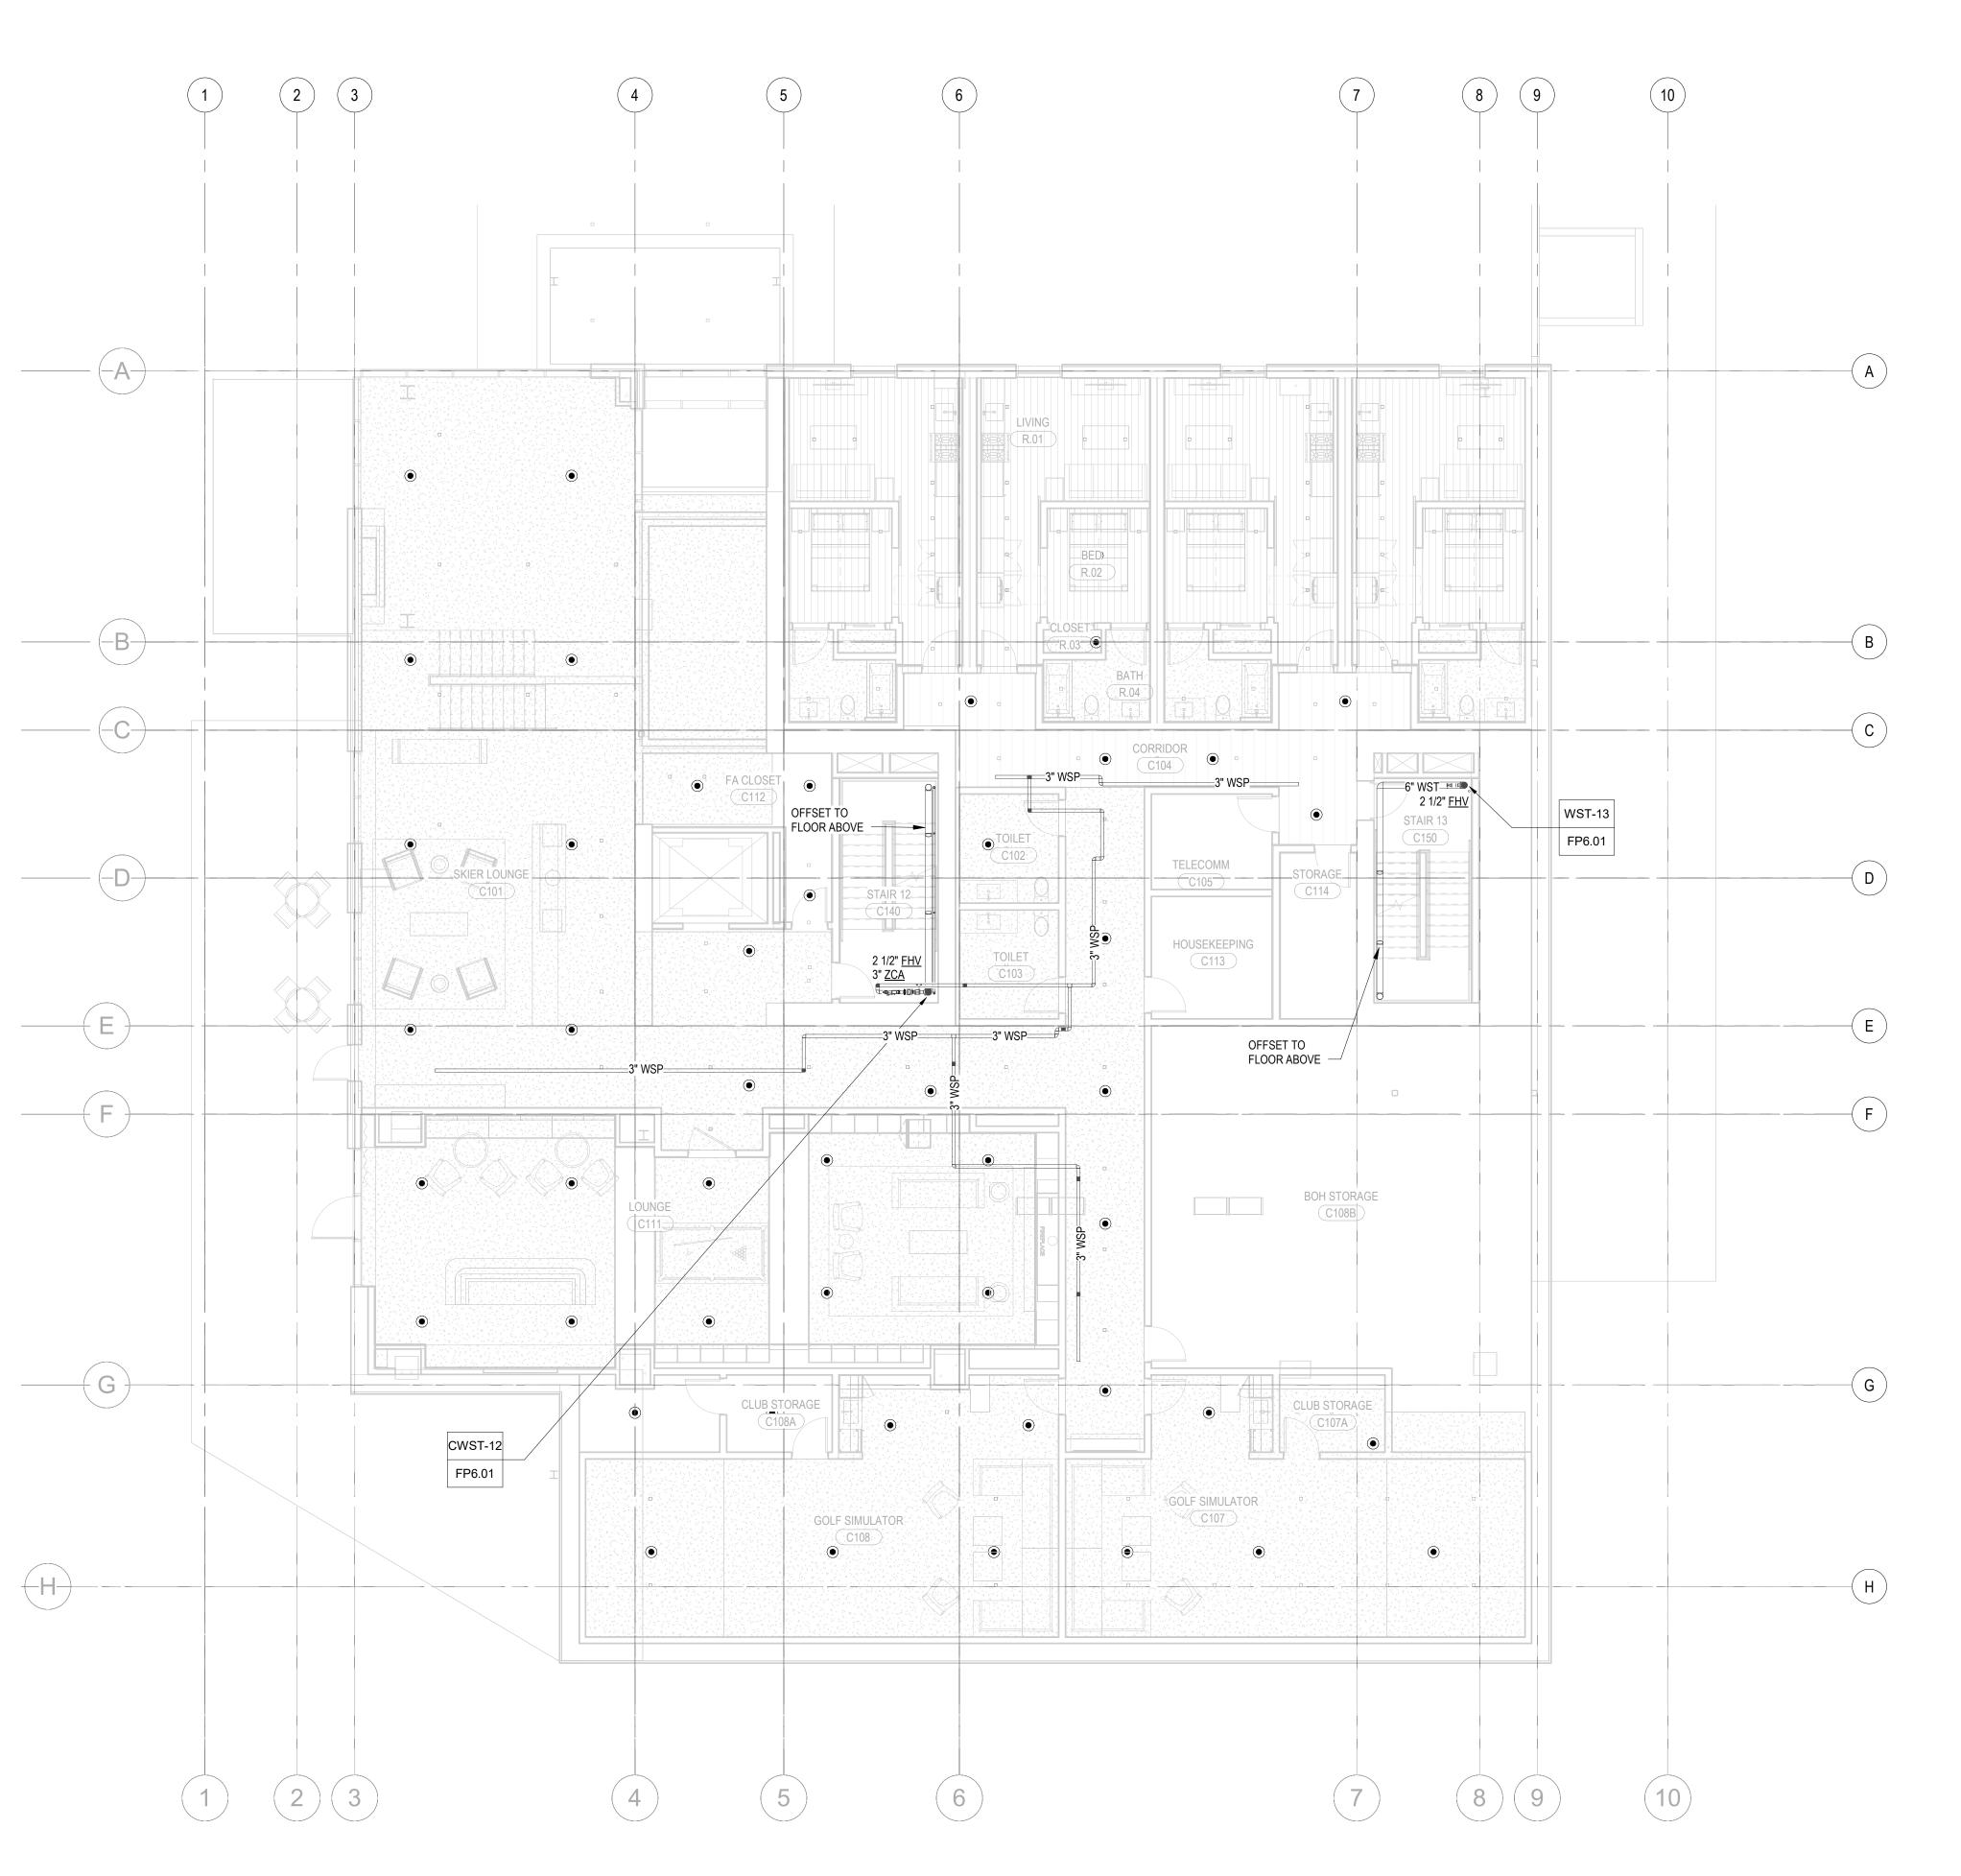
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FIRE PROTECTION PLAN
- TOWER C - PARKING
LEVEL

FP2.2C.01



1 TOWER C - LEVEL 1 - FP
1/8" = 1'-0"

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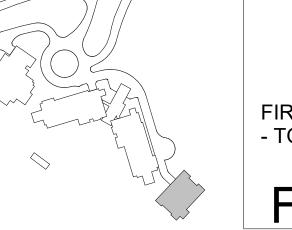
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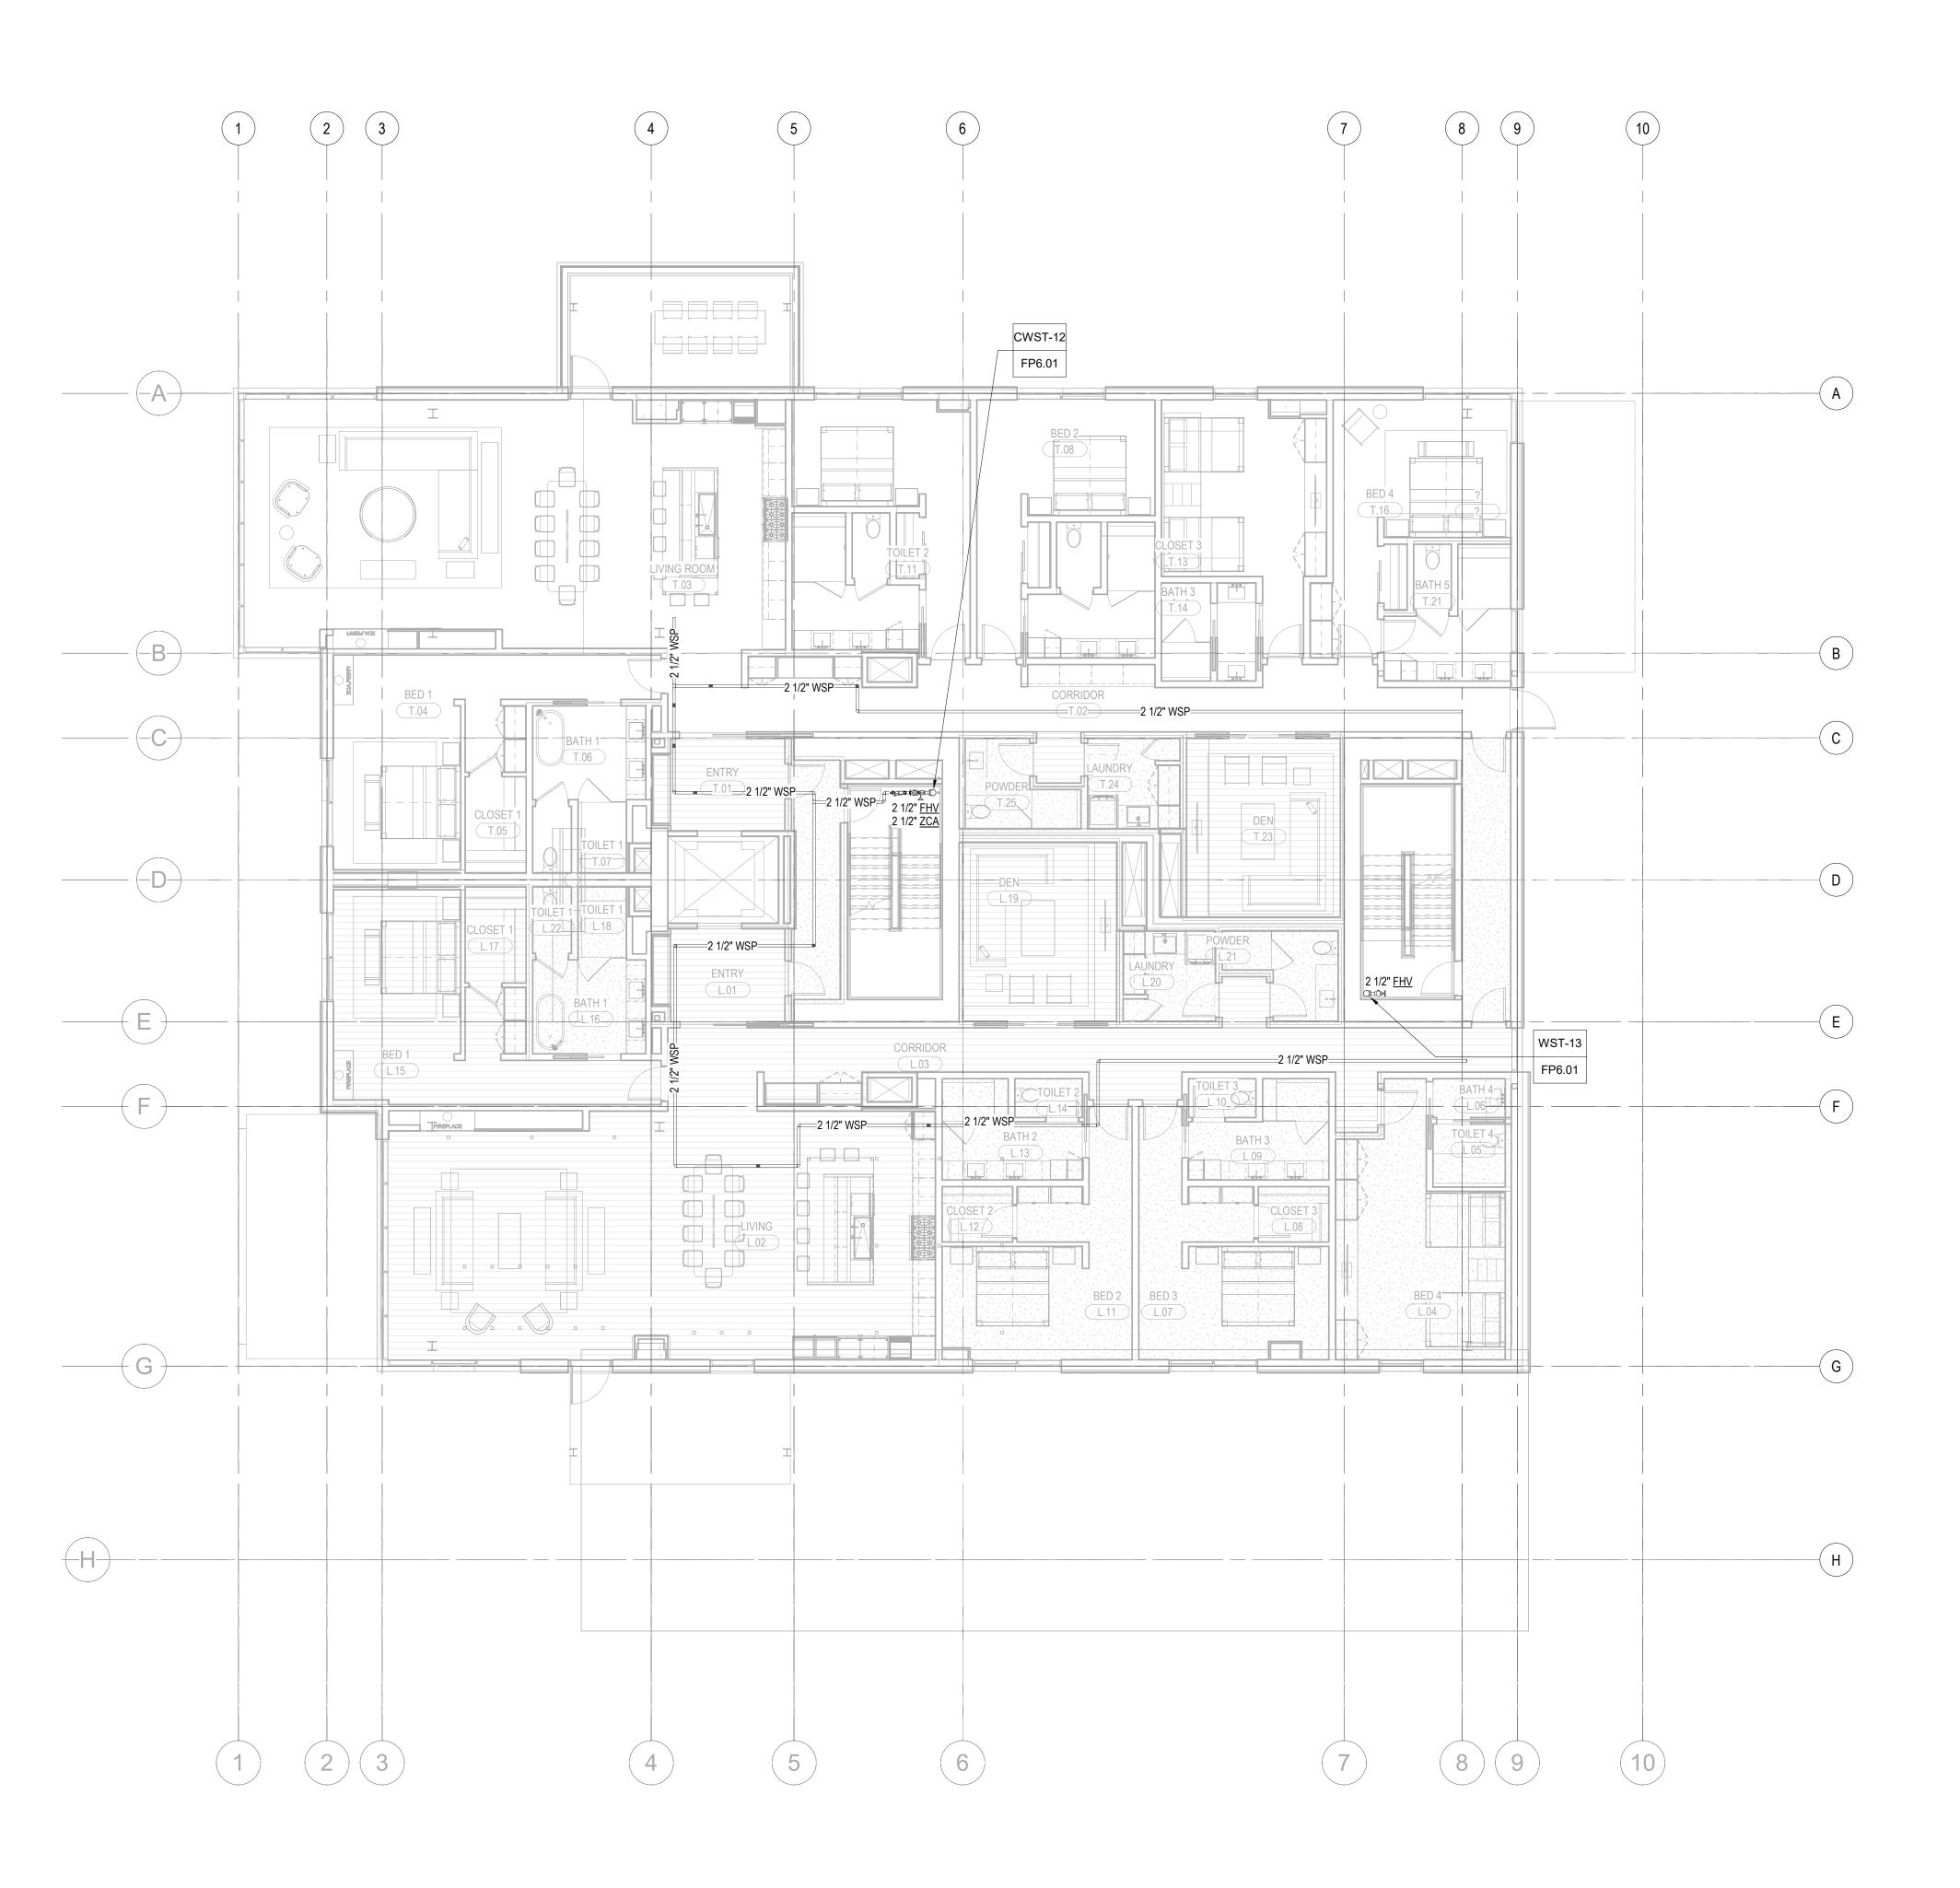
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no. date

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FIRE PROTECTION PLAN
- TOWER C - LEVEL 1 FP2.2C.11





1 TOWER C - LEVEL 2 - FP
1/8" = 1'-0"

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____ principal architect__TK_____ project manager<u>JCC</u> drawn by__CRB, SMK____ ____


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FIRE PROTECTION PLAN
- TOWER C - LEVEL 2





1 TOWER C - LEVEL 3 - FP
1/8" = 1'-0"

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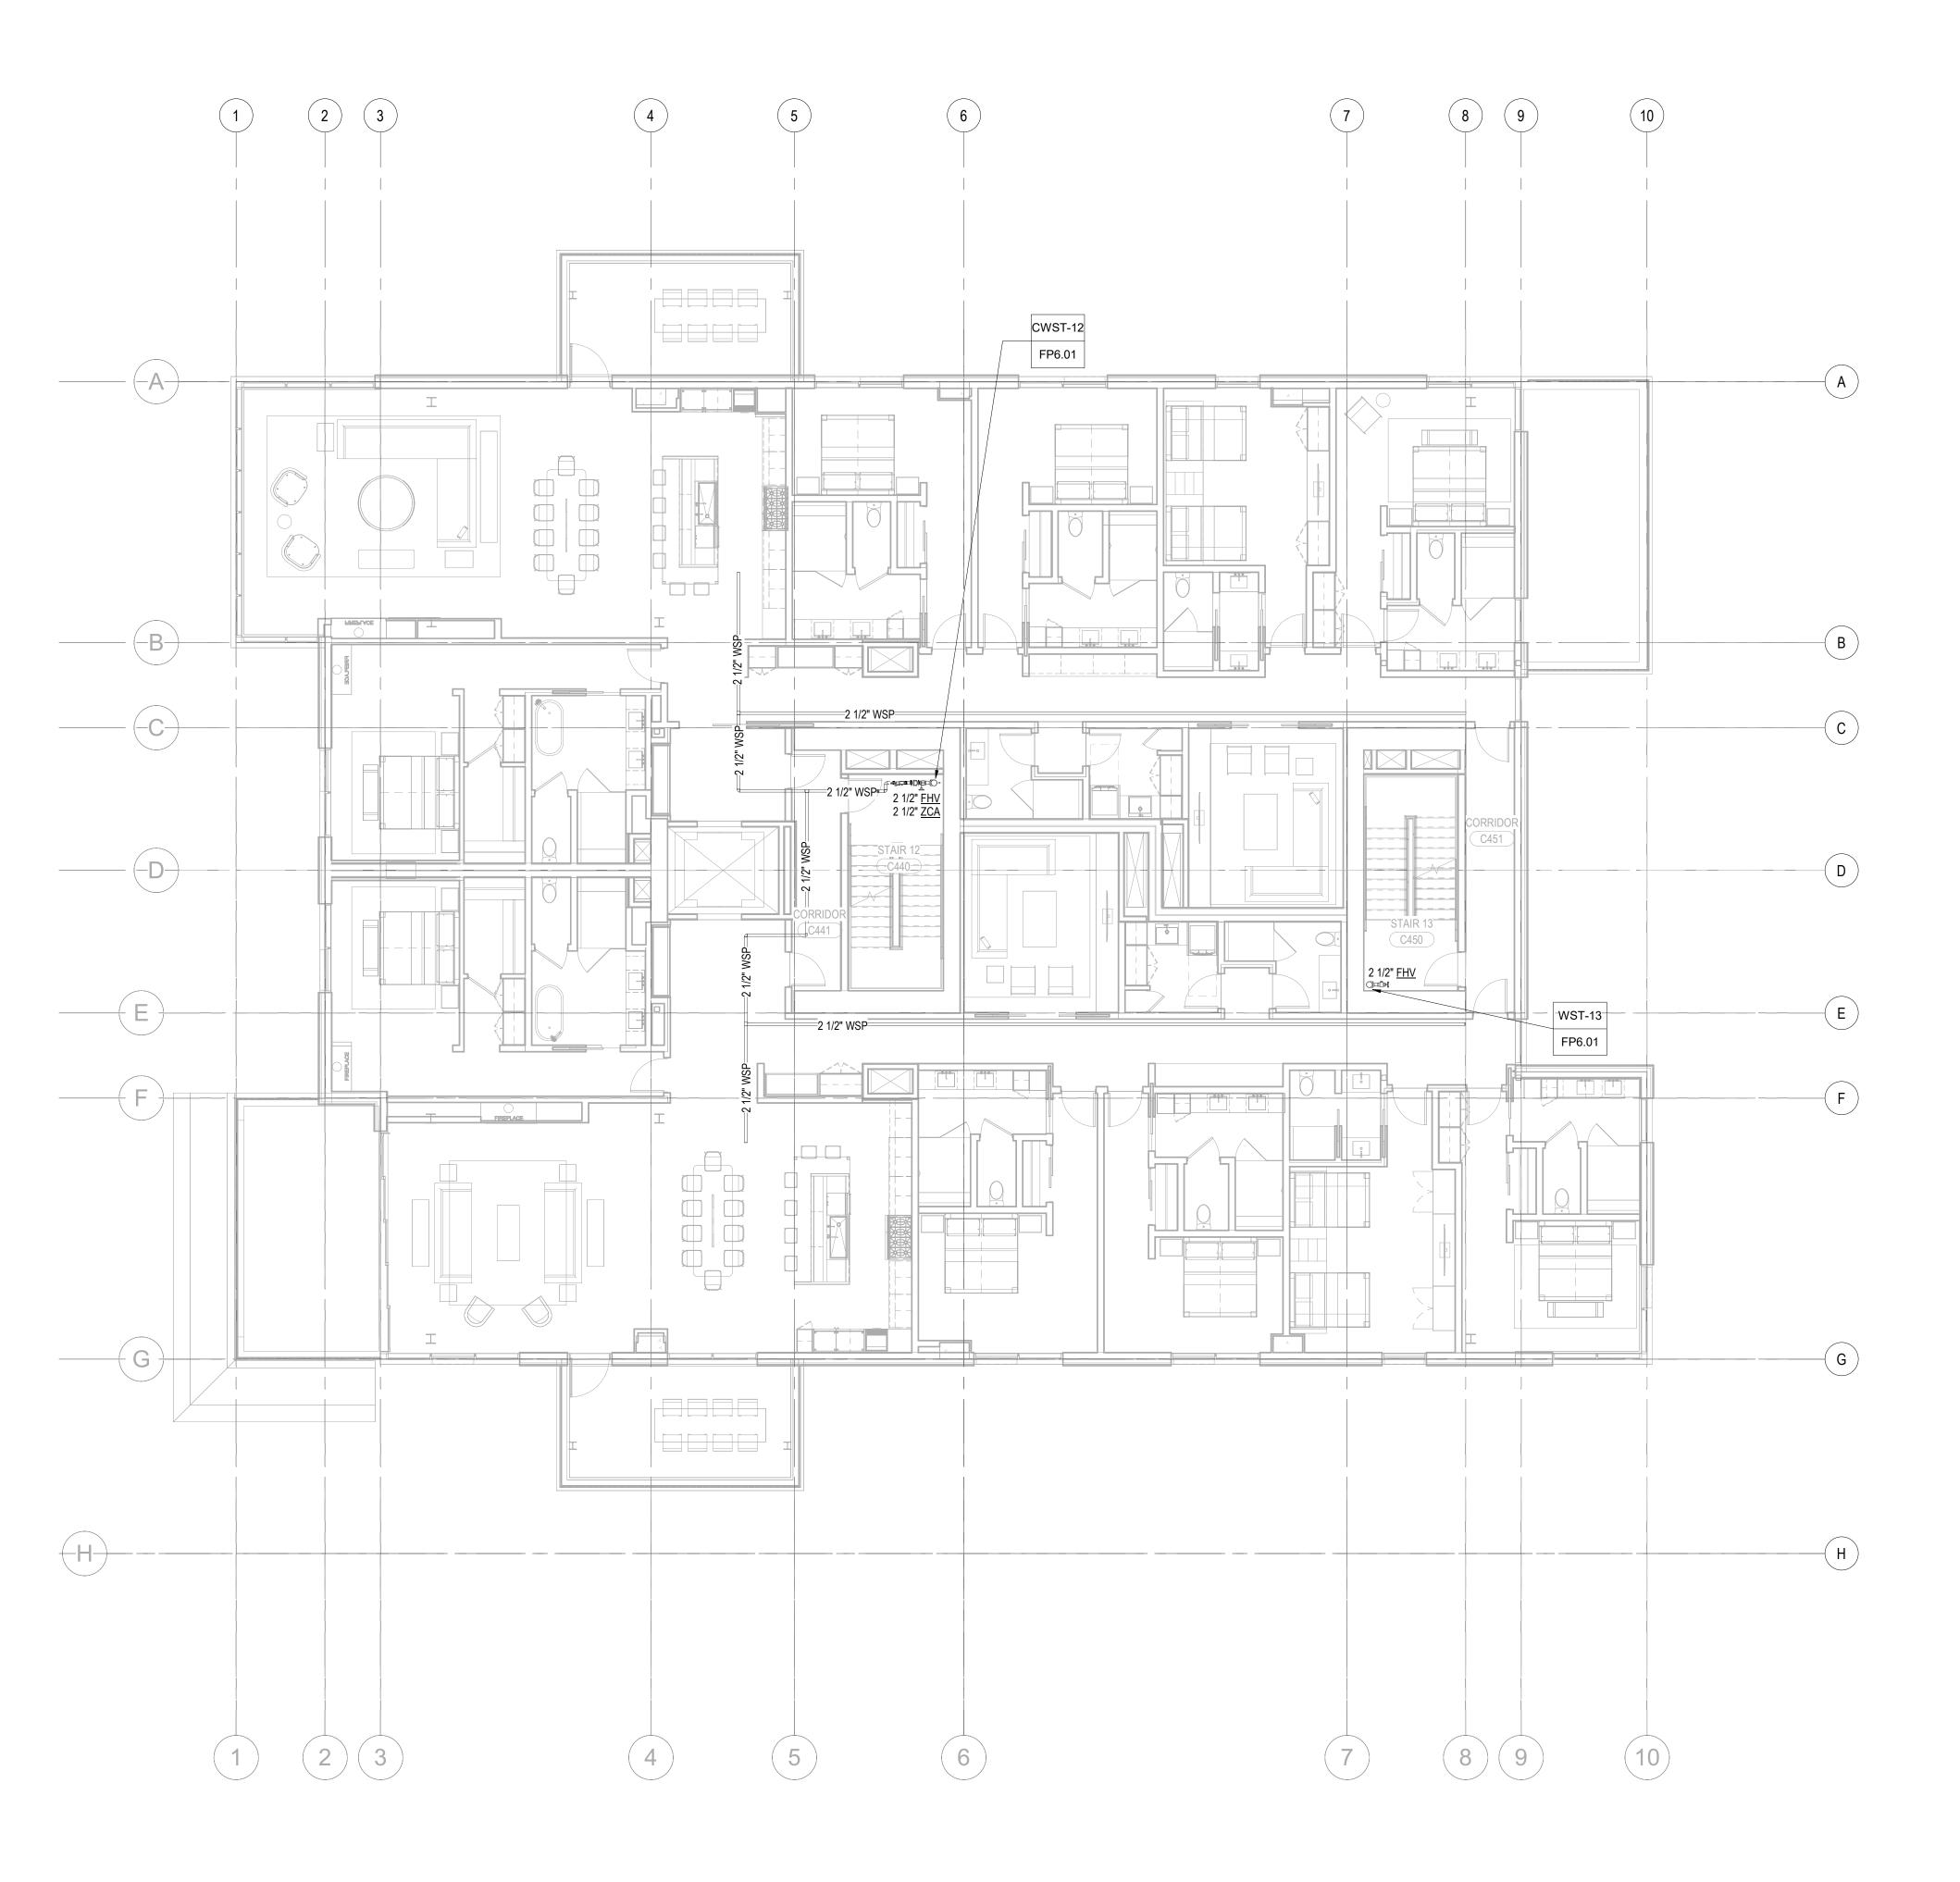
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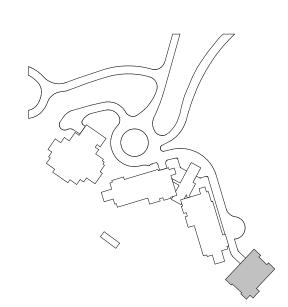
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FIRE PROTECTION PLAN
- TOWER C - LEVEL 3 FP2.2C.13

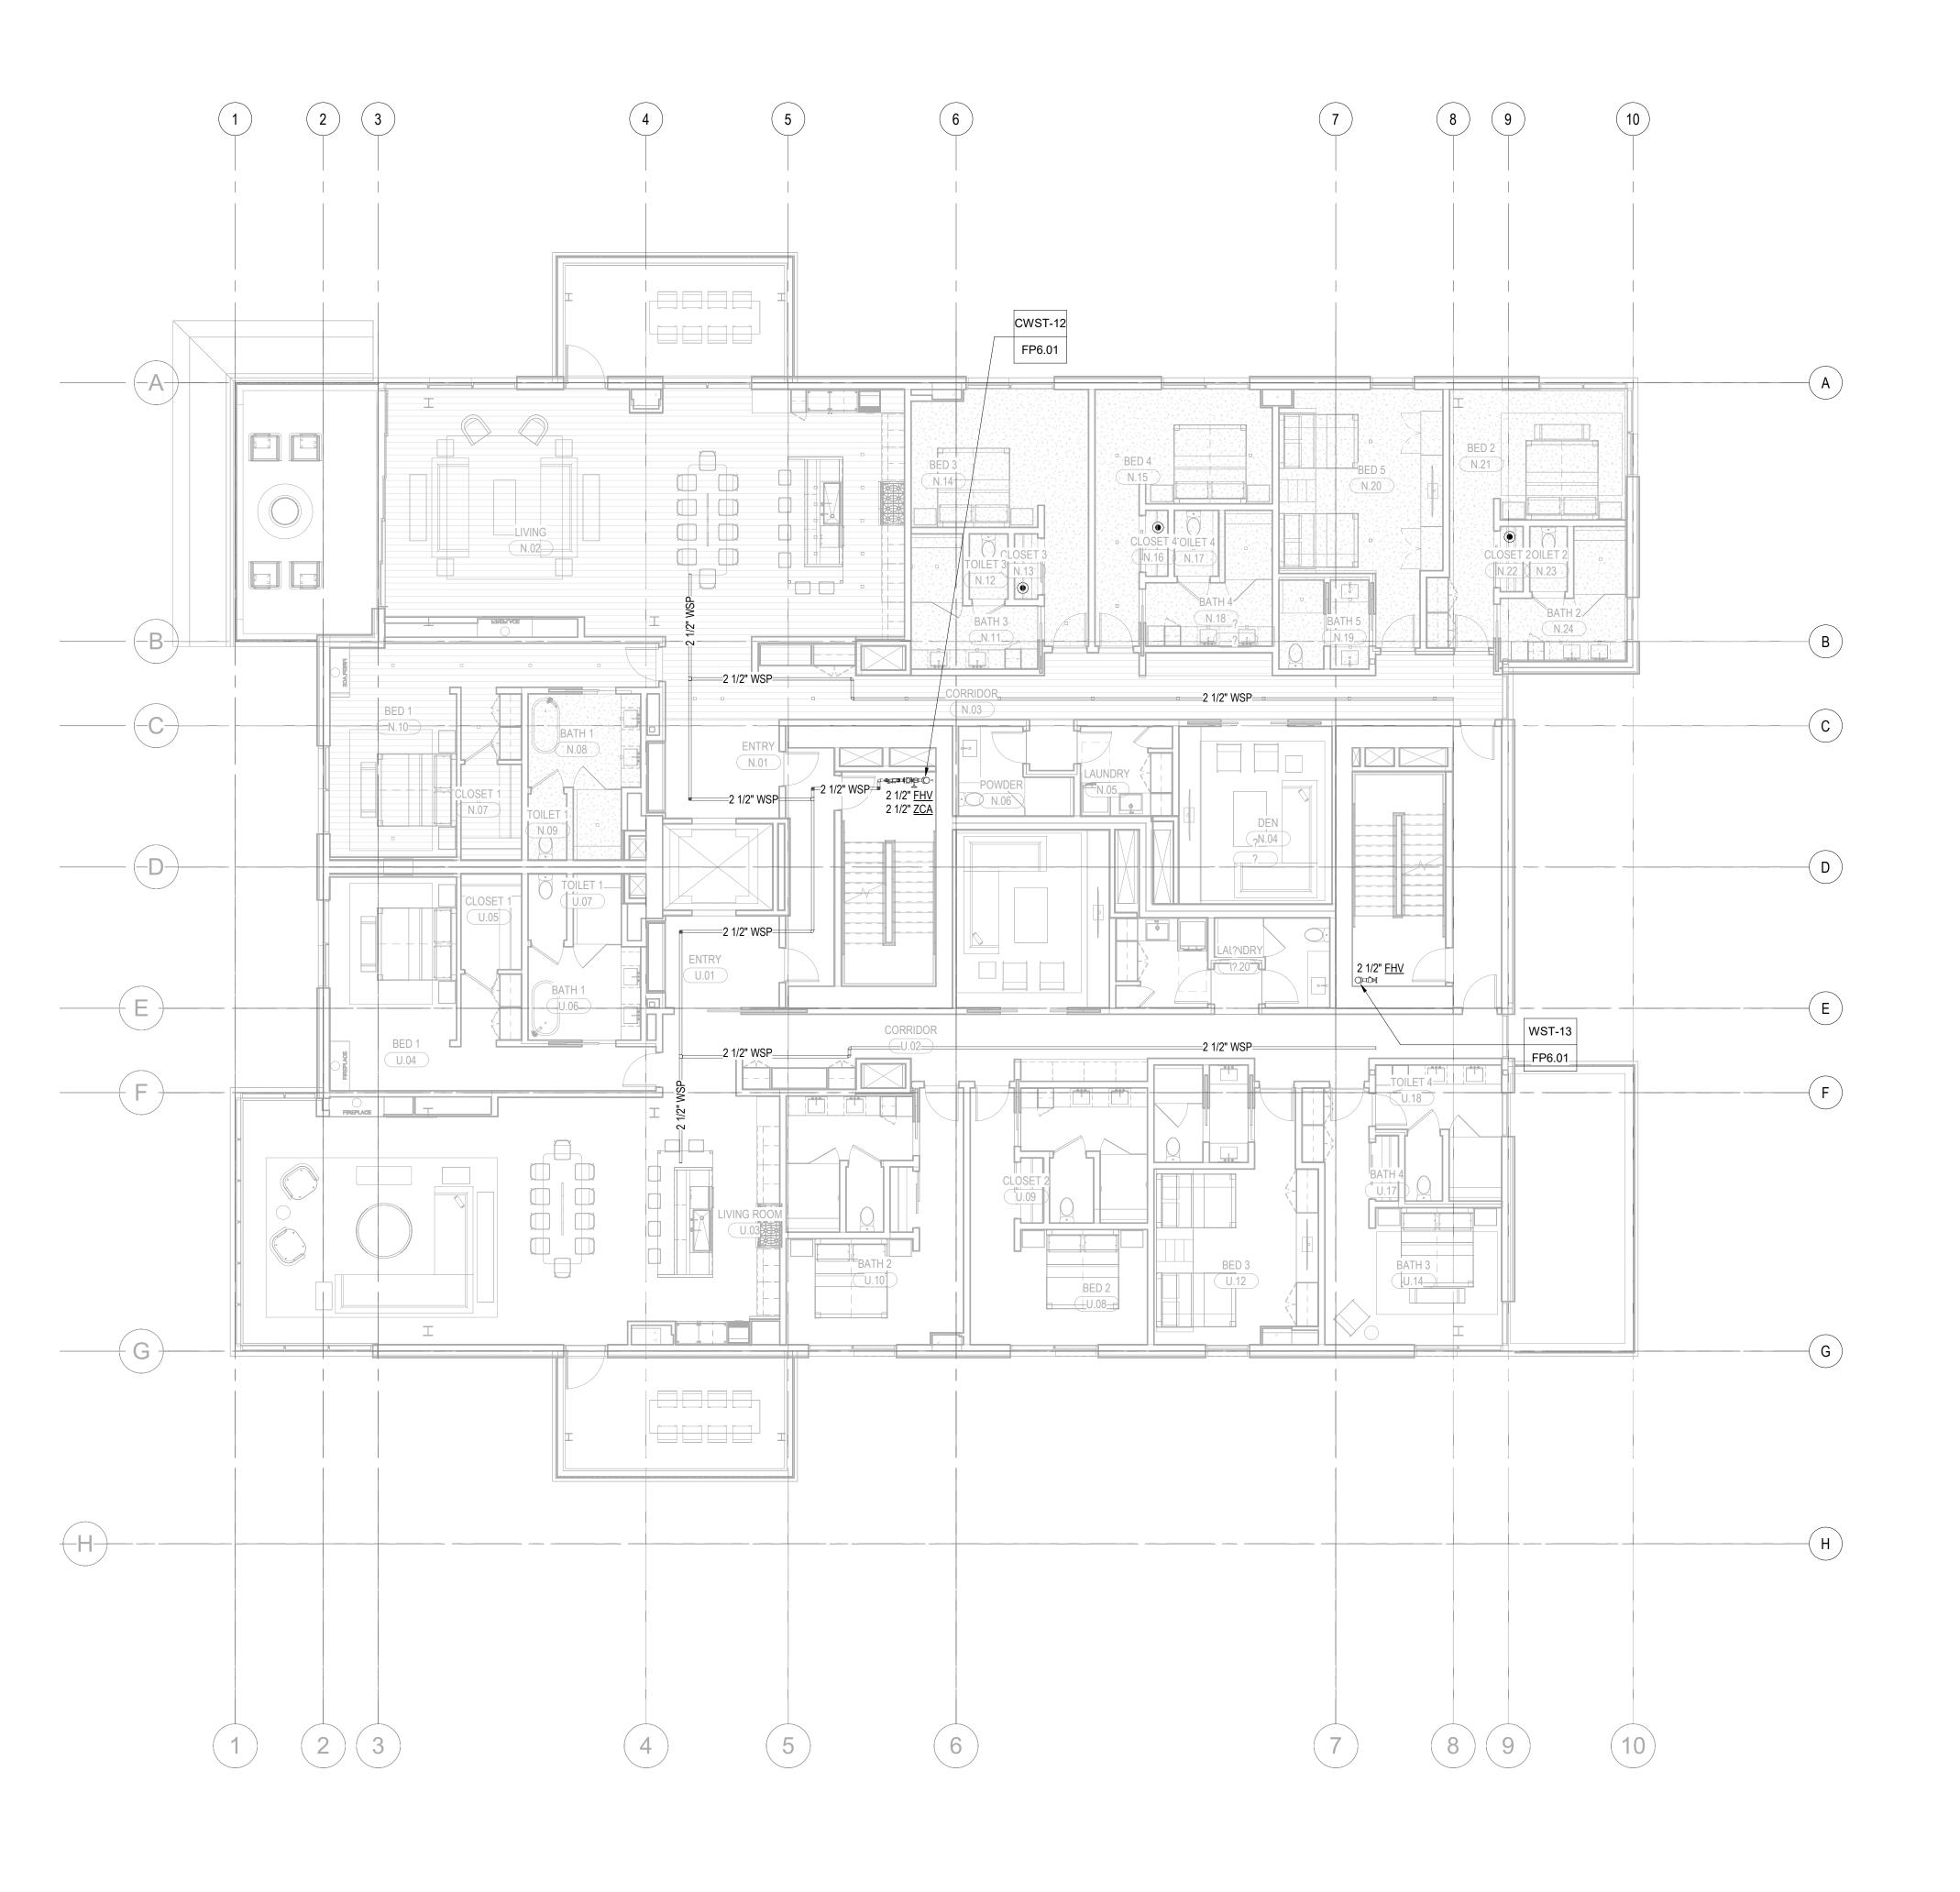

1 TOWER C - LEVEL 4 - FP
1/8" = 1'-0"



159 South Jackson Seattle, Washingto

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project:

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principal architect__TK____ project manager__JCC____ drawn by__CRB, SMK____

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job no. 20052
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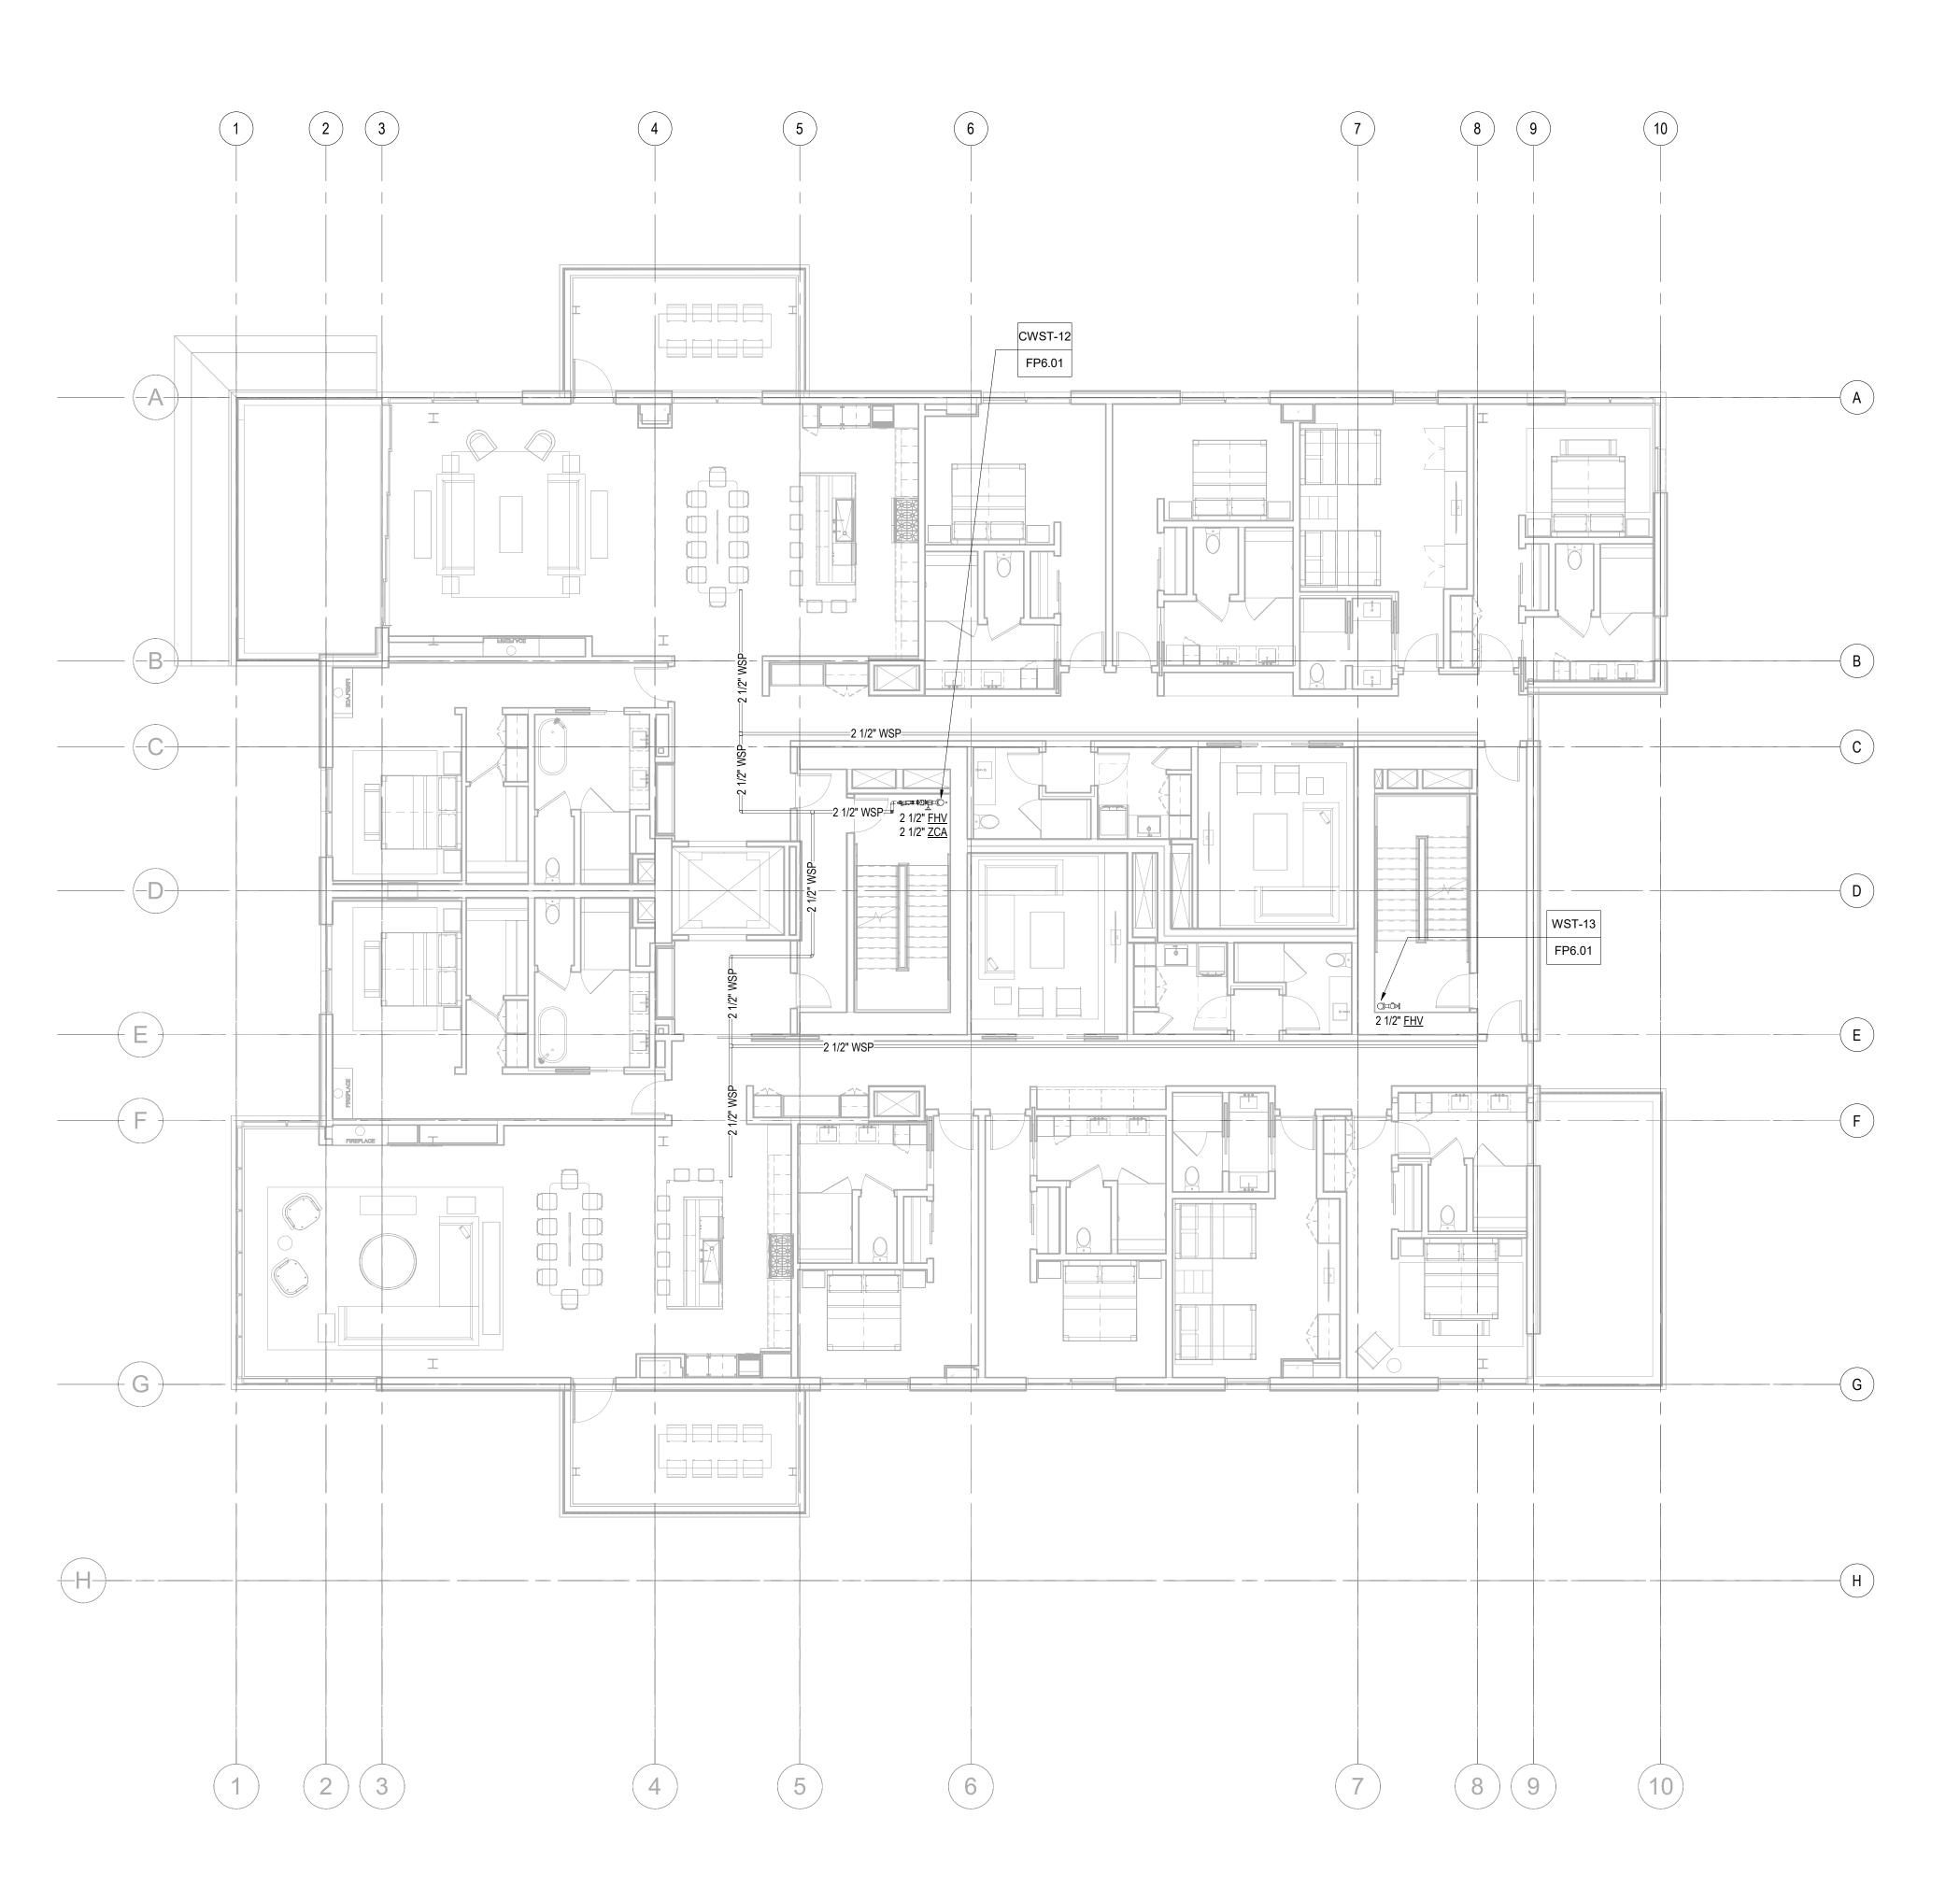
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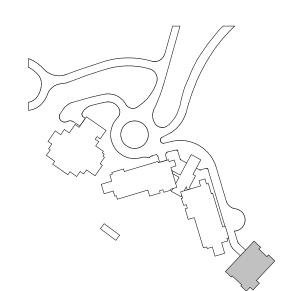
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FIRE PROTECTION PLAN - TOWER C - LEVEL 4

FP2.2C.14



1 TOWER C - LEVEL 5 - FP
1/8" = 1'-0"



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+1 206 624 5670 olsonk

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principal architect__TK____ project manager__JCC____ drawn by__CRB, SMK____

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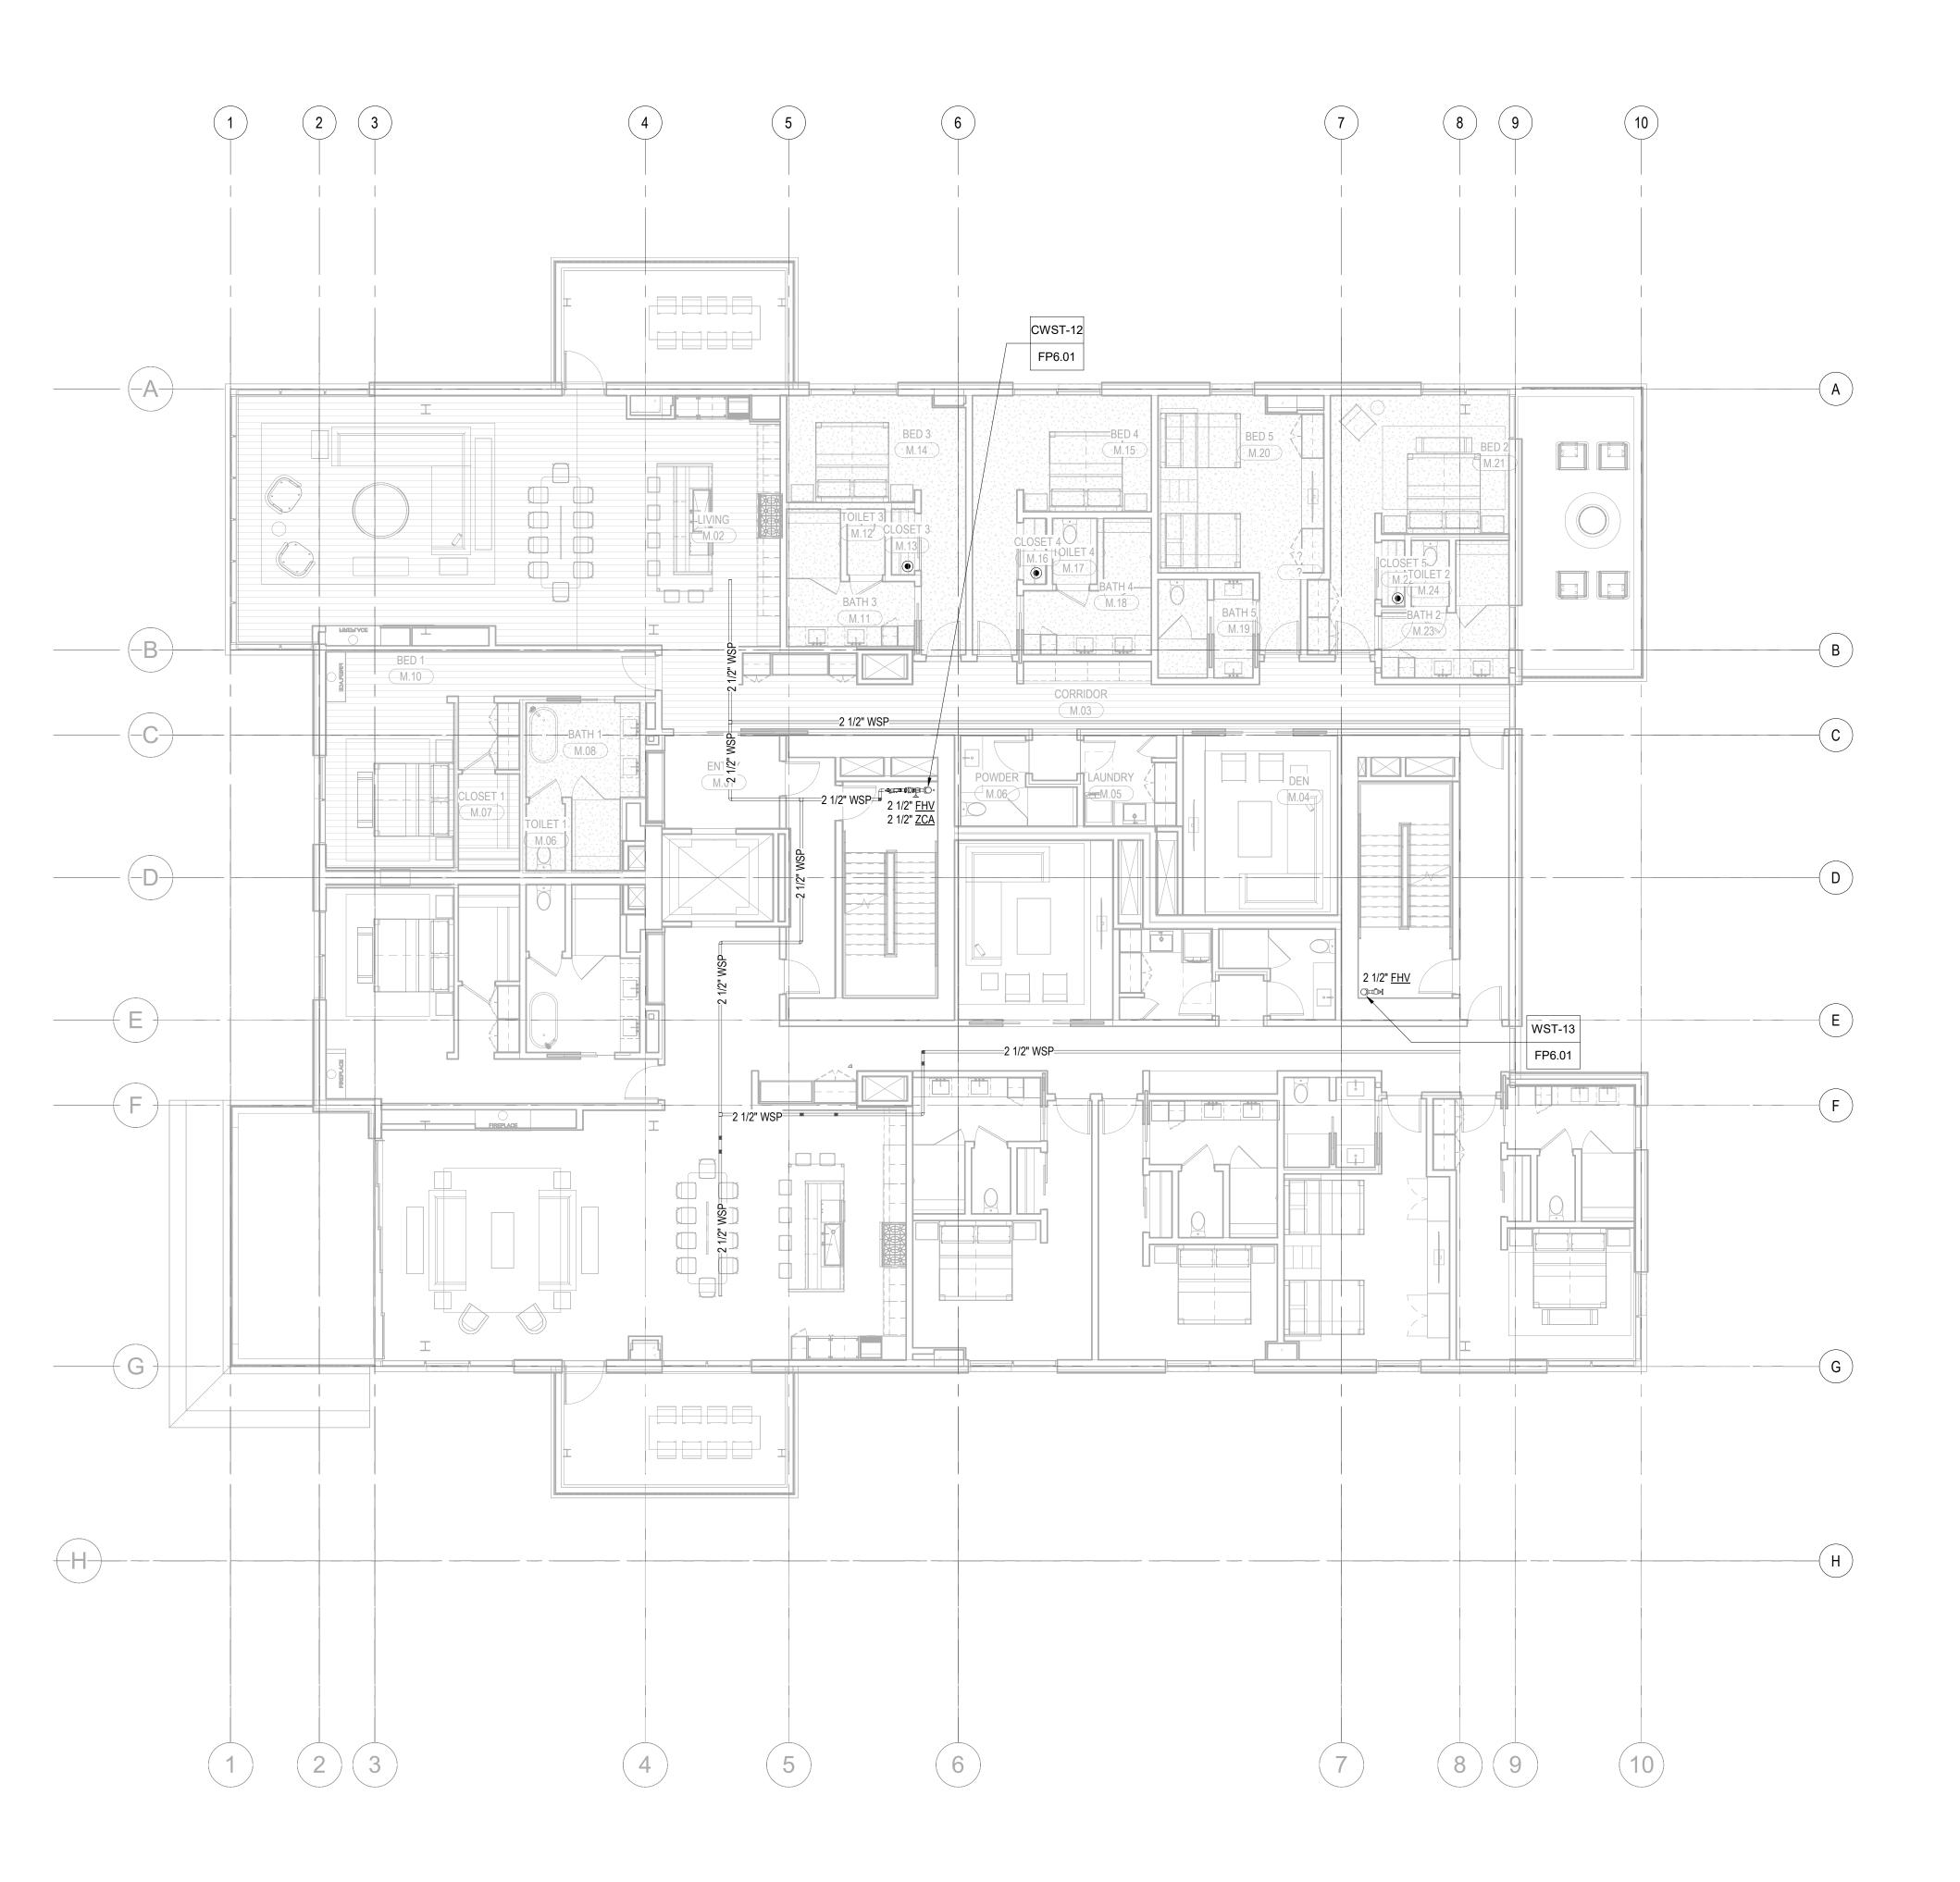
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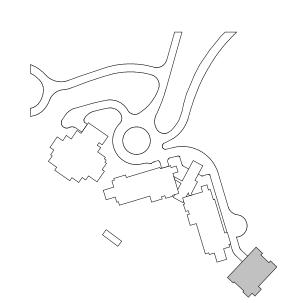
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FIRE PROTECTION PLAN - TOWER C - LEVEL 5

FP2.2C.15



1 TOWER C - LEVEL 6 - FP
1/8" = 1'-0"



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principal architect__TK_____

project manager__JCC_____

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checked by__Checker_____


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no. date

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FIRE PROTECTION PLAN - TOWER C - LEVEL 6

FP2.2C.16



1 TOWER C - LEVEL 7 - FP
1/8" = 1'-0"
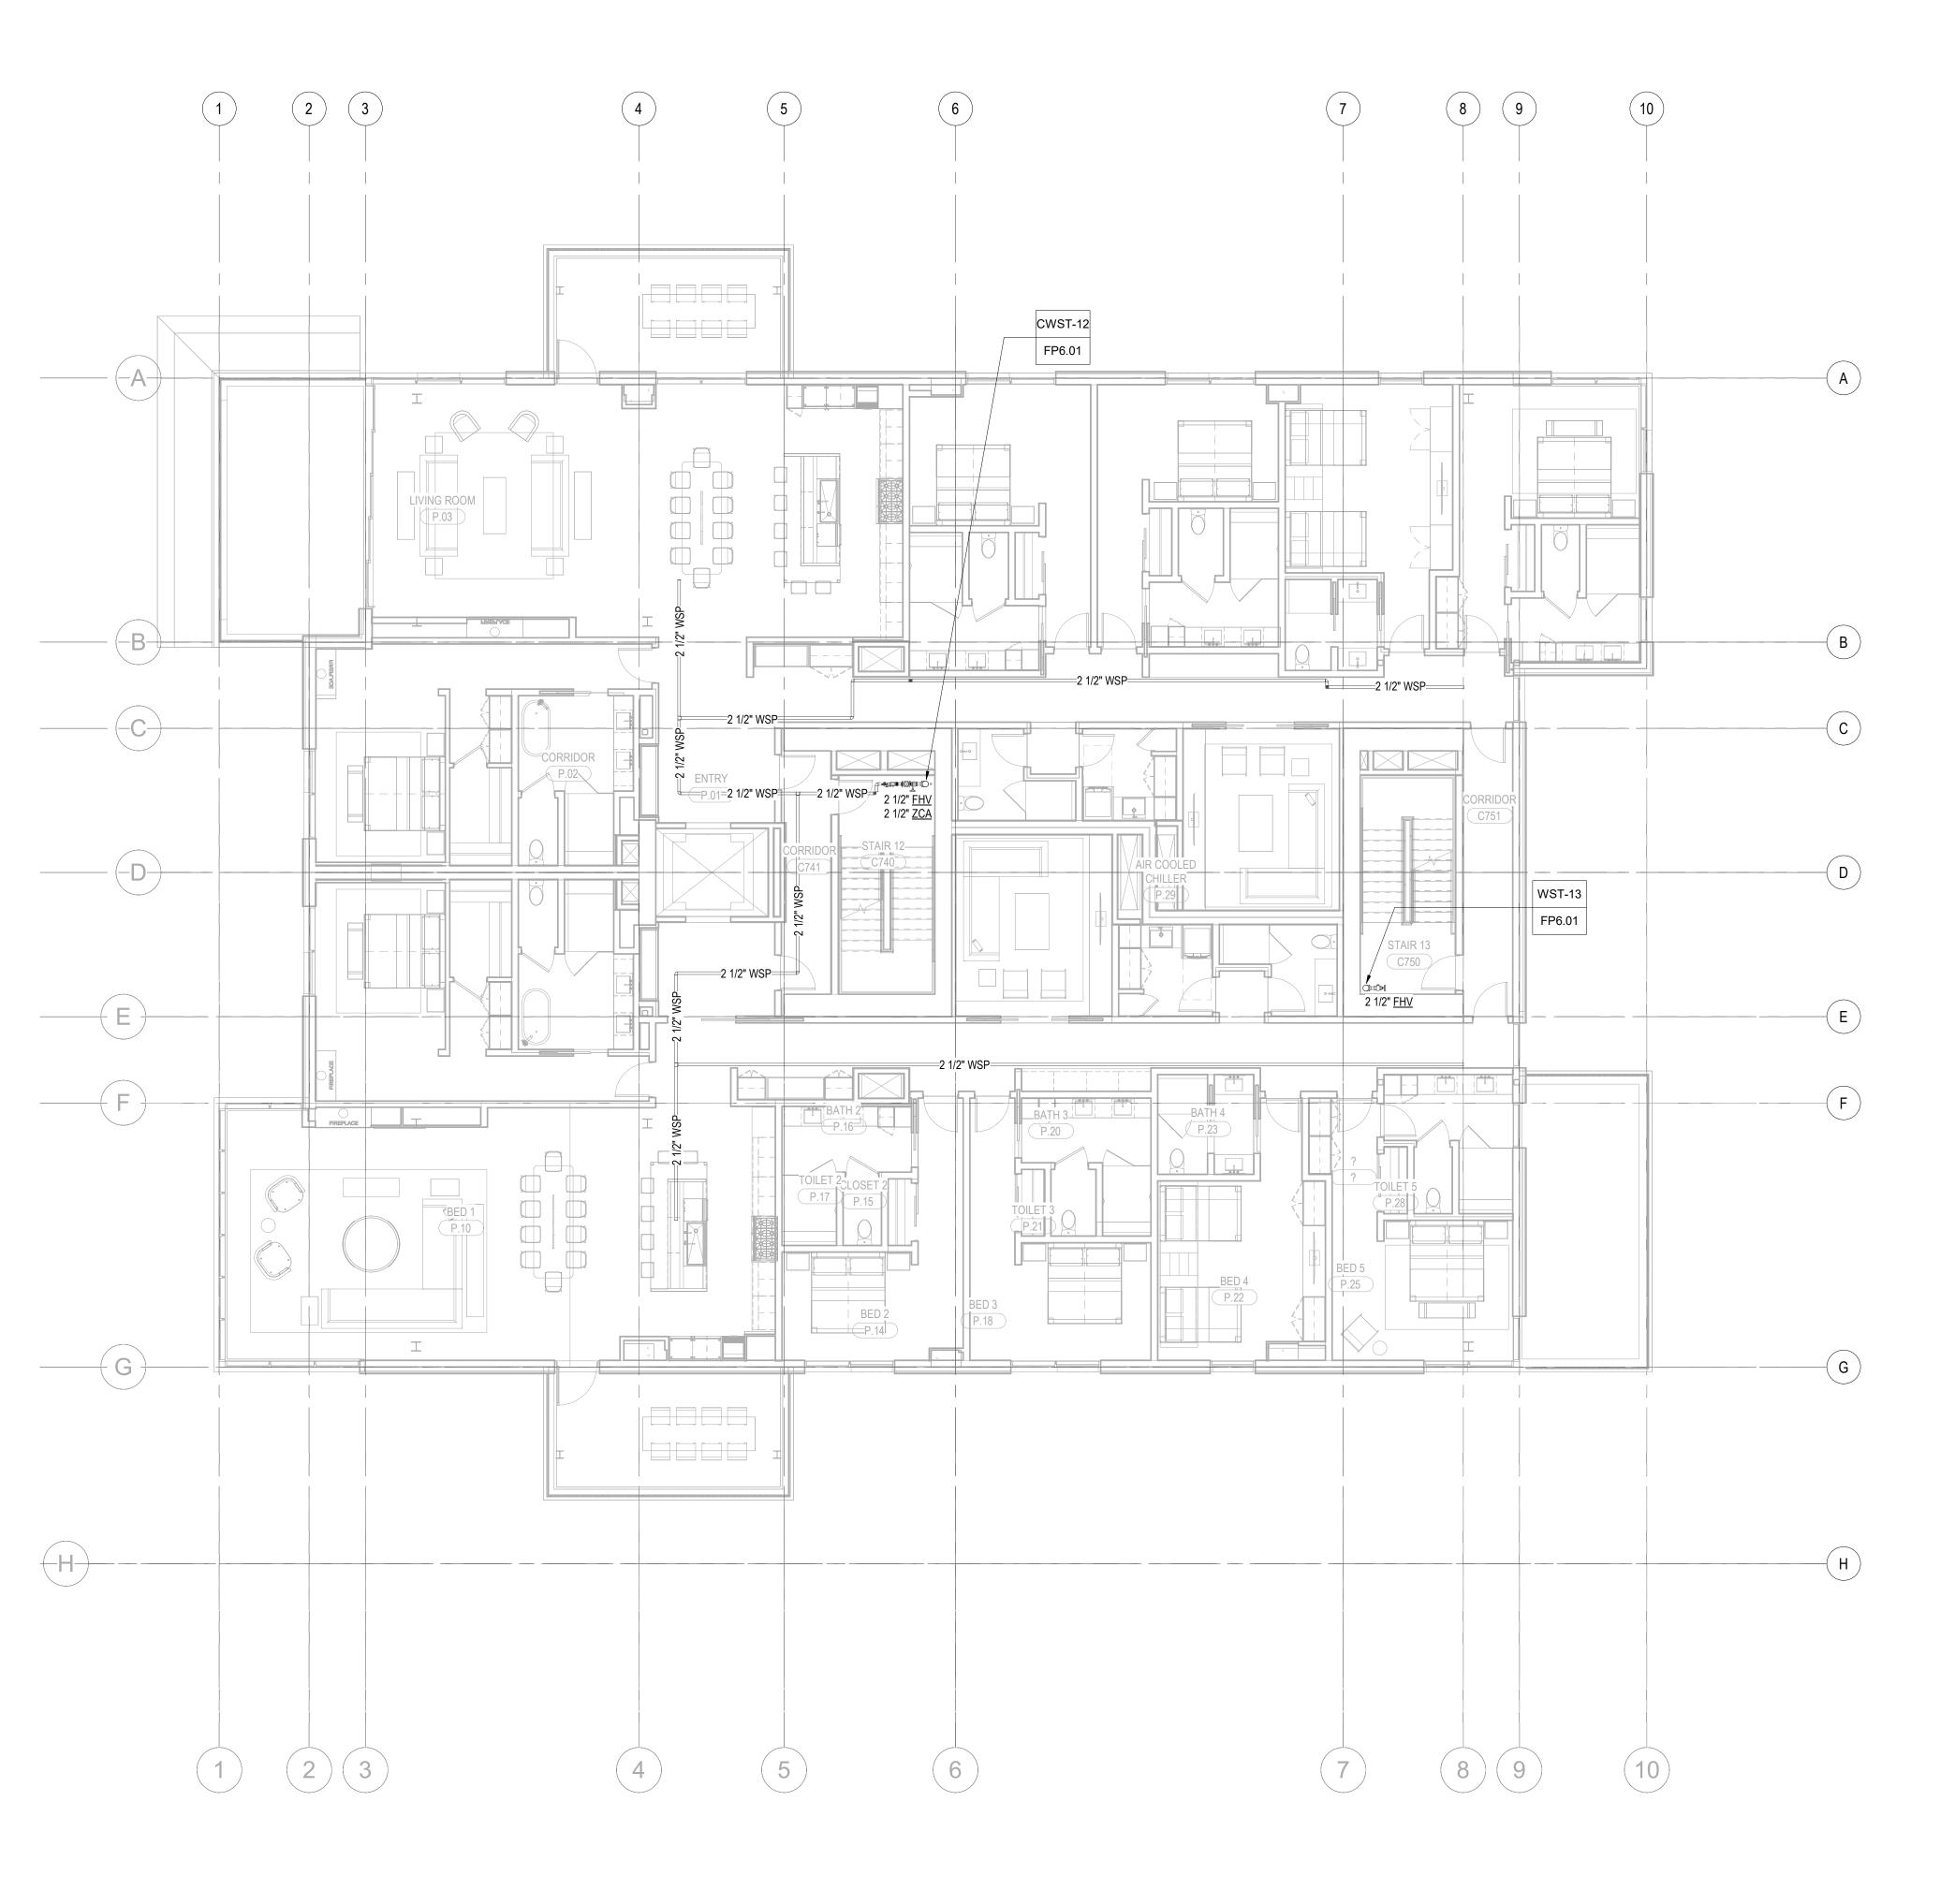
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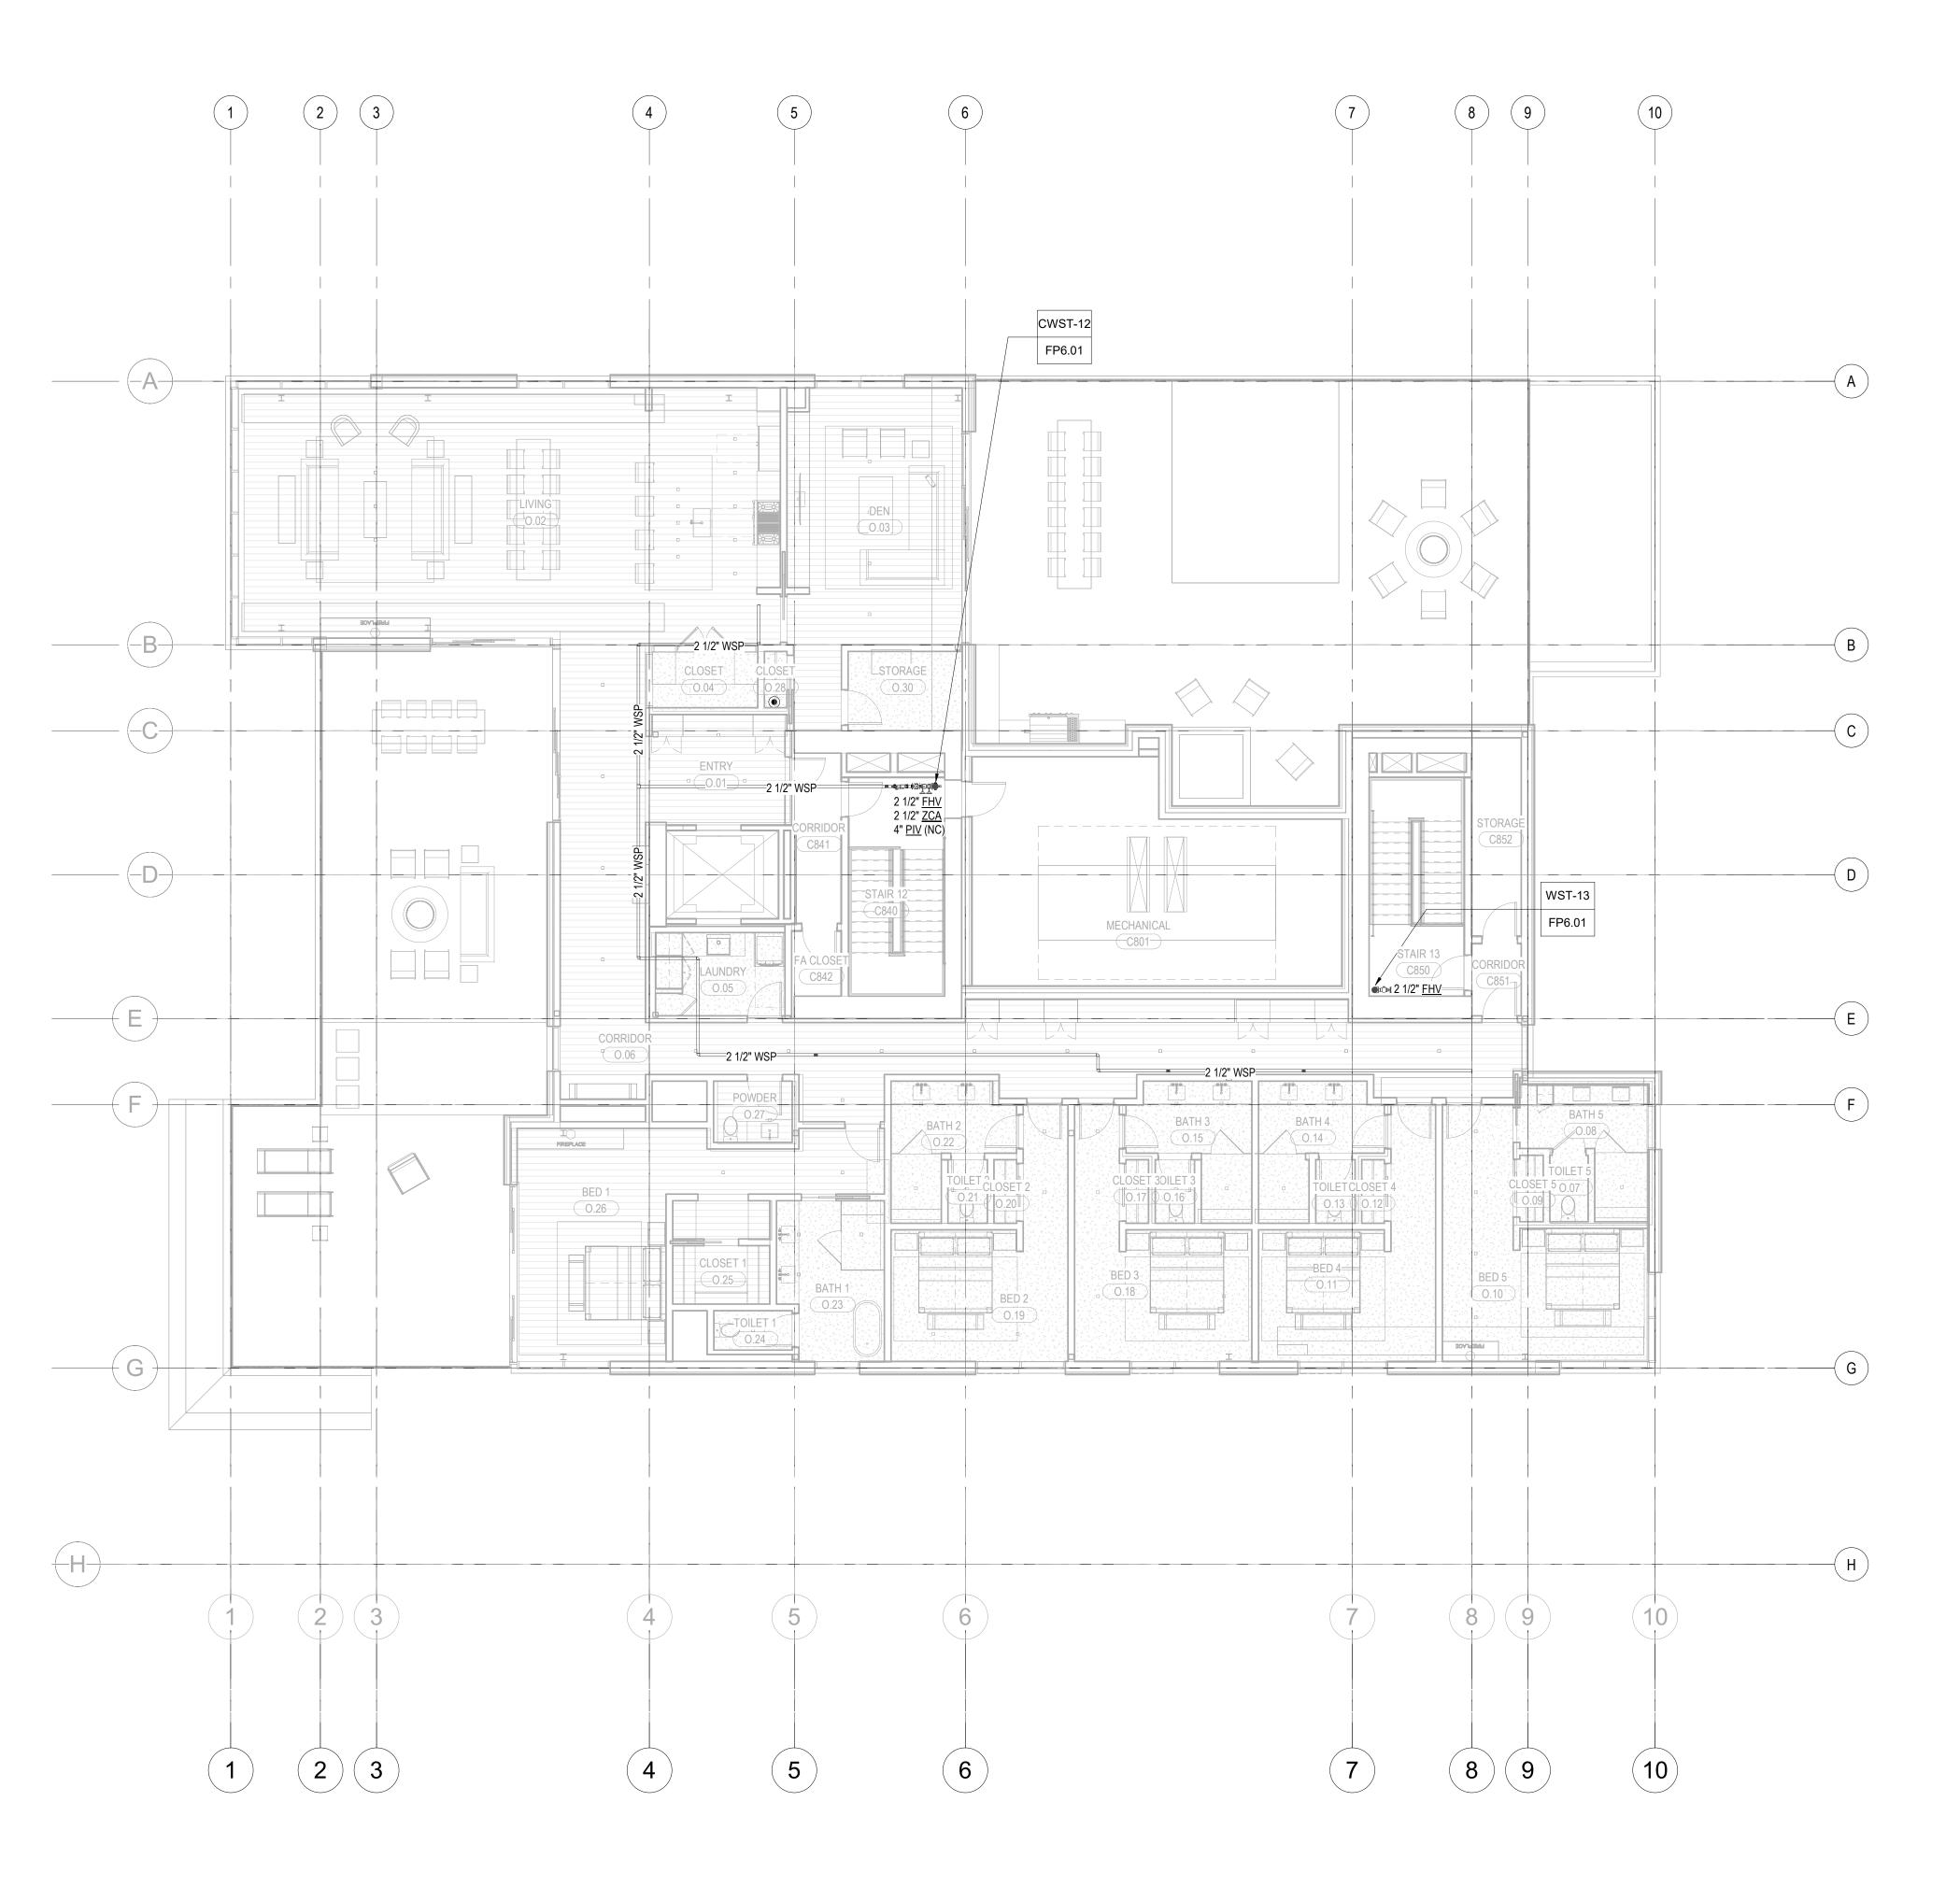
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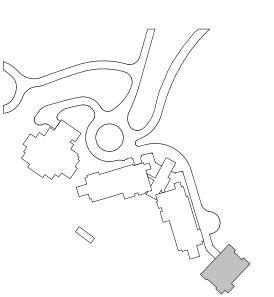
FIRE PROTECTION PLAN - TOWER C - LEVEL 7

FP2.2C.17



1 TOWER C - LEVEL 8 - FP

1/8" = 1'-0"



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Vertical Transportation Consulatant Lerch Bates 19515 North Creek Parkway, Suite 304 Bothell, WA 98011

Structural Engineer

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Building Envelope Consultant
RDH

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Studio Pacifica
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principal architect__TK_____ project manager__JCC____ drawn by__CRB, SMK____

MEP Engineer
WSP USA
1001 Fourth Ave., Suite 3100
Seattle, WA 98154


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job no. 20052
date 11/18/2022

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no. date


ISSUE FOR CONSTRUCTION 11/18/2022

FIRE PROTECTION PLAN - TOWER C - LEVEL 8

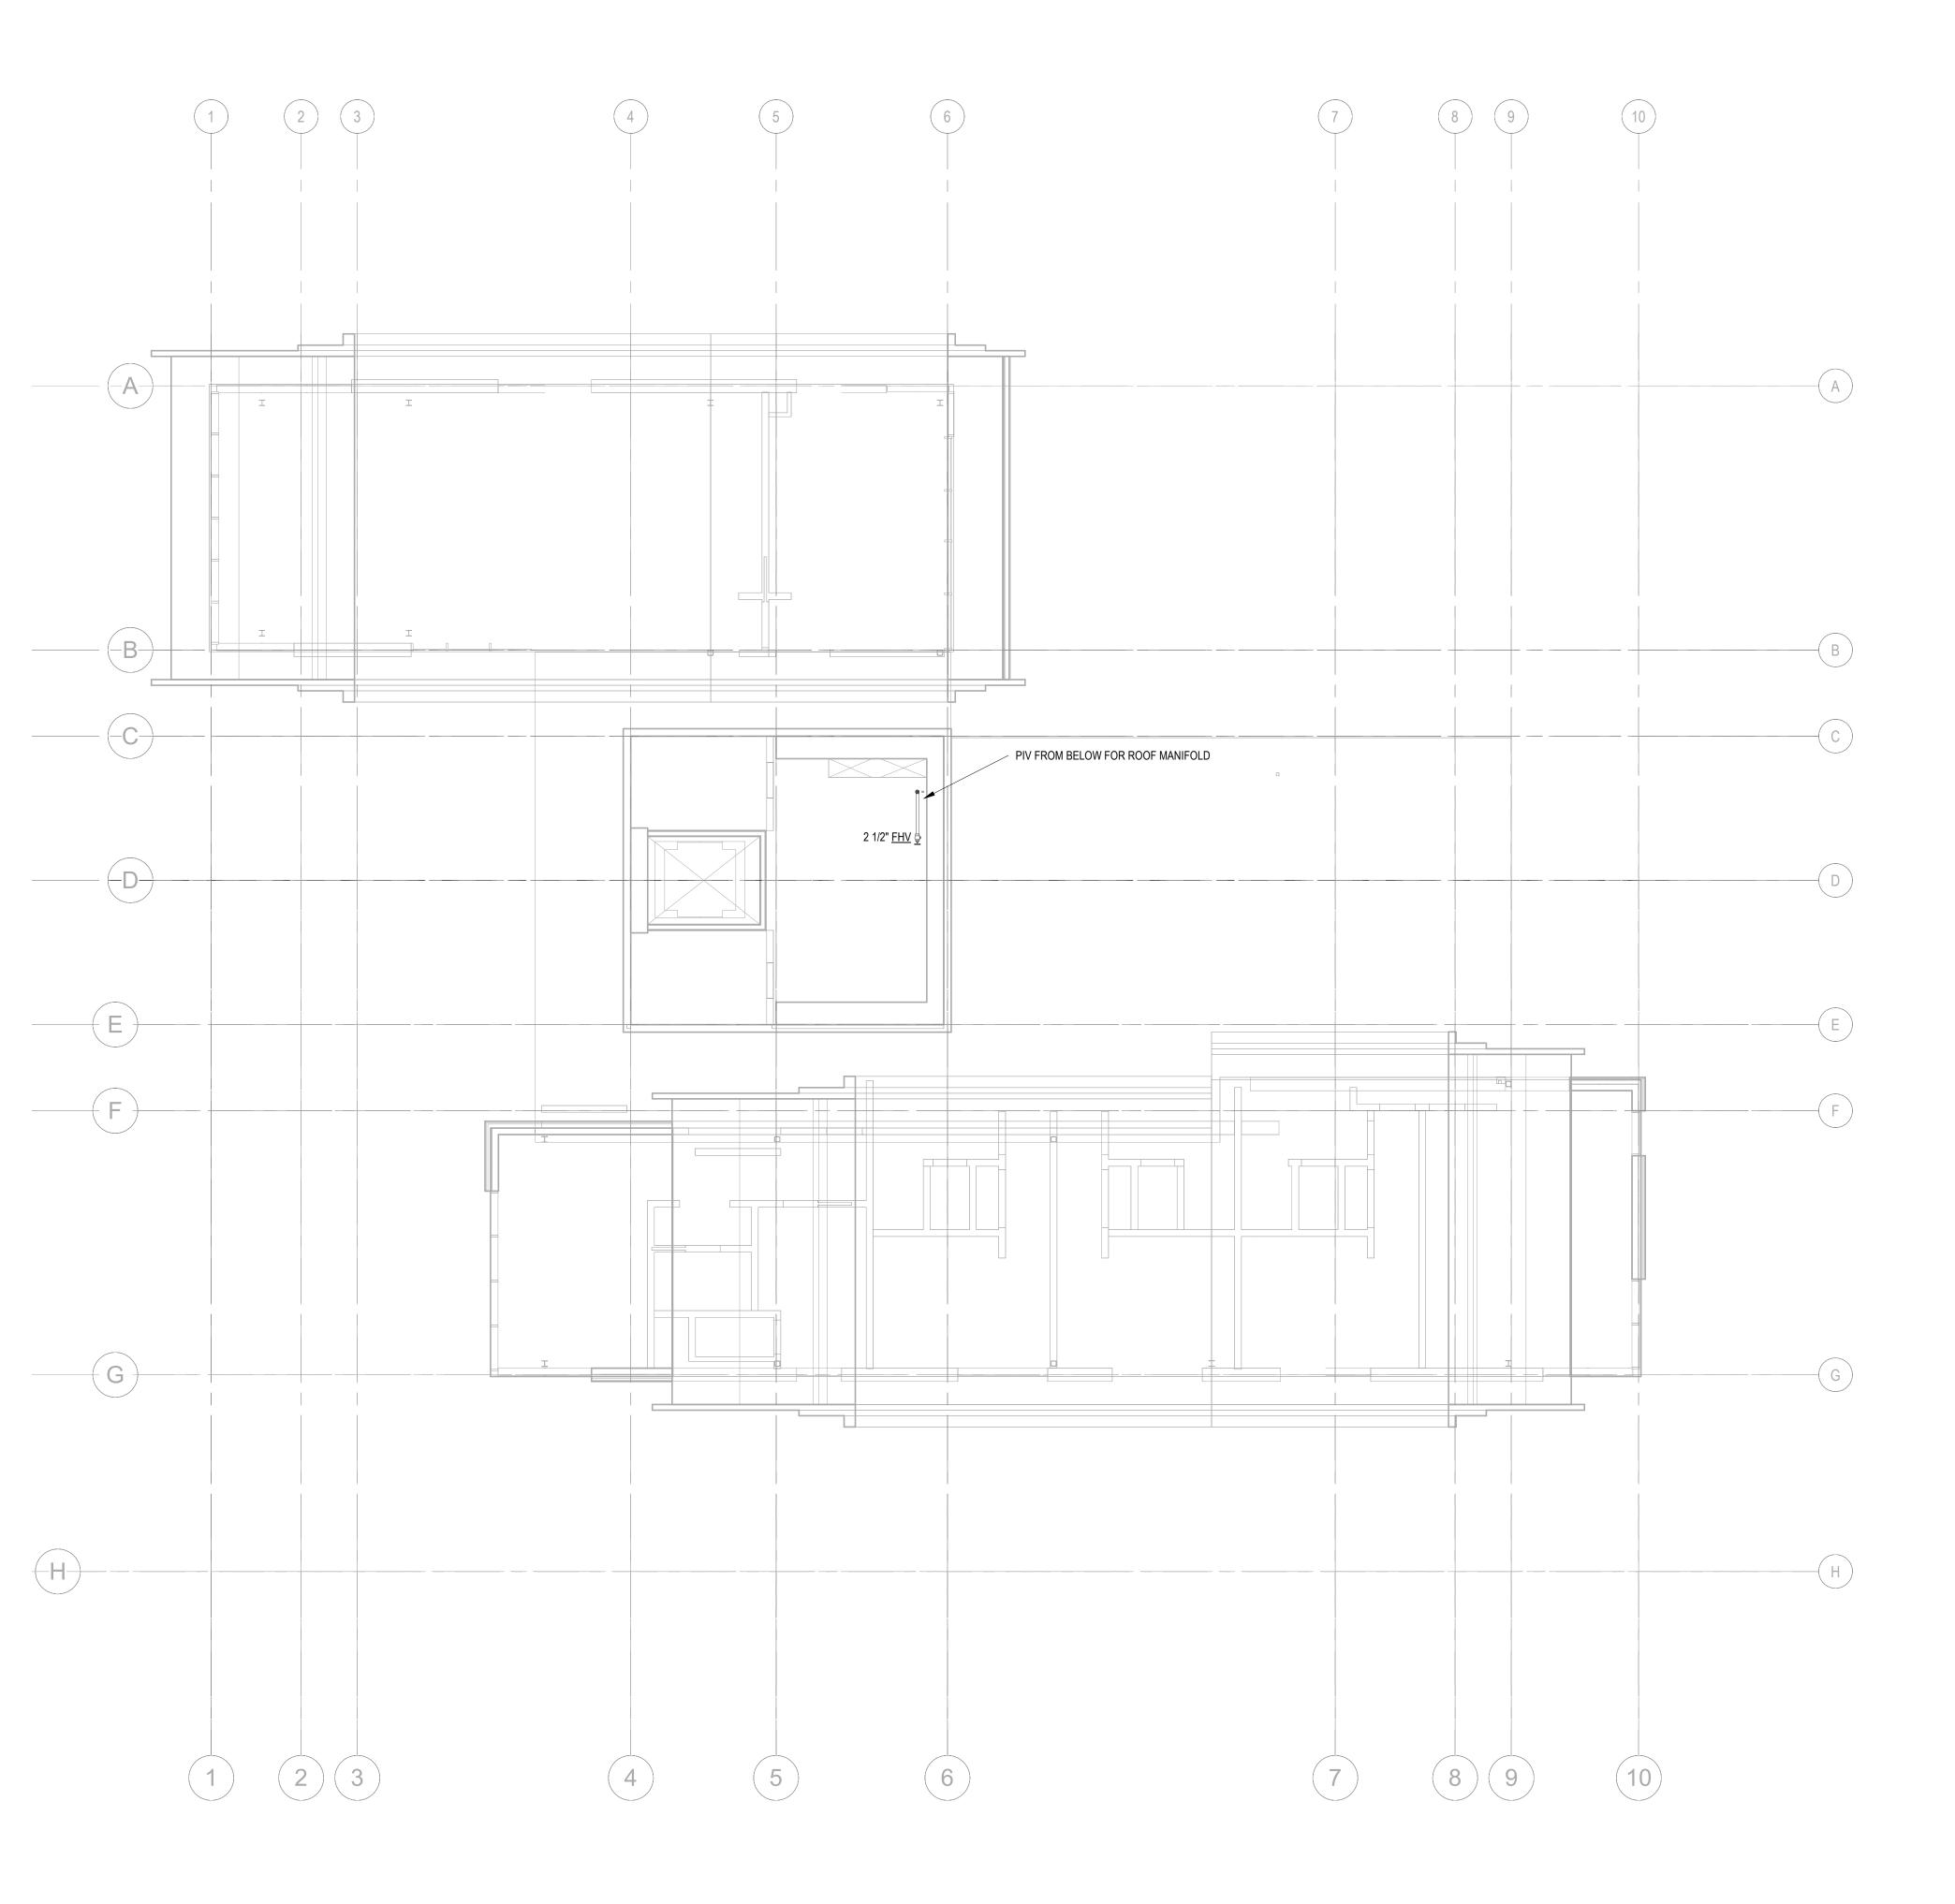

1 TOWER C - ROOF - FP

1/8" = 1'-0"

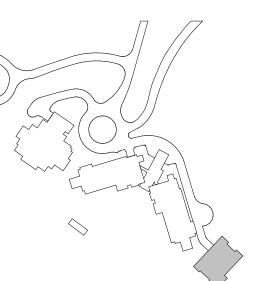

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Reserved for permit stamp

project:
SOMMET BLANC - C



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Seattle, WA 98154

principal architect__TK______

checked by Checker
job no. 20052

job no. 20052 date 11/18/2022 sions:


project manager<u>JCC</u>


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ISSUE FOR CONSTRUCTION 11/18/2022

FIRE PROTECTION PLAN
- TOWER C - ROOF
LEVEL

FP2.2C.R



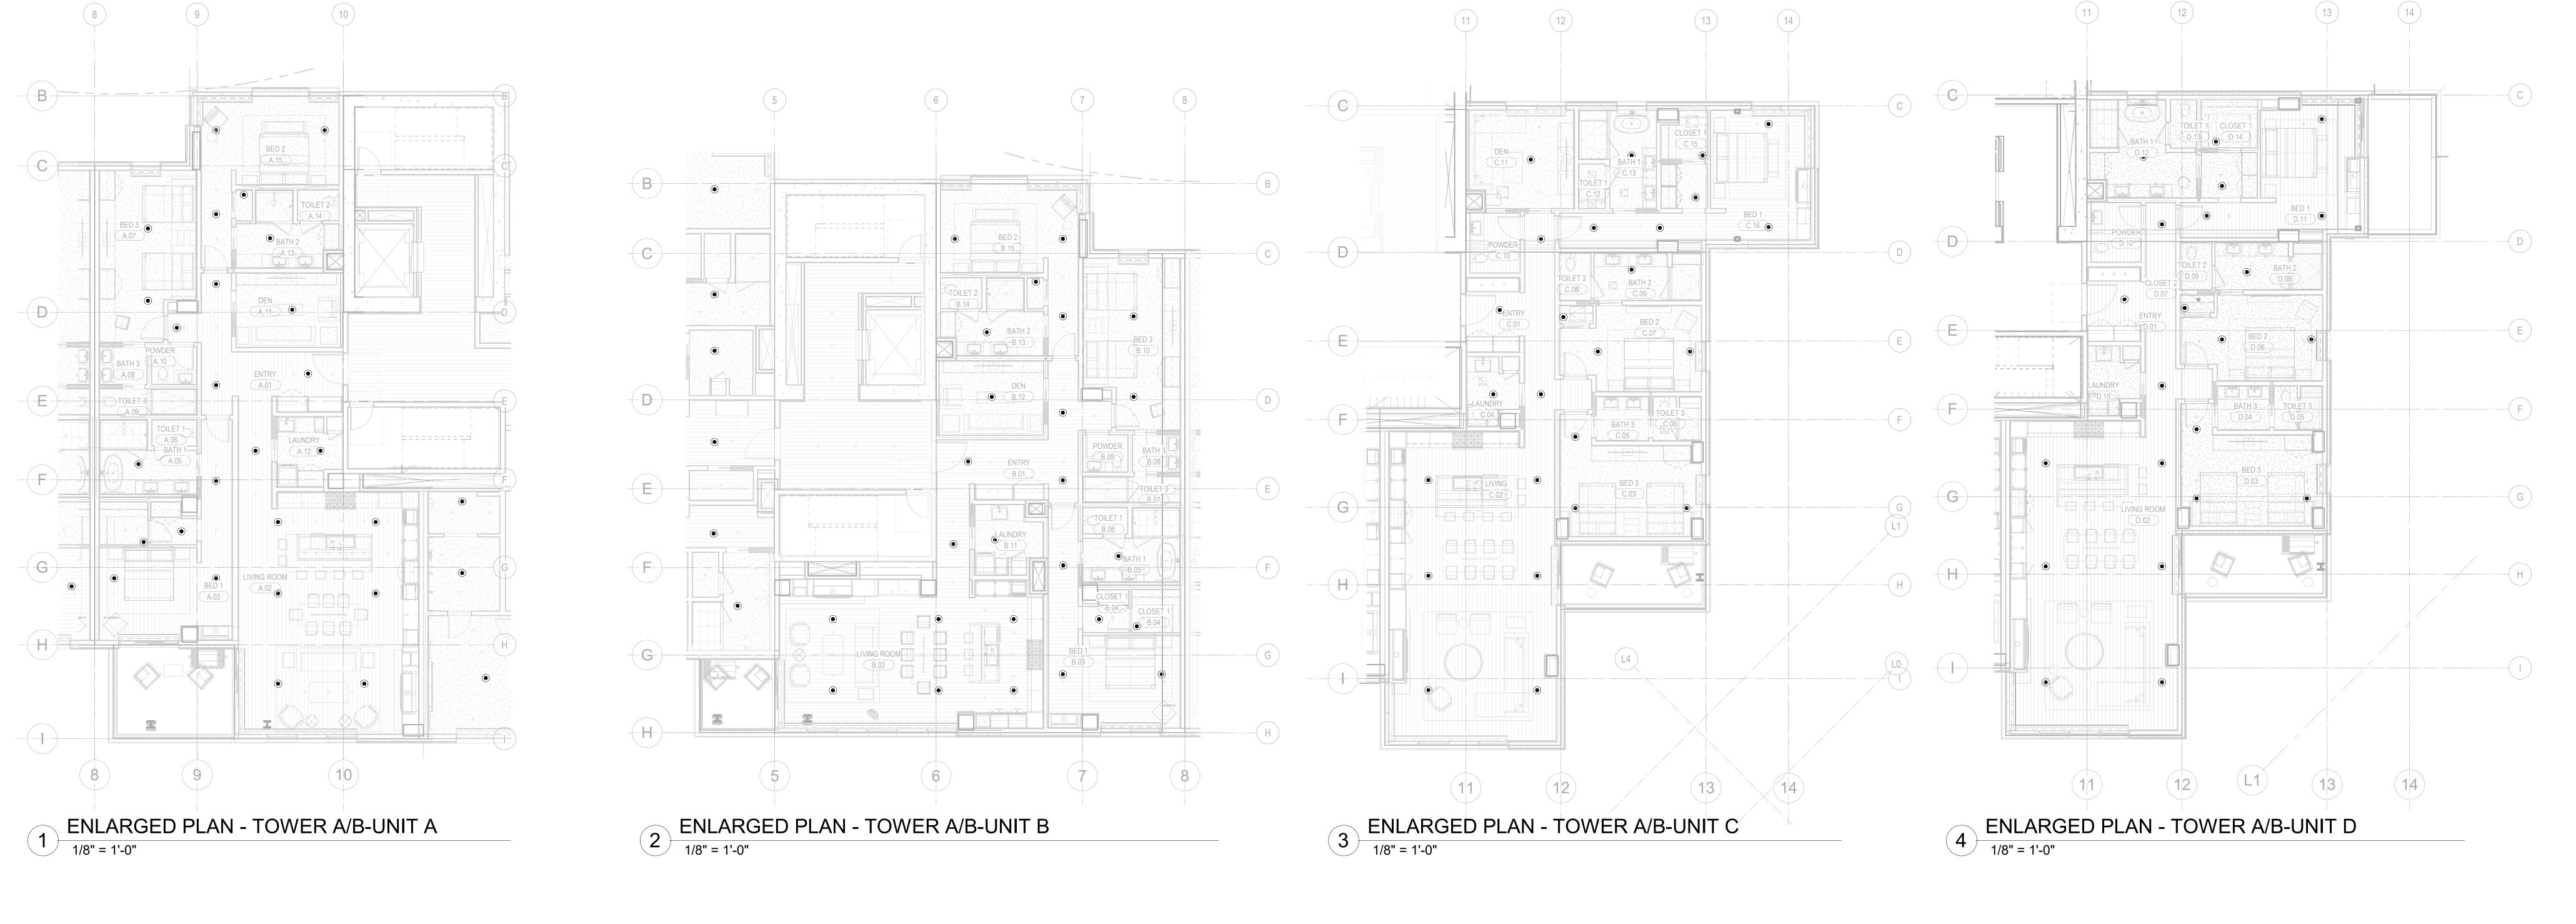

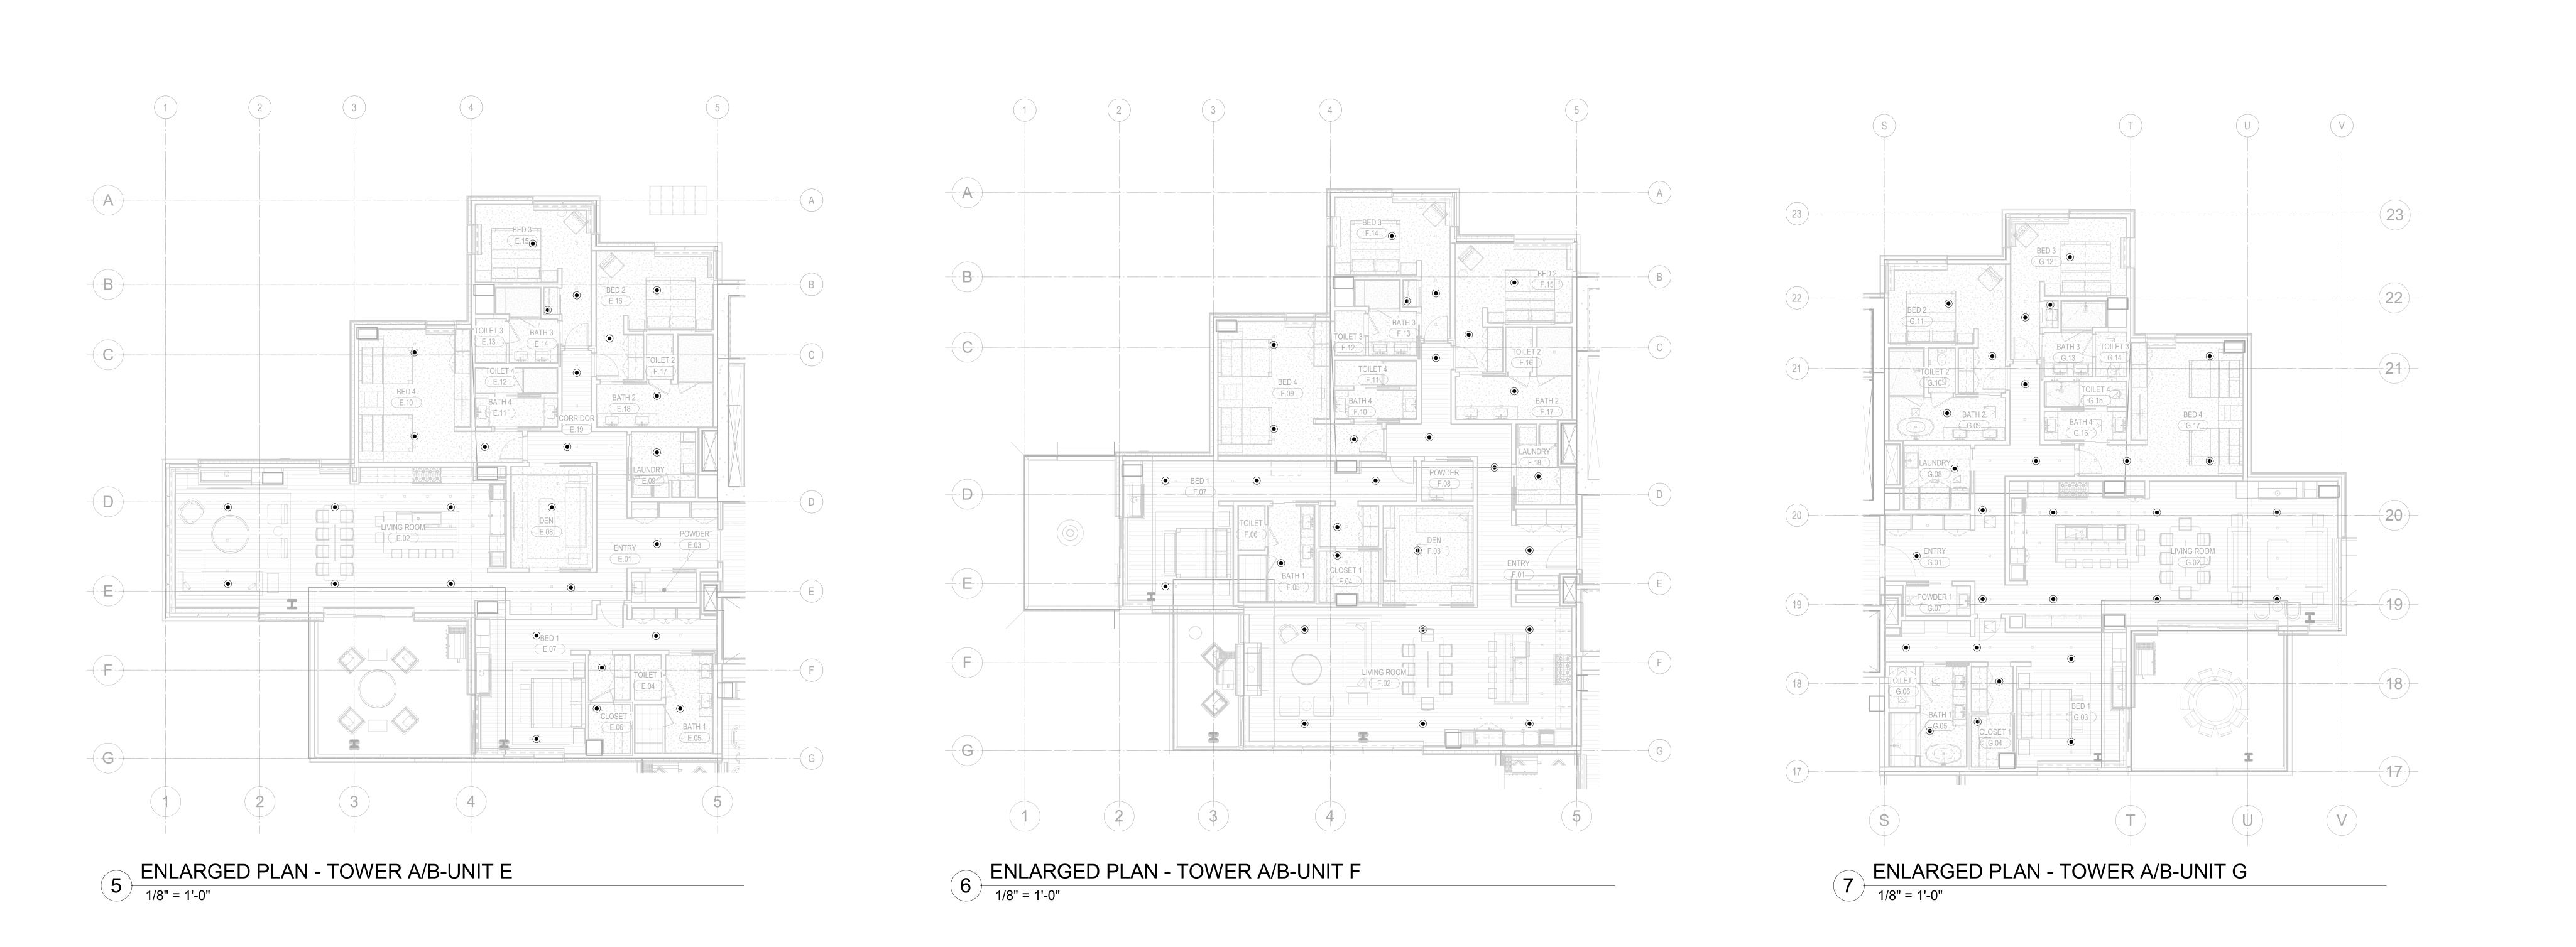White Summit Development, LLC PO Box 980022 Park City, Utah 84098 Acoustic Consultant
BRC Acoustics
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Seattle, WA 98101 Pool Consultant
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Studio Pacifica 2144 Westlake Ave N, Suite F Seattle, WA 98109 MEP Engineer
WSP USA 1001 Fourth Ave., Suite 3100 Seattle, WA 98154 principal architect_____ project manager__JCC drawn by__CRB, SMK____ checked by__JCC_____ job no. 20052 date 11/18/2022 ISSUE FOR CONSTRUCTION 11/18/2022 FIRE PROTECTION UNIT PLANS - TOWER A/B FP2.4.01







ENLARGED PLAN - TOWER A/B-UNIT H

2 ENLARGED PLAN - TOWER A/B-UNIT I

1/8" = 1'-0"

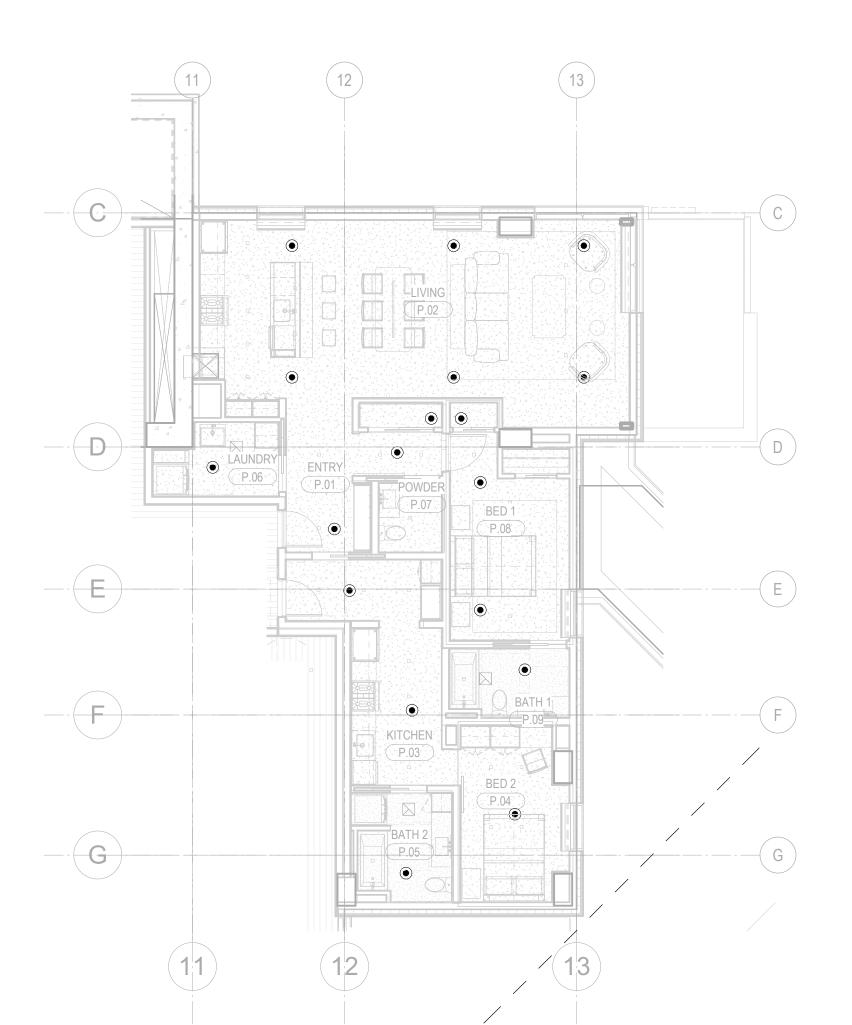

3 ENLARGED PLAN - TOWER A/B-UNIT P

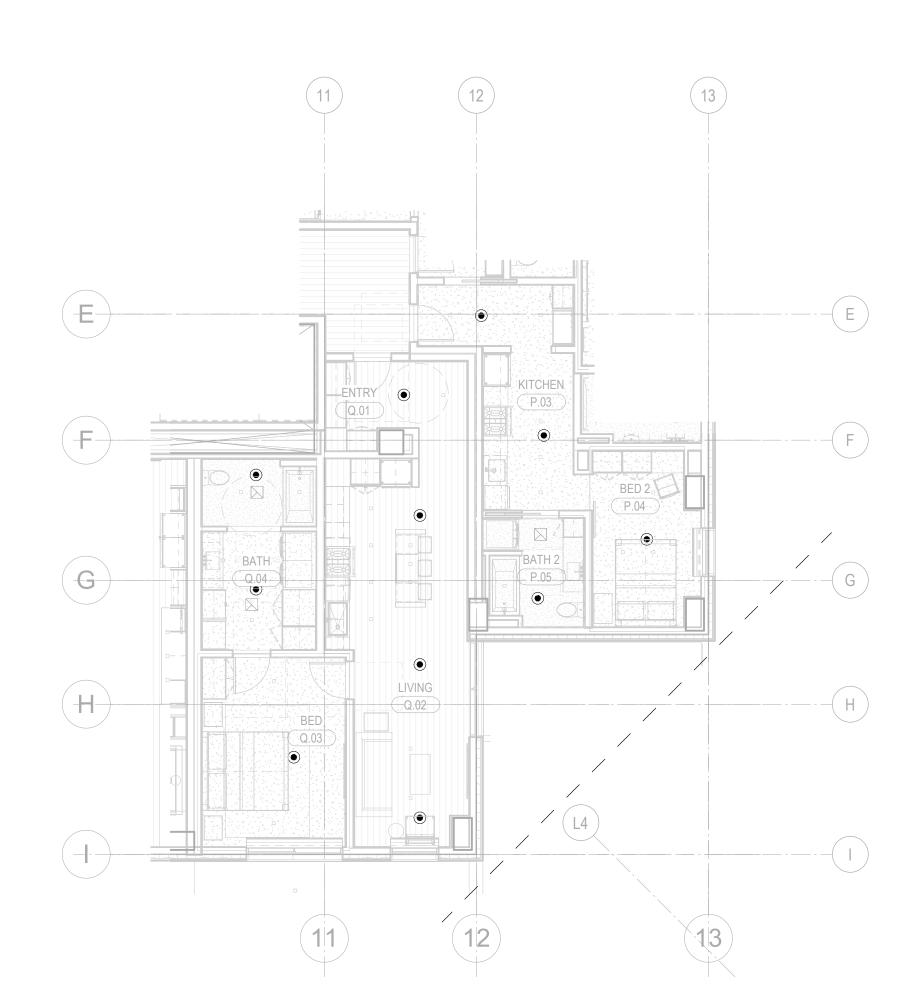

ENLARGED PLAN - TOWER A/B-UNIT Q

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MEP Engineer WSP USA 1001 Fourth Ave., Suite 3100 Seattle, WA 98154
principal architect
project managerJCC
drawn byCRB, SMK

checked by Checker _____

date 11/18/2022

job no. 20052


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11/18/2022

FIRE PROTECTION UNIT PLANS - TOWER A/B

FP2.4.02

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Park City, Utah 84098



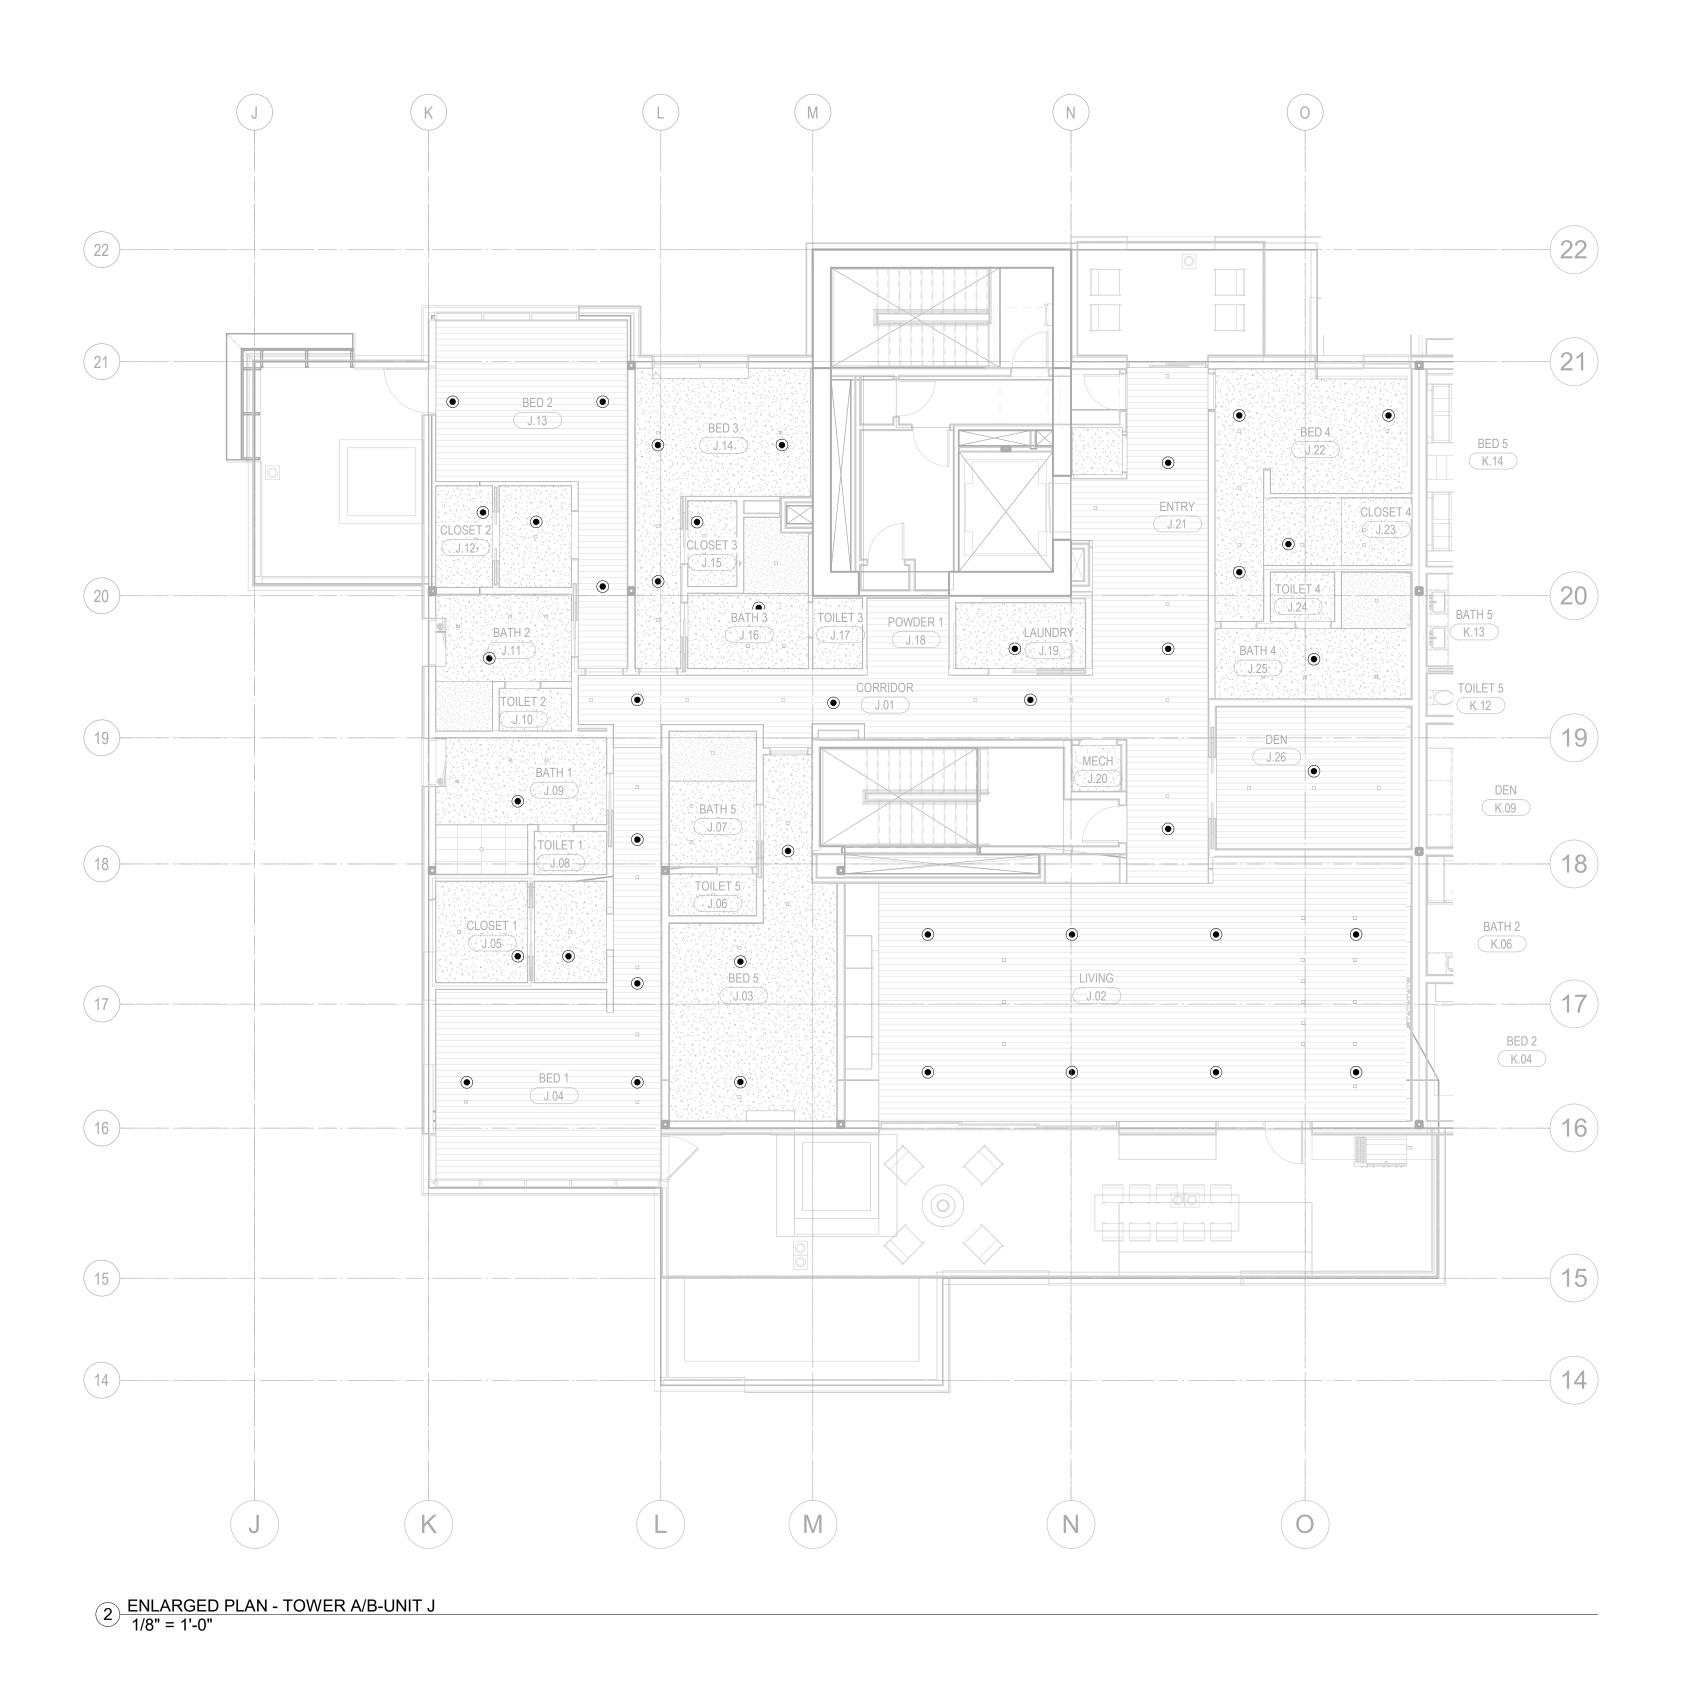

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Accessibility Consultant Studio Pacifica


Seattle, WA 98109

2144 Westlake Ave N, Suite F

FIRE PROTECTION UNIT PLANS - TOWER A/B


CONSTRUCTION

11/18/2022

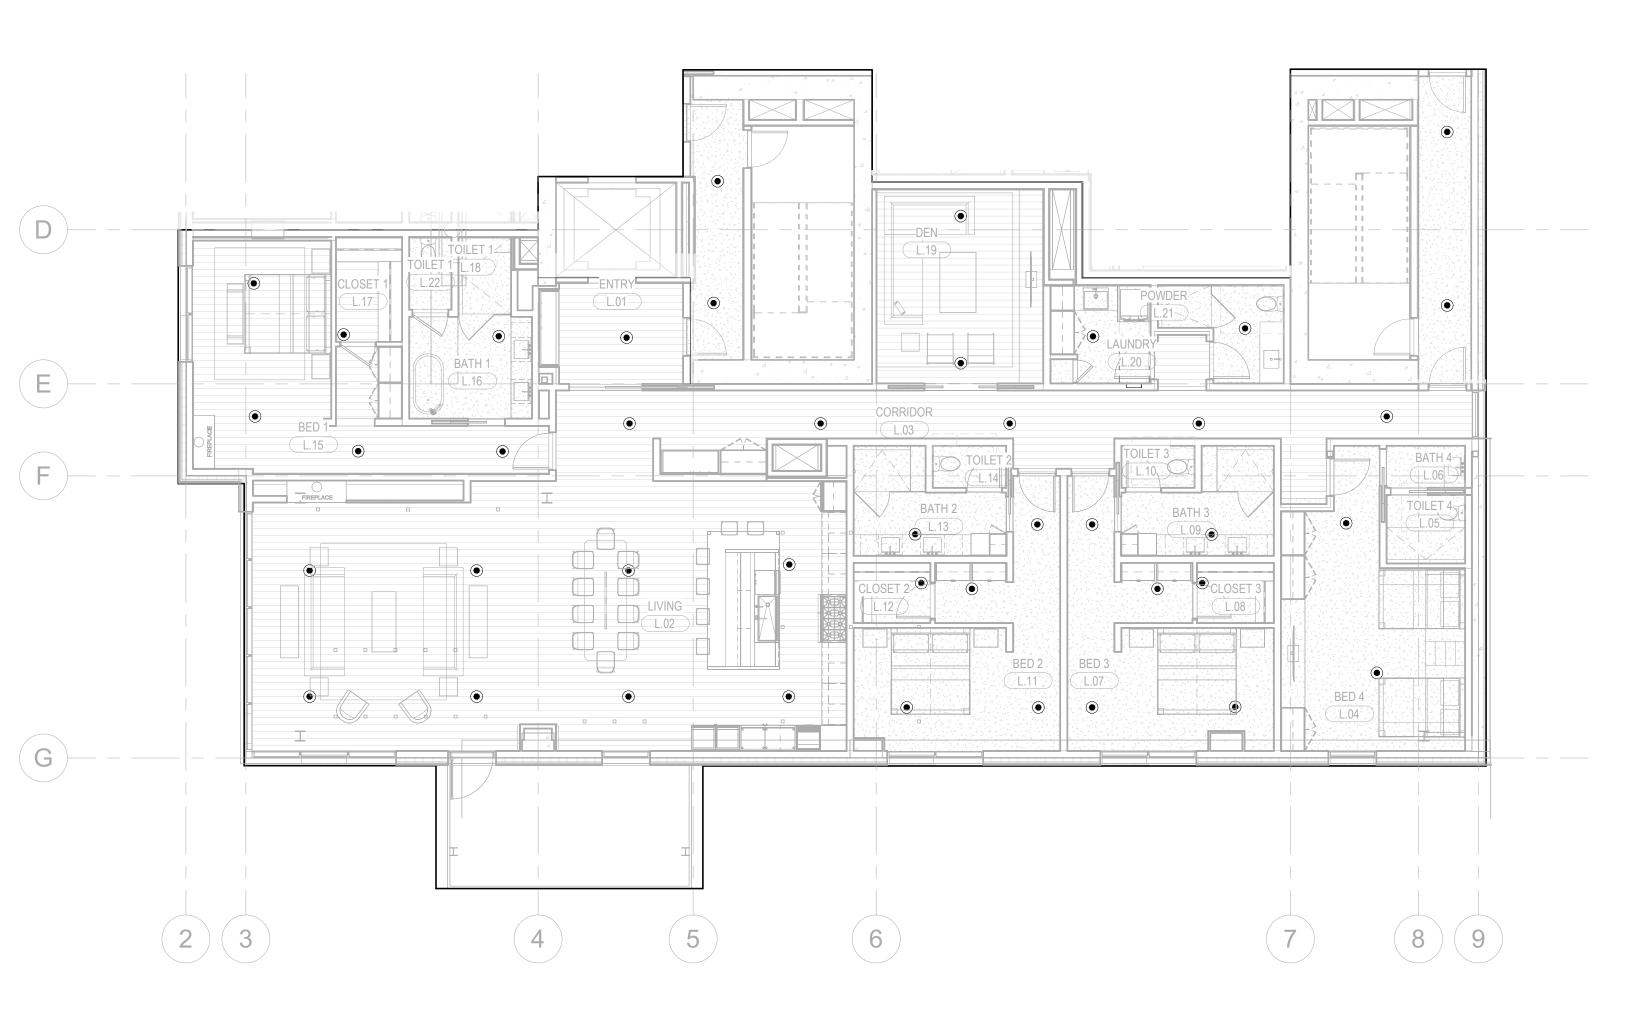


ENLARGED PLAN - C -UNIT L


1/8" = 1'-0"

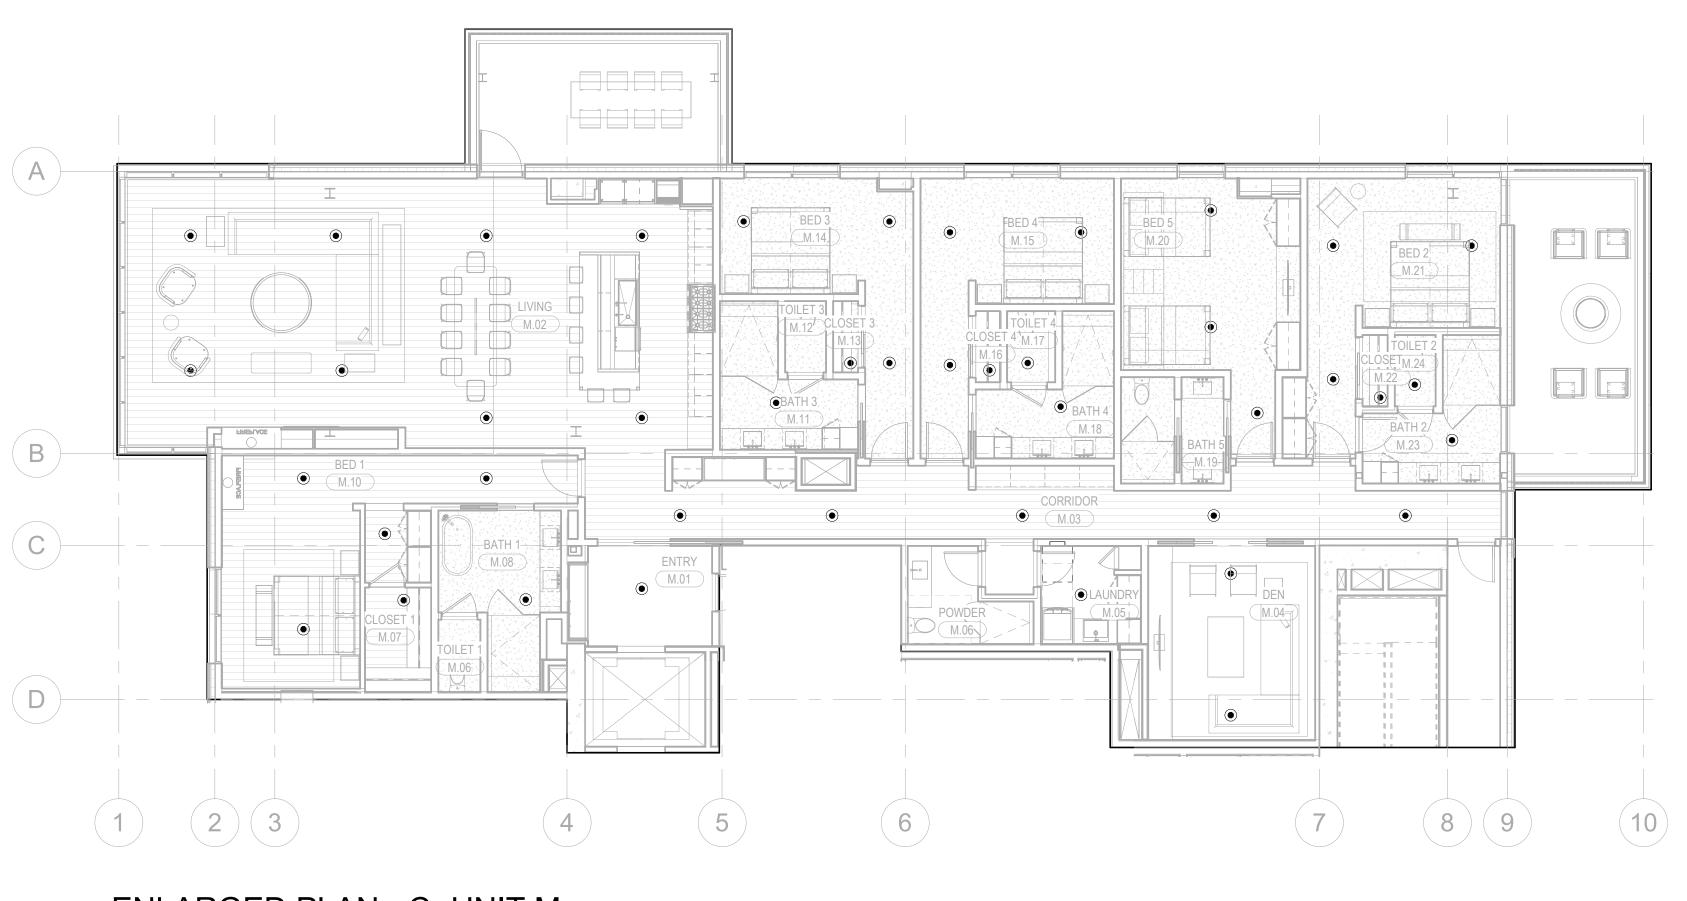

2 ENLARGED PLAN - C -UNIT M 1/8" = 1'-0"

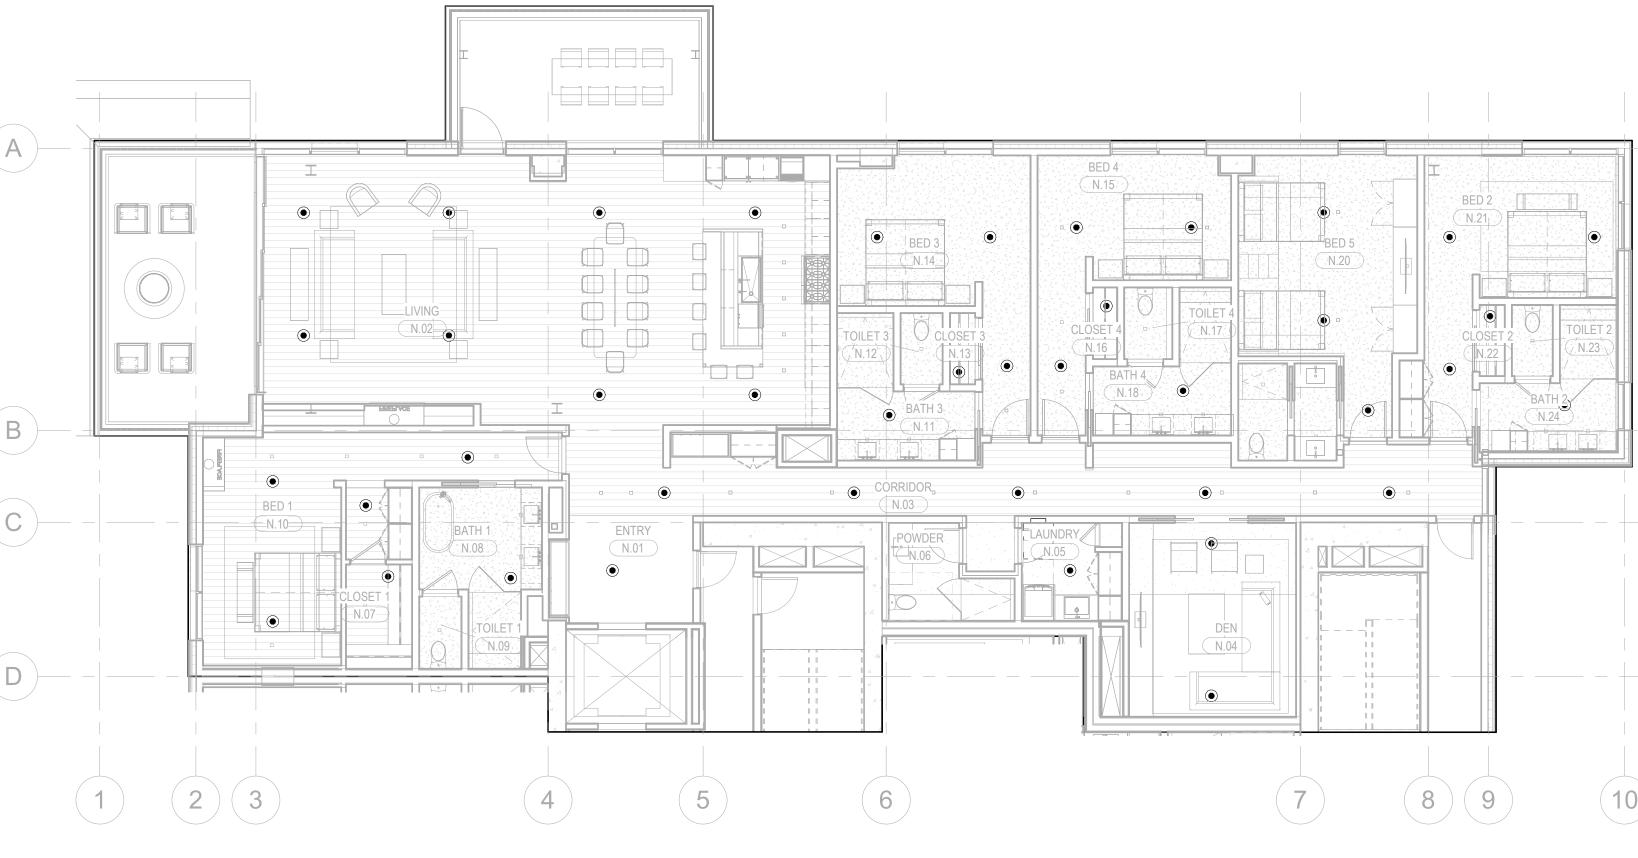


1 2 3 4 3 ENLARGED PLAN - C -UNIT N 1/8" = 1'-0"

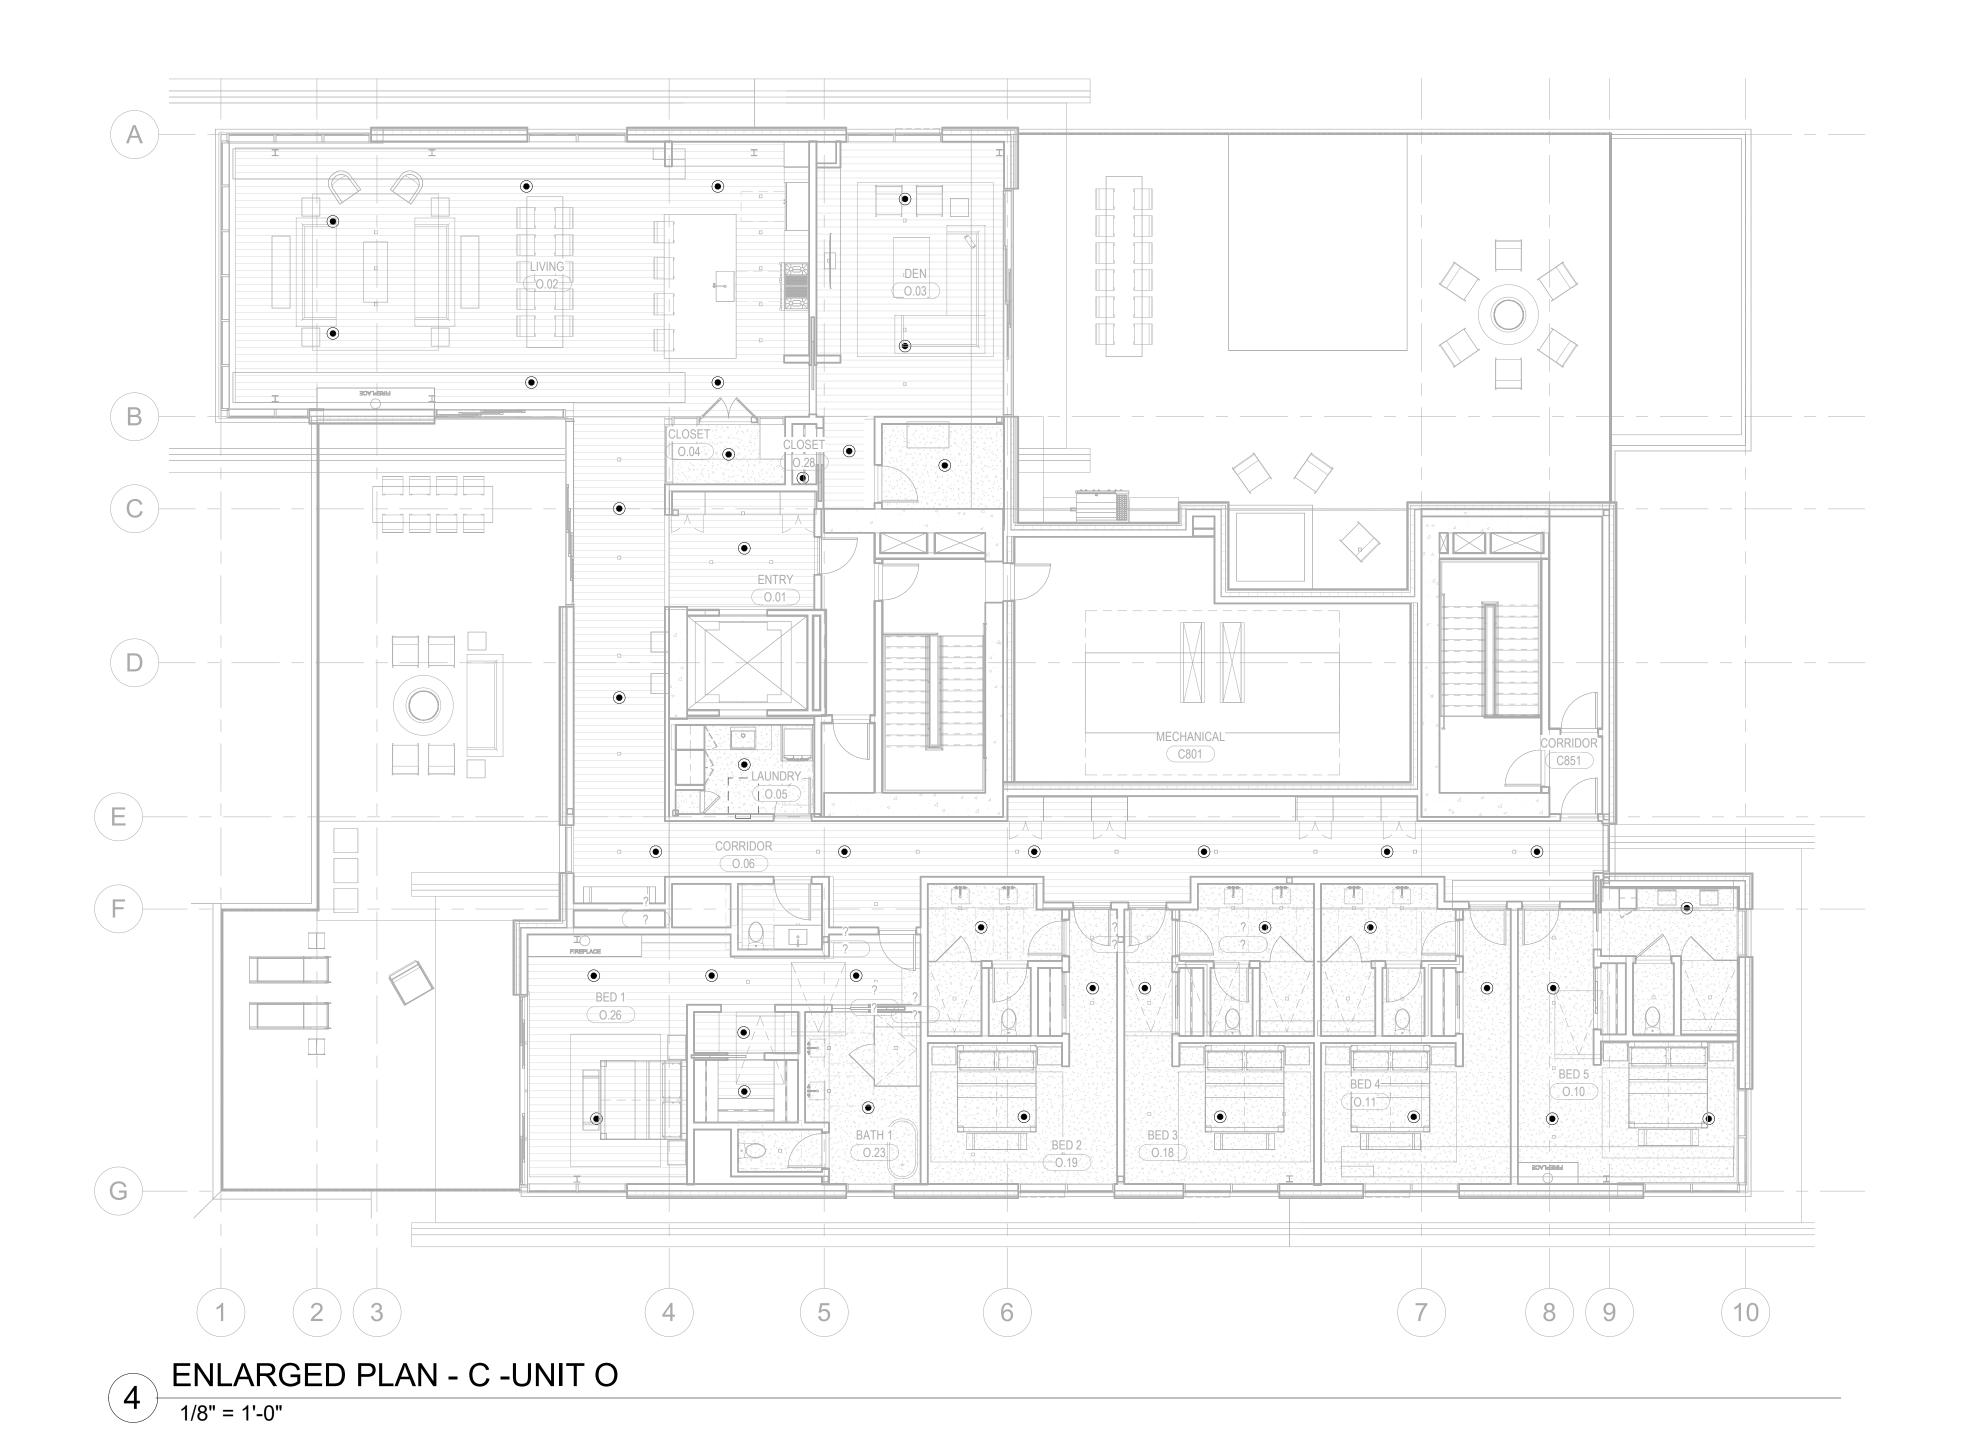


5 ENLARGED PLAN - C -UNIT R

1/8" = 1'-0"

OSouth Jackson St, Suite 600 Seattle, Washington 98104 USA +1 206 624 5670 olsonkundig.com	SOMMET BLANC - C DEER VALLEY, UTAH
Vhite Summit De PO Box Park City, U	
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Accessibility Consultar Studio Pacifica 2144 Westlake Ave N. Seattle, WA 98109	
MEP Engineer WSP USA 1001 Fourth Ave., Suit Seattle, WA 98154	te 3100
- principal architect-	
-	JCC CRB, SMK Checker
job no.	
no. date	by
ISSUE CONSTR	

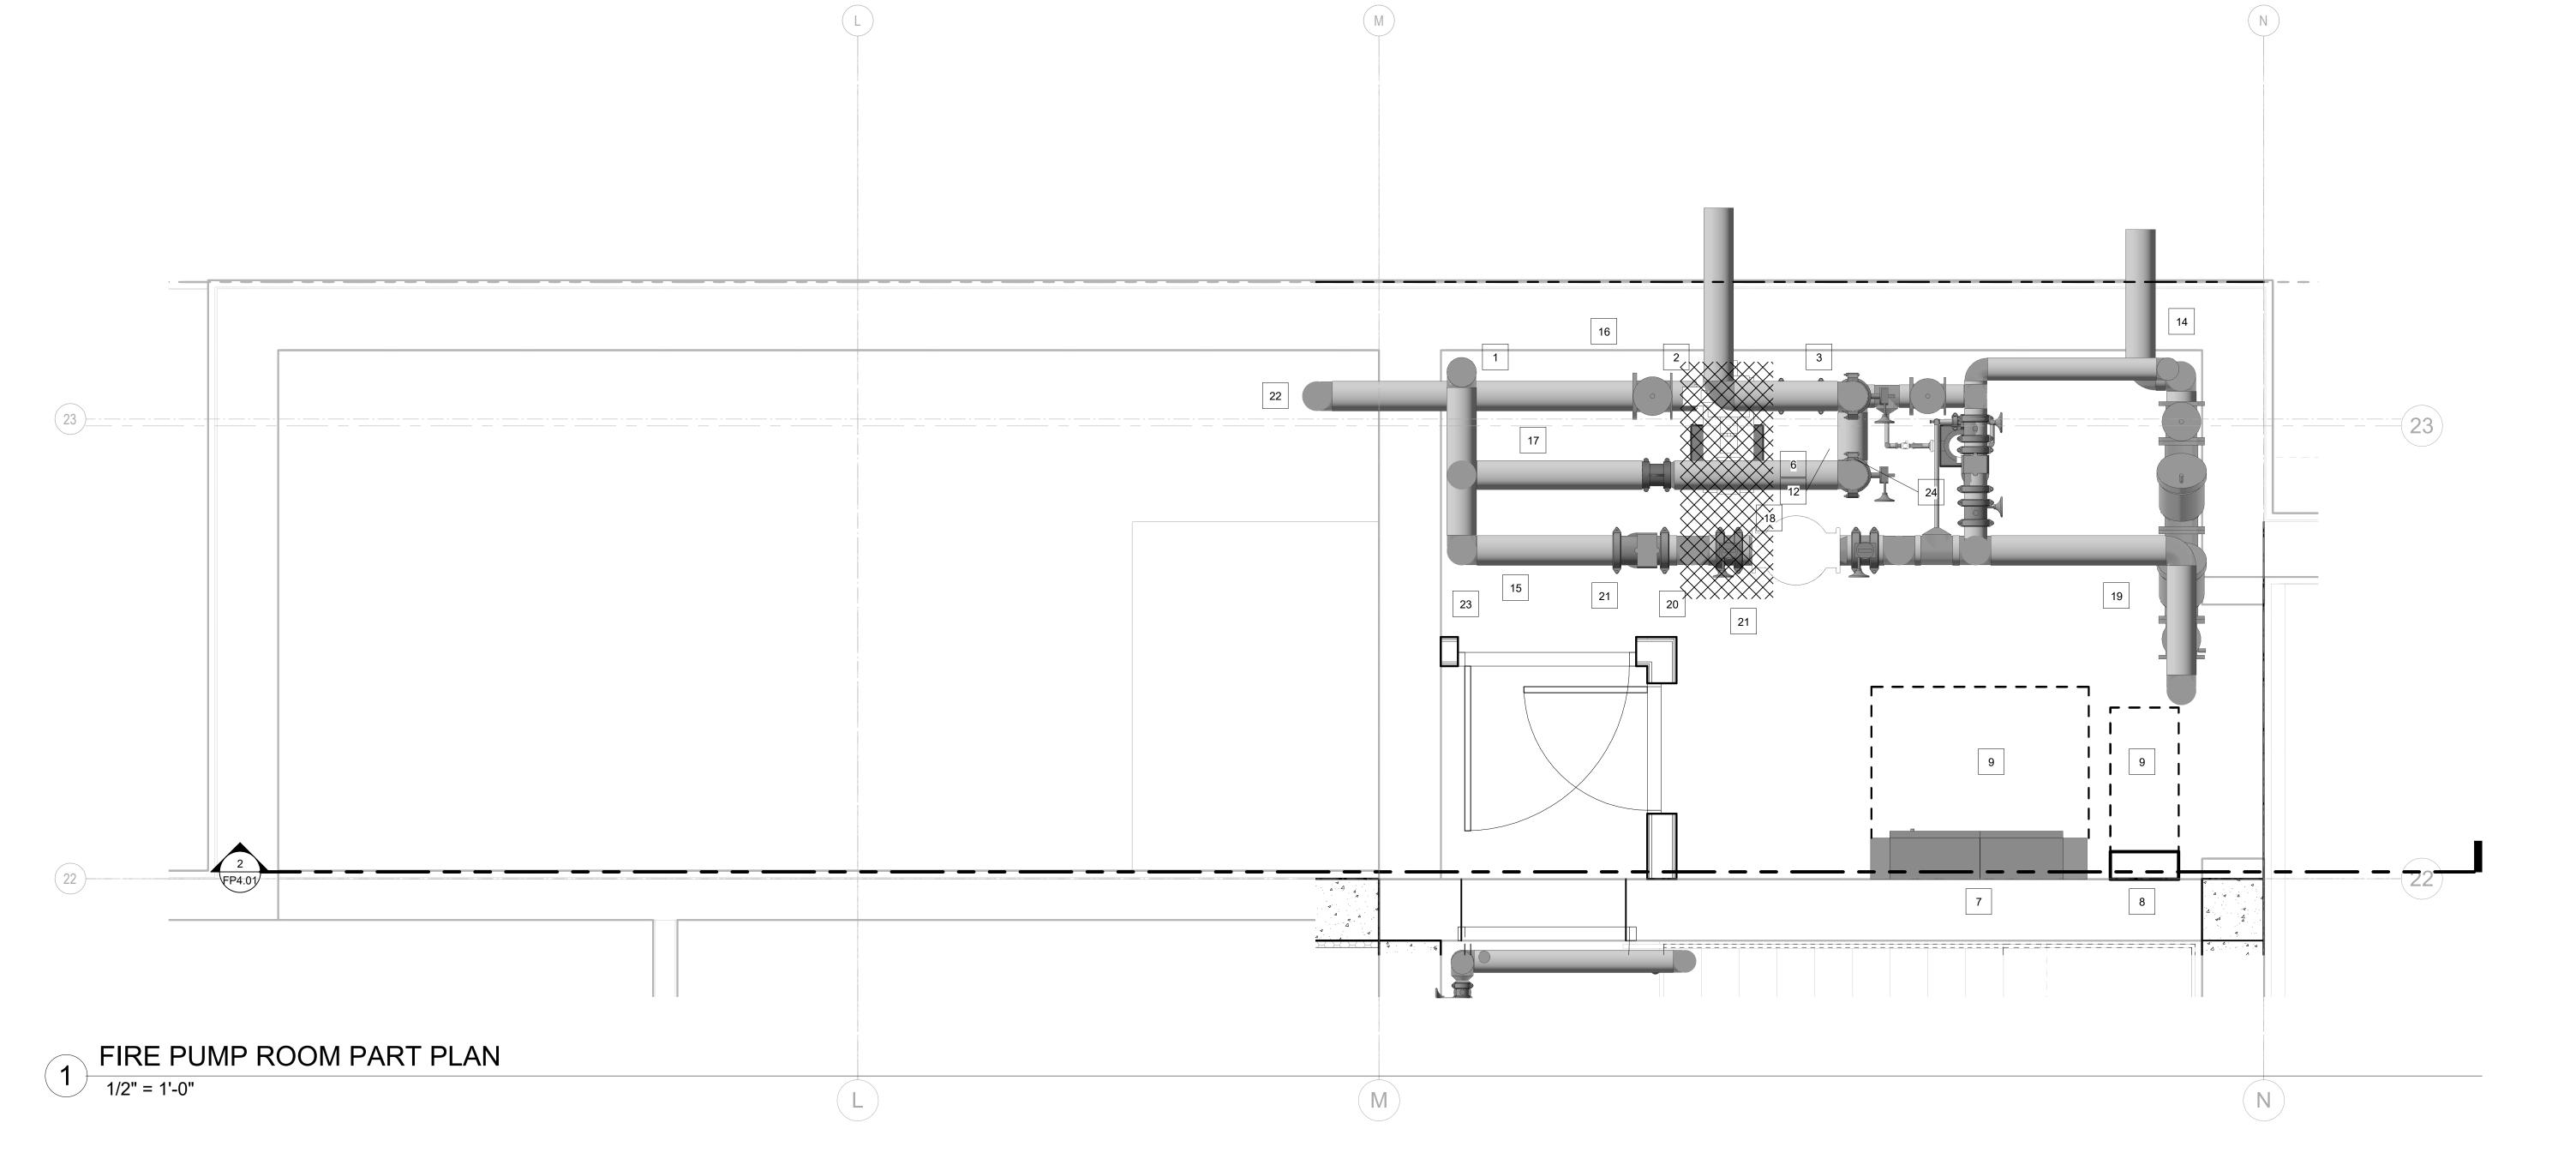

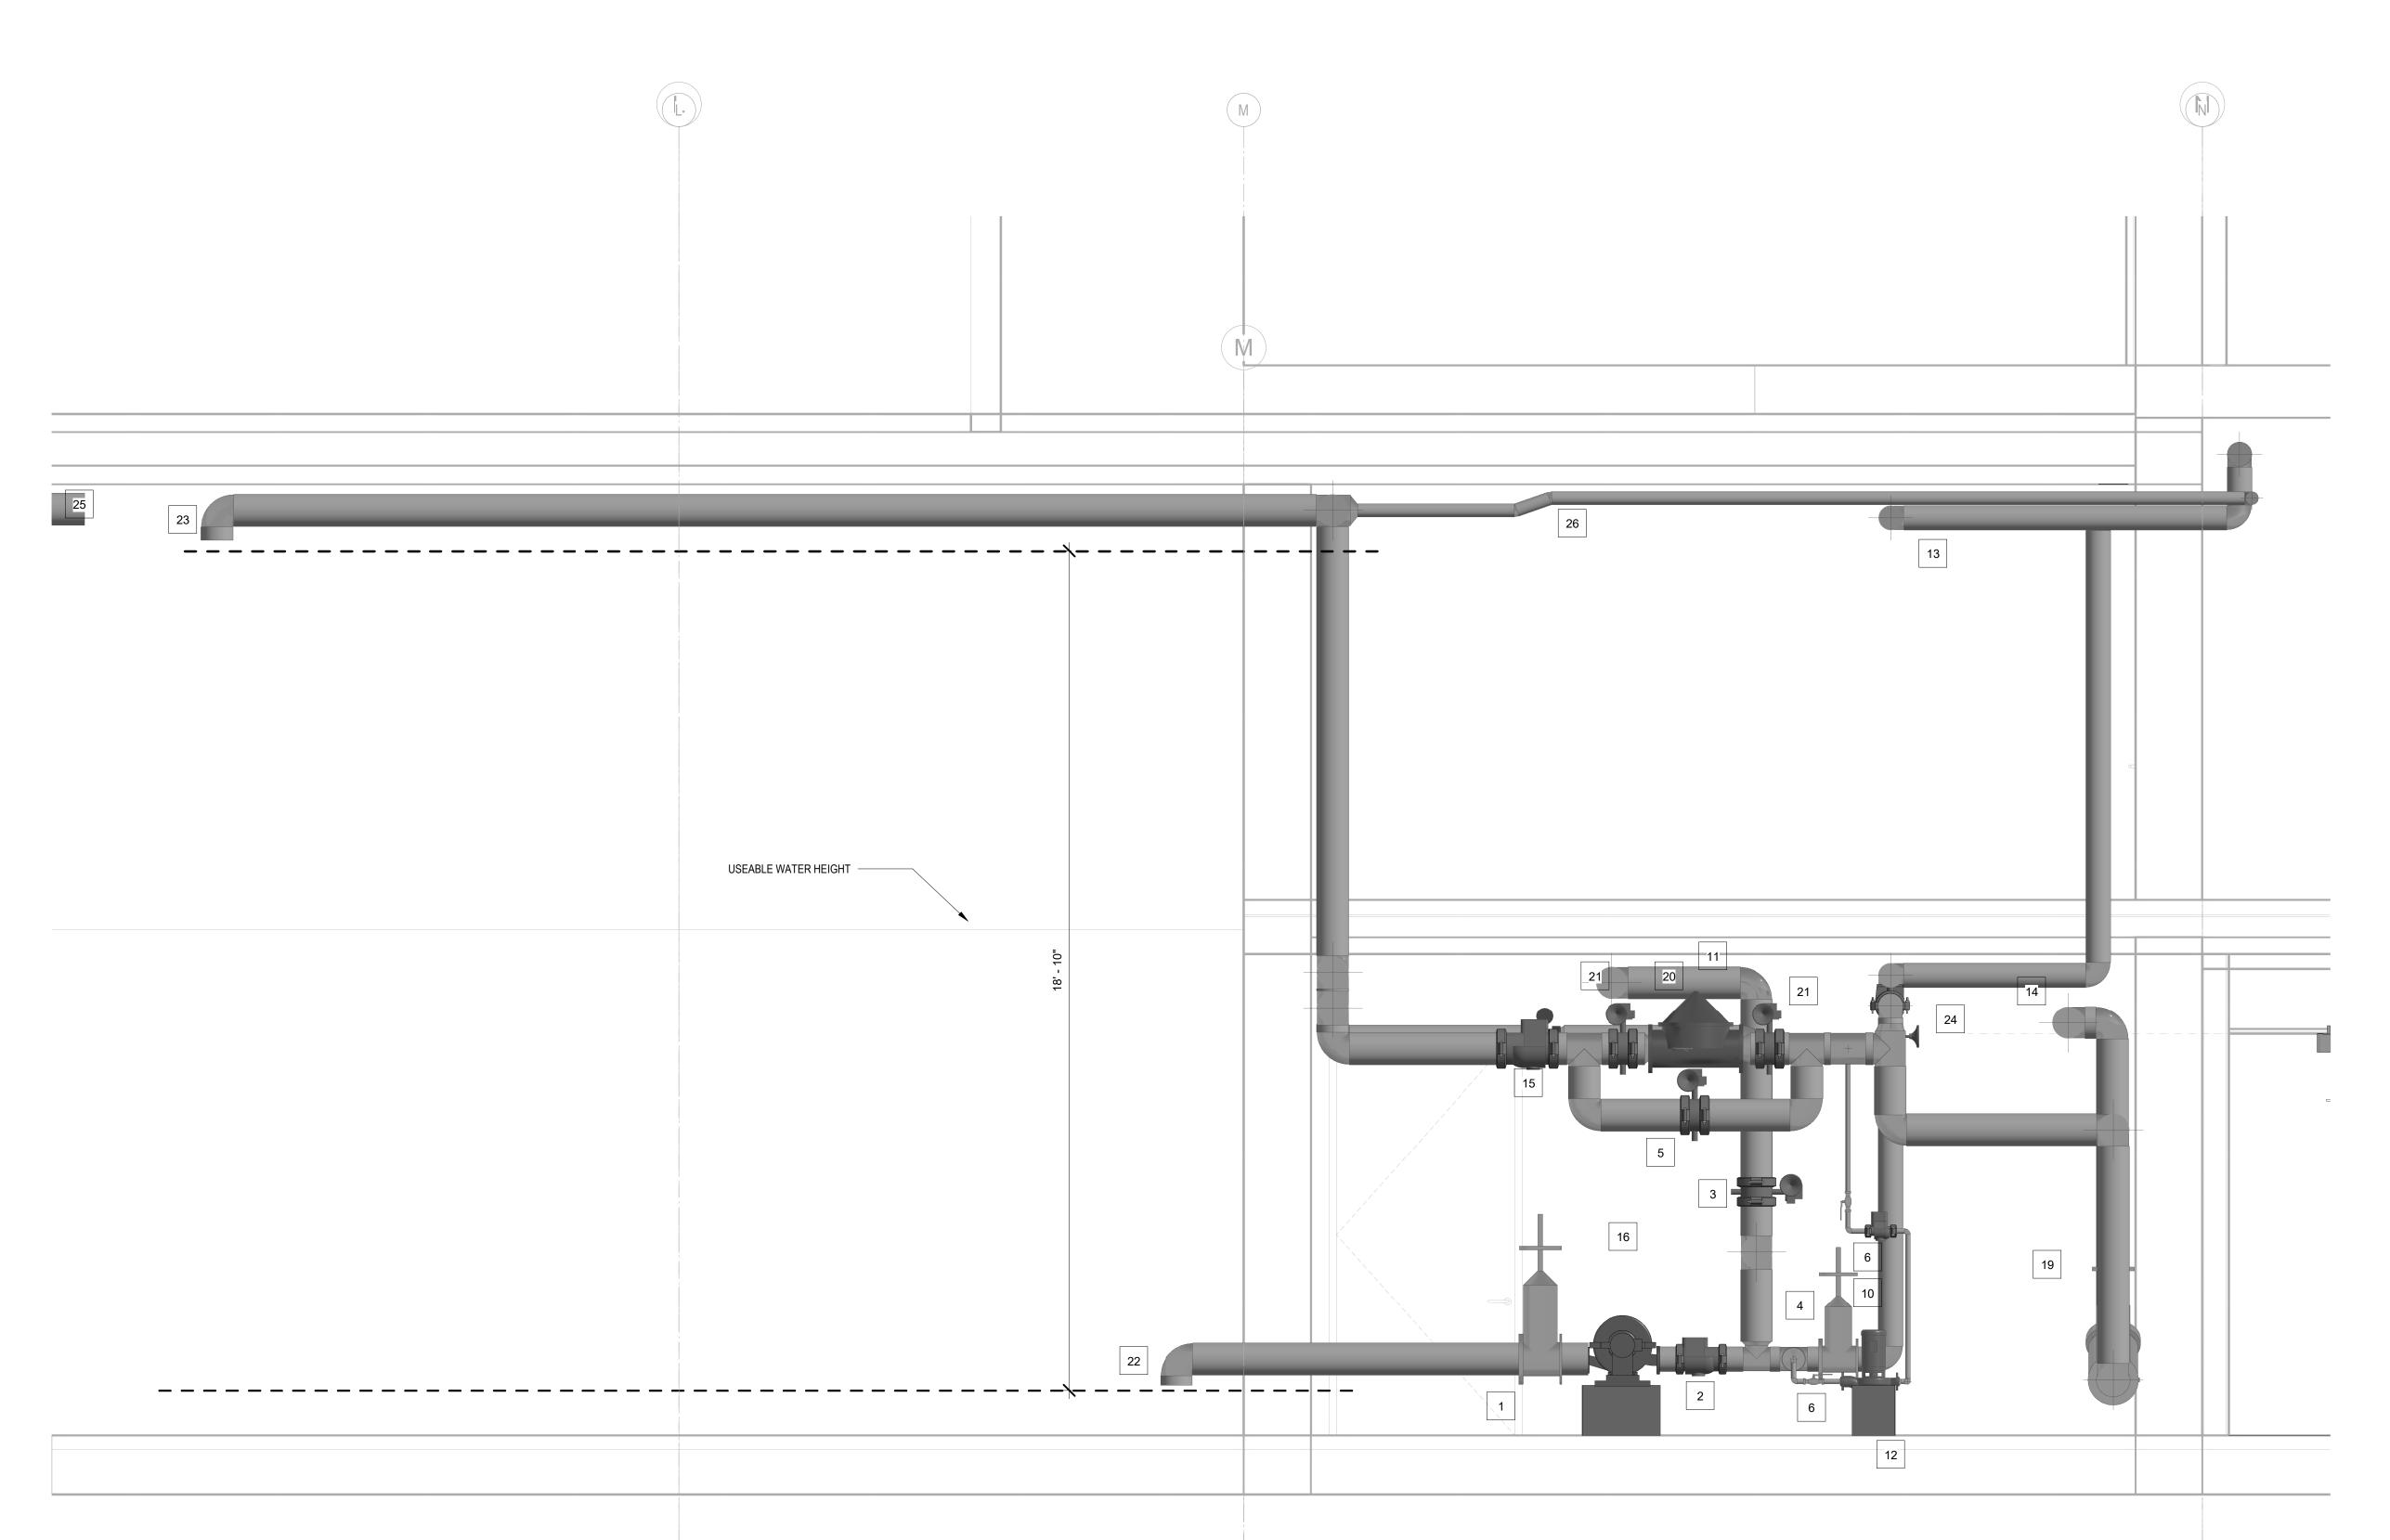

FIRE PUMP EQUIPMENT LIST						
1 8" OS&Y GATE VALVE (TANK ISOLATION)	8" WFM FROM INCOMING FIRE WATER SERVICE					
2 6" CHECK VALVE (FIRE PUMP DISCHARGE)	15 8" CHECK VALVE					
3 8" NC BUTTERFLY VALVE (FIRE PUMP TEST)	16 ELECTRIC DRIVE FIRE PUMP (FP-1) HATCH SHOWS FIRE PUMP FOOTPRINT					
6" OS&Y GATE VALVE W/ ELECTRONIC ACTUATOR BAS OF DESIGN KENNEDY MODEL 8561ASS-2DMG-1	S 8" FLOW METER					
(FIRE PUMP DISCHARGE) 5 8" NC BYPASS VALVE	18 8" NC BUTTERFLY VALVE (FLOW METER ISOLATION)					
6 BALL VALVE (PMP)	8" DOUBLE CHECK VALVE ASSEMBLY					
7 FIRE PUMP CONTROLLER W/ ATS	8" FLOAT VALVE (TANK FILL); PROVIDE 120 VAC WATER LEVEL MONITORING PANEL WITH LOW LEVEL AND HIGH LEVEL ALARMS.					
8 PRESSURE MAINTENANCE PUMP CONTROLLER	21 8" BUTTERFLY VALVE (FLOAT VALVE ISOLATION)					
9 NEC REQUIRED 42" WORKING CLEARANCE	22 8" TANK SUCTION W/ ANTI-VORTEX PLATE (NOT SHOWN)					
10 CHECK VALVE (PRESSURE MAINTENANCE PUMP DISCH	IARGE) 23 8" UP TO TANK FILL					
11 8" TH TO FIRE PUMP TEST HEADER (EXACT LOCATION	TBD) 24 6" BYPASS ASSEMBLY					
12 ELECTRIC DRIVE PRESSURE MAINTENANCE PUMP (PM	P-1) 8" TANK OVERFLOW TO STORM					
13 6" WFM TO MAIN DISTRIBUTION	26 STANDPIPE DRAIN RETURN TO TANK					

DRAWING FUNCTION		PUMP TYPE BASIS OF DESIGN	RE PUMP SCHEDU CAPACITY	BOOST	CHURN	ELECTRICAL					SET POINTS		
DESIGNATION		PERMORANCE CURVE (GPM) (PSI)	(PSI)	HP	V	PH	HZ	RPM	START	STOF			
FP-1	FIRE PUMP	HORIZONTAL SPLIT CASE	PEERLESS 5AEF12	1,000	190	212	200	208	3	60	3,550	200	MANU
PMP-1	PRESSRUE MAINTENANCE PUMP	VERTICAL INLINE		10	200	-	3	208	3	60	3,560	205	215

Reserved for permit stamp

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____ principal architect_____ project manager__JCC_____ drawn by__CRB, SMK____ ____ checked by Checker job no. 20052 date 11/18/2022

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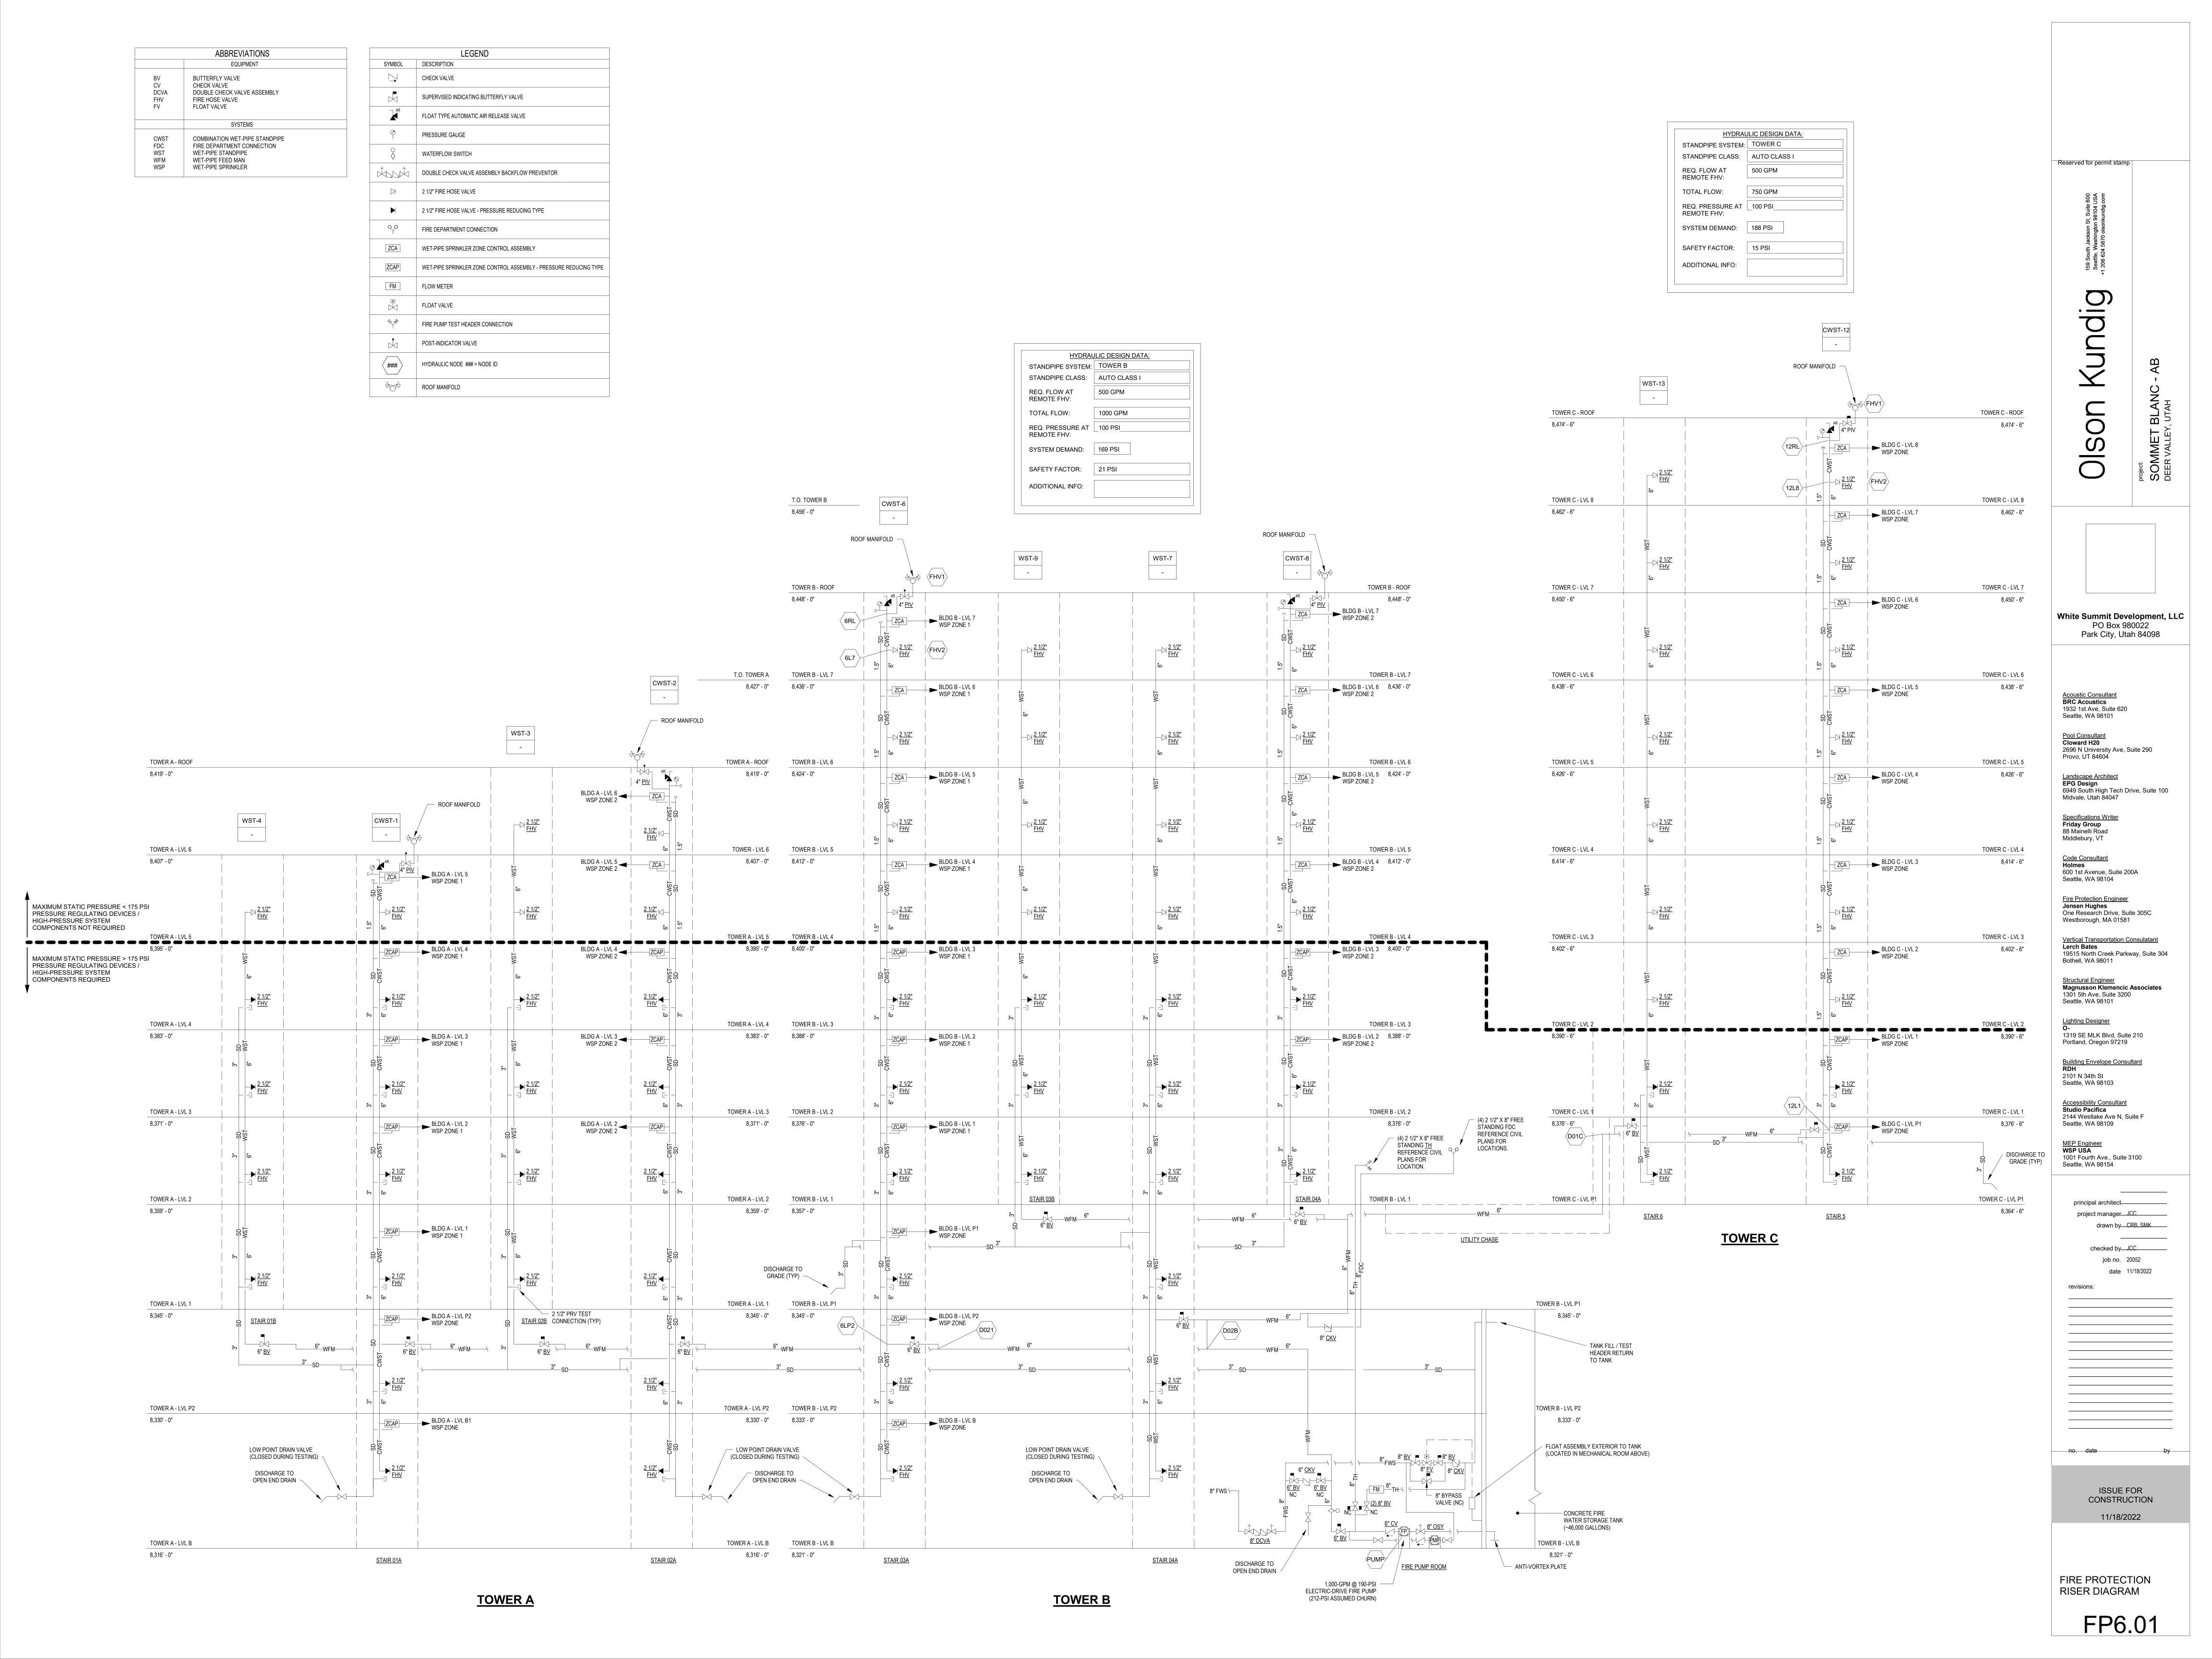
FIRE PUMP ROOM -ENLARGED PLAN & SECTIONS


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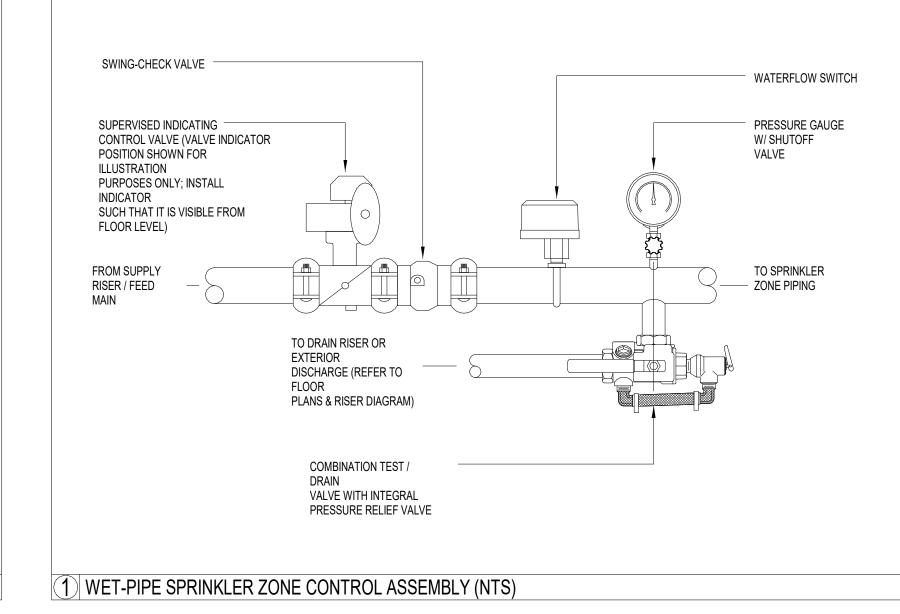
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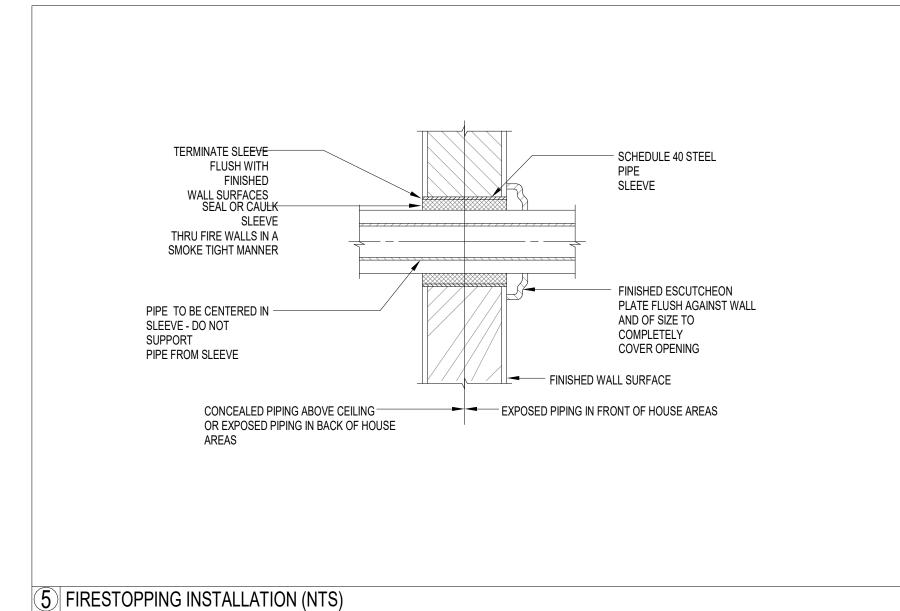
FIRE PUMP ROOM SECTION 1


1/2" = 1'-0"








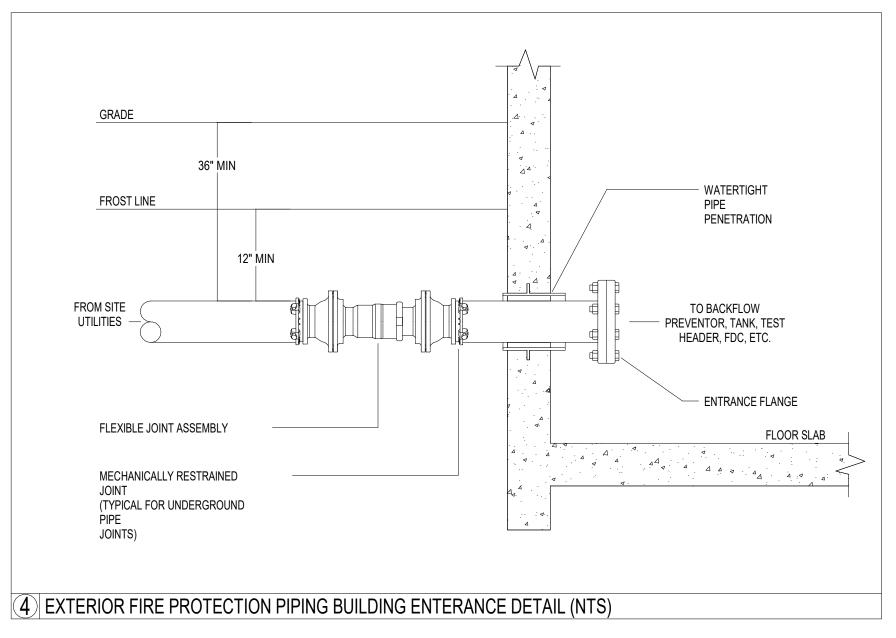

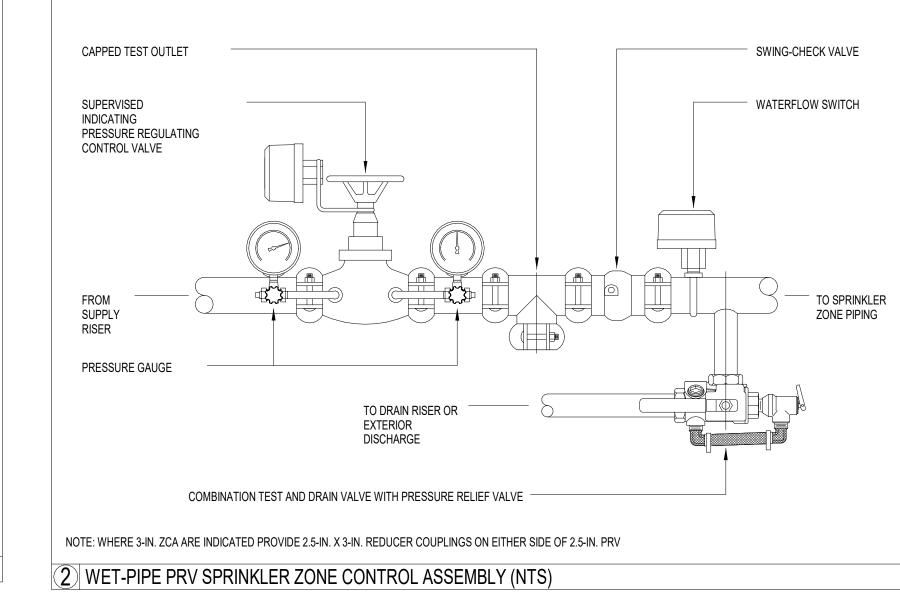

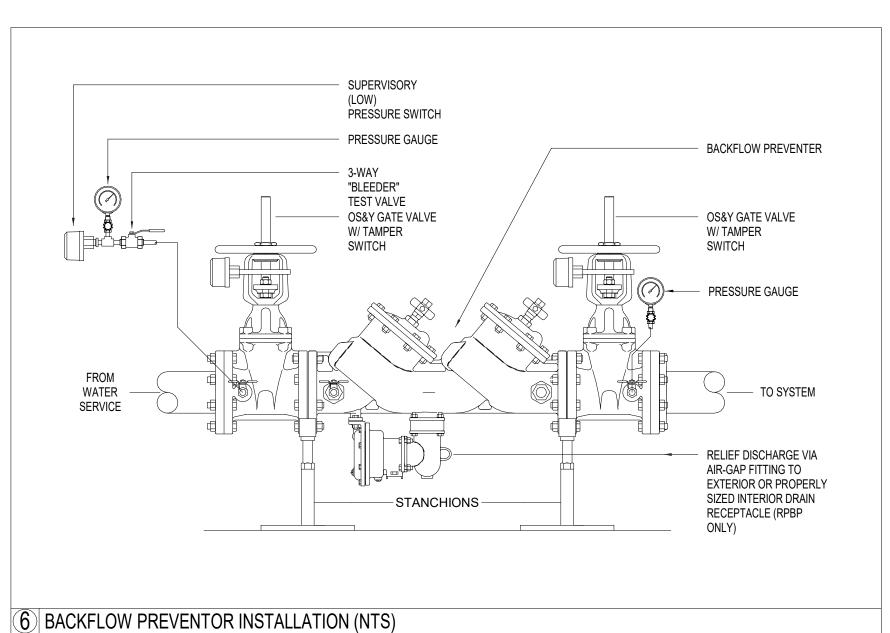

300 PSI RATED

CONNECTION FLANGE

PITCH PIPING BACK TO BUILDING ENTERANCE

STRAIGHT PATTERN -

FDC OR TEST HEADER

BURIED PIPING

(SEE CIVIL -DRAWINGS)

7 EXTERIOR CONNECTION (NTS)

10"

FIRE DEPARTMENT CONNECTION

STREET ADDRESS

GALVANIZED UNISTRUT

SUPPORTS

PRESSURE REQUIRED


MECHANICALLY RESTRAINED


JOINT (TYPICAL FOR

UNDERGROUND PIPE

PROVIDE SIMILAR

→ SIGNAGE FOR TEST

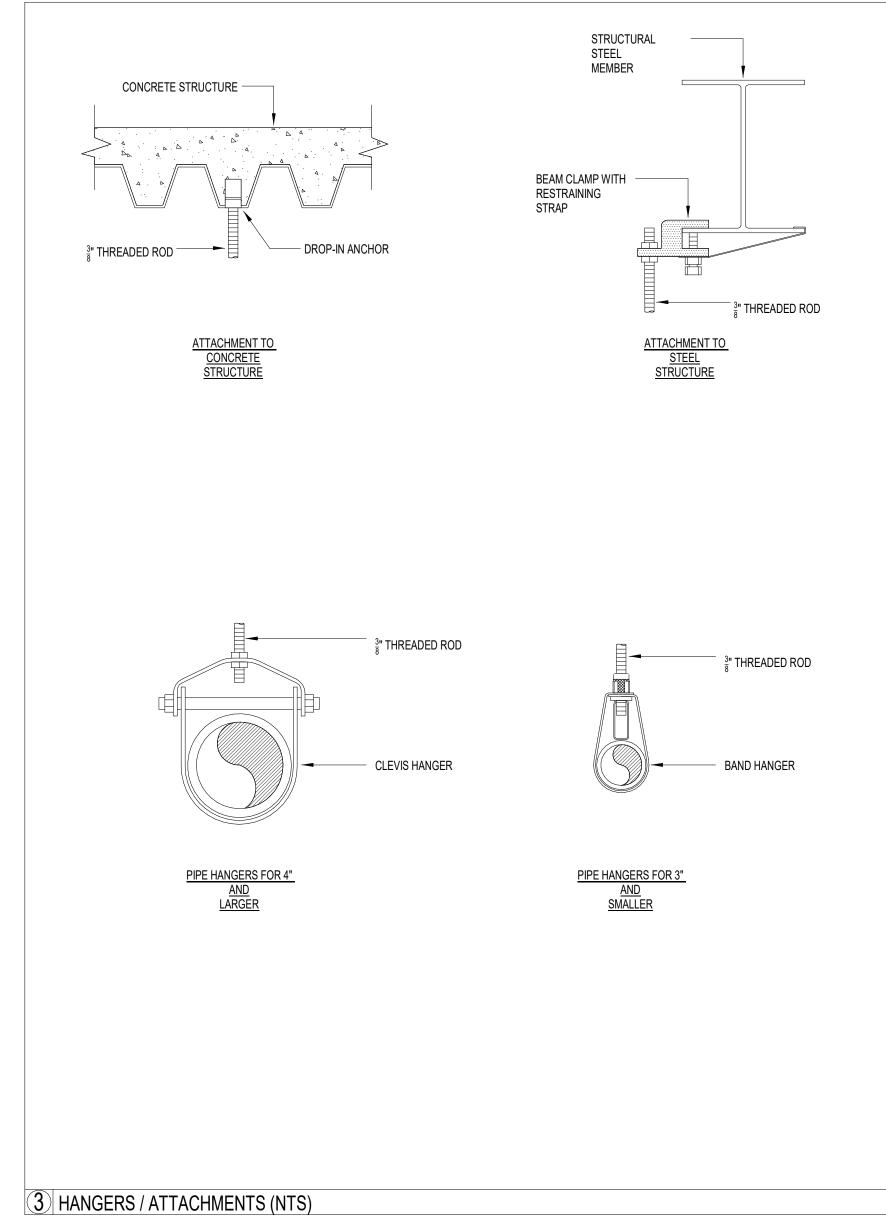

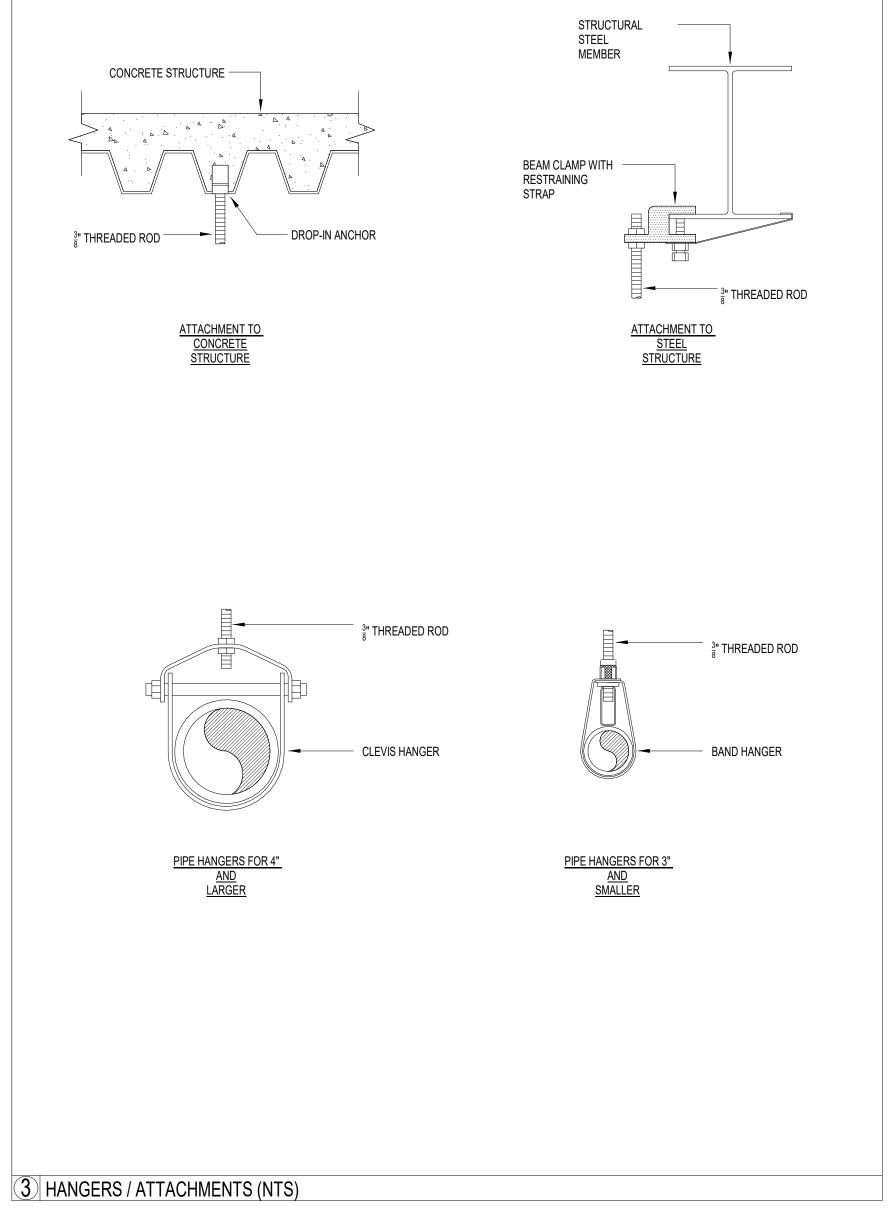

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WSP USA 1001 Fourth Ave., Suite 3100 Seattle, WA 98154 principal architect_____ project manager__JCC____ drawn by__CRB, SMK____ ____ checked by Checker job no. 20052 date 11/18/2022 revisions: no. date by ISSUE FOR CONSTRUCTION 11/18/2022

FIRE PROTECTION

FP7.01

DETAILS

Building Envelope Consultant RDH

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